

#1749641 GPC Reference: DA2021/05/01 Your Reference:509751

27 April 2022

Sugar Terminal Limited c/- Aurecon, Kate Large PO Box 1060 MACKAY QLD 4740

Dear Ms Large

DECISION NOTICE – APPROVAL WITH CONDITIONS – DA2021/05/01

(GIVEN UNDER SECTION 63 PLANNING ACT 2016)

1. Application Details

This development application was **properly made** to the Gladstone Ports Corporation Limited on **17 August 2021** and changed (change other) on **27 October 2021** and (minor changes) **21 March 2022** and **28 March 2022**.

Application Number:	DA2021/05/01
Applicant Name:	Sugar Terminal Limited
Applicant Contact Details:	Kate Large Aurecon PO Box 1060 MACKAY QLD 4740 Email: Kate.Large@aurecongroup.com
Approvals Sought (Land Use Plan):	 Material change of use for loading and unloading infrastructure and activities (Common User Infrastructure) Operational work involving excavating and filling Operational work involving engineering work or landscaping work associated with a material change of use Operational work that is tidal work
Approval Sought (SARA - SDAP):	5. Material change of use for Environmentally Relevant Activities - ERA 50 (1a and 2)6. Operational work that is tidal work or work in a coastal management district
Details of Proposed Development:	Common User Infrastructure project
Location Street Address:	46 Wharf Drive BURNETT HEADS QLD 4670



Location Real Property Description:	Lot 3 on SP133687, Lot 501 on SP279707, Lot 2 on SP137256, Lot 276 on SP128643, Lot 1 on SP308111 and Lot 1 on RP122698			
Land Owner:	Gladstone Ports Corporation Limited Department of Resources			
Land Use Plan Precinct:	Strategic Port Land – Port Industry Precinct and Wharves Precinct			

2. Details Of Proposed Development

Installation of Common User Infrastructure for the purpose of loading vessels at Sir Thomas Hiley Wharf with dry bulk materials e.g. grain, ilmenite, silica sand, woodchip etc. The infrastructure includes conveyors, transfer towers, galleries, modifications to exist ship loading equipment for new products including new chute.

3. Details Of Decision

This development application was decided on 27 April 2022.

This development application is **approved in full with conditions**. These conditions are set out in Attachment 1 and are clearly identified to indicate whether the assessment manager or a concurrence agency imposed them.

This application **is not** taken to have been approved (a deemed approval) under section 64(5) of the *Planning Act 2016*.

4. Details Of Approval

This development approval is a **Development Permit** given for:

- (a) Material Change of Use for Loading and Unloading infrastructure and activities (Common User Infrastructure)
- (b) Operational work that is tidal works, where not excluded tidal works
- (c) Operational works involving excavating and filling
- (d) Operational work involving engineering work or landscaping work associated with a material change of use
- (e) Material Change of Use for Environmentally Relevant Activity Bulk Material Handling within 5km of a waterway;
- (f) Operational work that is tidal work or work in a coastal management district

5. Conditions

This development approval is subject to the conditions in Attachment 1 - Part 1 and Part 2.



6. Further Development Permits

Please be advised that the following development permits are required to be obtained before the development can be carried out:

- (a) Operational work involving placing an advertising device on premises, where not in the Marina precinct or Wharves precinct;
- (b) Operational work involving placing an advertising device on premises, where in the Marina precinct or Wharves precinct;
- (c) Any approvals for building works;
- (d) Any approvals for plumbing and drainage works;
- (e) Any Operational works that is tidal works for stormwater/ drainage infrastructure, where not excluded works

7. Referral Agencies for the Application

The referral agencies for this application are:

For an application involving	r an application involving Name of referral agency	
Planning Regulation 2017 – (a) Material Change of Use for Environmentally Relevant Activity - Bulk Material Handling within 5km of a waterway (<i>Planning Regulation 2017</i> reference Schedule 10, part 5, division 2);	State Assessment Referral Agency - Department of State Development, Infrastructure, Local Government and Planning	Wide Bay Burnett State Assessment Referral Agency (SARA) PO Box 979 BUNDABERG QLD 4670 WBBSARA@dsdmip.qld.gov.au
(b) Operational work that is tidal works or work in a coastal management district (<i>Planning Regulation 2017</i> reference Schedule 10, part 17, division 3, table 1); and		
(c) Operational work that is tidal works or work in a coastal management district (<i>Planning Regulation 2017</i> reference Schedule 10, part 17, division 3, table 2).		

(d) Environmental Authority

Environmentally Authority No. P-EA-100147468 for:

- ERA 50 Mineral and bulk material handling 2 Loading or unloading 100t or more of bulk materials in a day, other than loading or unloading mentioned in item 3, or storing bulk materials; and
- ERA 50 Mineral and bulk material handling 1(1) Loading or unloading 100t or more
 of minerals in a day, other than loading or unloading mentioned in item 3, or storing
 50,000t or more of minerals within 5km of the highest astronomical tide or 1km of a
 watercourse.



(e) Approved Plans and Specifications

Copies of the following plans, specifications and/or drawings are approved and enclosed in Attachment 2:

Drawing/report title	Prepared by	Date	Reference no.	Version	Approval subject to the following changes
Aspect of developme	ent: Material	Change of Us	e and Operational we	orks (Land	l Use Plan)
Overall site layout plan - Stage 1A	Linear Engineering	06/10/21	255220-C-002	Е	
Site layout plan - Stage 1A	Linear Engineering	06/10/21	255220-C-003	E	
Bulk earthworks layout plan - Stage 1A	Linear Engineering	06/10/21	255220-C-004	С	
Bulk earthworks sections - Stage 1A	Linear Engineering	06/10/21	255220-C-005	С	
Bulk Earthworks Layout Plan – Stage 1A	Linear Engineering	30/06/21	255220-C-101	А	
Overall site layout plan – Stage 1B	Linear Engineering	06/10/21	255220-C-102	С	
Site layout plan – Stage 1B	Linear Engineering	06/10/21	255220-C-103	С	As amended 27/04/22
Bulk earthworks layout plan	Linear Engineering	06/10/21	255220-C-104	С	As amended 27/04/22
Bulk earthworks sections – Stage 1B	Linear Engineering	06/10/21	255220-C-105	С	
Bulk earthworks layout plan – Stage 1B	Linear Engineering	30/06/21	255220-C-121	А	
Bulk Earthworks – Stage 1B	Linear Engineering	30/06/21	255220-C-131	А	
Fencing arrangement - Sheet 1	Linear Engineering	24/09/21	255200-G-008	В	
Fencing arrangement - Sheet 2	Linear Engineering	24/09/21	255200-G-009	B (A)	
Chainwire security fencing	Linear Engineering	24/09/21	255000-S-029	А	
Services - Potable water arrangement	Linear Engineering	06/09/21	255210-P-011	А	
Services - Potable water details	Linear Engineering	06/09/21	255210-P-012	А	As amended 27/04/22
Services - Fire systems arrangement	Linear Engineering	11/08/21	255200-P-014	А	
Services - Fire systems details	Linear Engineering	31/08/21	255200-P-015	А	



New conveyors – General Arrangement Plan	Linear Engineering	30/08/21	255200-G-003	В	
New conveyors - Existing underground services	Linear Engineering	30/08/21	255200-G-004	В	
New conveyors - Data sheet	Linear Engineering	20/07/21	255200-M-010	С	
Conveyor hardstand and layout plan – Stage 1A	Linear Engineering	06/10/21	255220-C-007	E	
Conveyor hardstand and pavement longitudinal section	Linear Engineering	06/10/21	255220-C-008	С	
Conveyor hardstand and layout plan	Linear Engineering	06/10/21	255220-C-107	A	
Conveyor hardstand and pavement longitudinal section	Linear Engineering	06/10/21	255220-C-108	С	
Conveyor Hardstand and Pavement Layout plan – Stage 1A	Linear Engineering	30/06/21	255220-C-201	С	
Conveyor Hardstand and Pavement Layout plan – Stage 1B	Linear Engineering	30/06/21	255220-C-221	A	
Yard conveyor 1 - General arrangement sheet 1 of 2	Linear Engineering	30/08/21	255230-M-030	В	
Yard conveyor 1 - General arrangement sheet 1 of 2	Linear Engineering	30/08/21	255230-M-031	В	
Cross conveyor 1 - General arrangement	Linear Engineering	30/08/21	255240-M-050	В	
Stormwater catchment plan – Stage 1A	Linear Engineering	06/10/21	255220-C-010	D	
Stormwater drainage layout plan – Stage 1A	Linear Engineering	06/10/21	255220-C-011	G	As amended 27/04/22
Stormwater drainage long sections - Stage 1A	Linear Engineering	06/10/21	255220-C-012	В	
Stormwater drainage calculations tables - Stage 1A	Linear Engineering	06/10/21	255220-C-013	В	
Stormwater pond layout plan - Stage 1A	Linear Engineering	06/10/21	255220-C-014	D	
Stormwater catchment plan – Stage 1B	Linear Engineering	06/10/21	255220-C-110	С	
Stormwater drainage layout plan – Stage 1B	Linear Engineering	06/10/21	255220-C-111	С	
Stormwater pond layout plan - Stage 1B	Linear Engineering	06/10/21	255220-C-114	С	



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Stormwater management plan - General arrangement	Linear Engineering	29/07/21	21255-SK-001	С	
Yard conveyor cross sections - Sheet 1	Linear Engineering	29/07/21	21255-SK-002	С	
Stormwater management plan schematic	Linear Engineering	29/07/21	21255-SK-004	С	As amended 27/04/22
Substation 5 - High voltage reticulation - Site layout drawing	Linear Engineering	03/09/21	255290-E-030	В	
Aspect of developme	ent: Operatio	nal Work that	t is Tidal Work (Land	Use Plan)	
Conveyor C6 to C7 Transfer - Strengthening Works	Linear Engineering	15/10/21	255250-M-071	0	
Conveyor C7 - Tail End Skirt Modifications	Linear Engineering	15/10/21	255250-M-072	0	
Conveyor C6 to C7 Transfer - Chute Insert Modifications	Linear Engineering	15/10/21	255250-M-073	0	
Conveyor C7 to C10 Transfer - Chute Insert Modifications	Linear Engineering	15/10/21	255250-M-075	0	
Conveyor C10 to C11 Transfer - Chute Insert Modifications	Linear Engineering	15/10/21	255250-M-078	0	
Shiploader - Ilmenite telechute - General arrangement and operating range	Linear Engineering	15/10/21	255260-M-081	0	
Shiploader - Sugar telechute modifications - General arrangement and operating range	Linear Engineering	15/10/21	255260-M-082	0	
Shiploader - Conveyor C11 Head Chute - New Deflector General Arrangement	Linear Engineering	15/10/21	255260-M-084	0	
Shiploader - Conveyor C11 Head Chute - New Deflector Details	Linear Engineering	15/10/21	255260-M-085	0	
Shiploader - Conveyor C11 Head Chute - Modifications Head Chute Top Details	Linear Engineering	15/10/21	255260-M-086	0	
Shiploader - Conveyor C11 Head Chute Lower - Lower Chute Modifications Details	Linear Engineering	15/10/21	255260-M-087	0	
Shiploader - Conveyor C11 Head Chute - Hydraulic Maintenance Platform Details	Linear Engineering	15/10/21	255260-M-088	0	



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Shiploader - Telechute Ilmenite & Sugar - Winch Platform General arrangement	Linear Engineering	15/10/21	255260-M-089	0	
Shiploader - Telechute Ilmenite & Sugar - Winch Details and Rope Reeving General Arrangment	Linear Engineering	15/10/21	255260-M-090	0	
Shiploader - Telechute Ilmenite & Sugar - Chute Support and Change Mechanism Details	Linear Engineering	15/10/21	255260-M-091	0	
Shiploader - Telechute Ilmenite & Sugar - Platform Mounted Guide Details	Linear Engineering	15/10/21	255260-M-092	0	
Shiploader - Telechute Ilmenite & Sugar - Winch Platform Structure Details Sheet 1	Linear Engineering	15/10/21	255260-M-093	0	
Shiploader - Telechute Ilmenite & Sugar - Winch Platform Structure Details Sheet 2	Linear Engineering	15/10/21	255260-M-094	0	
Shiploader - Telechute Ilmenite & Sugar - Winch Platform Structure Details Sheet 3	Linear Engineering	15/10/21	255260-M-095	0	
Shiploader - Telechute Ilmenite - General Arrangement	Linear Engineering	15/10/21	255260-M-096	0	
Shiploader - Telechute Ilmenite - Chute Cans Details	Linear Engineering	15/10/21	255260-M-097	0	
Shiploader - Telechute Ilmenite - Slew Assembly Details	Linear Engineering	15/10/21	255260-M-098	0	
Shiploader - Telechute Ilmenite & Sugar - Spoon Chute Detail	Linear Engineering	15/10/21	255260-M-100	0	
Shiploader - Telechute Ilmenite & Sugar - Sheave Support Frame Details	Linear Engineering	15/10/21	255260-M-102	0	
Shiploader - Telechute Ilmenite & Sugar - Supprt Ring & Guides Details	Linear Engineering	15/10/21	255260-M-103	0	



12. Currency Period for the Approval

Pursuant to section 85 of the Planning Act, this development approval will lapse at the end of the periods set out below:

- (a) For Material Change of Use this approval lapses if the first change of use does not happen within 6 years after the approval has effect.
- (b) For all other approvals excluding Reconfiguring a Lot, the approval lapses if the development does not substantially start within 2 years of this approval taking effect.

(f) Rights of Appeal

The rights of applicants to appeal to a tribunal or the Planning and Environment Court against decisions about a development application are set out in chapter 6, part 1 of the *Planning Act 2016*. For particular applications, there may also be a right to make an application for a declaration by a tribunal (see chapter 6, part 2 of the *Planning Act 2016*).

Attachment 3 is an extract from the *Planning Act 2016* that sets down the applicant's appeal rights and the appeal rights of a submitter.

For further information please contact the undersigned on 07 4976 1287 or via email planning@gpcl.com.au.

Yours sincerely,

Erin Clark Principal Planner

Cc: WBBSARA (Department of State Development, Infrastructure, Local Government and Planning)

Bundaberg Regional Council Office of Coordinator General

Enc. Attachment 1: Conditions of Approval

Part 1 – Conditions imposed by the assessment manager Part 2 – Conditions required by the referral agency response

(Department of State Development, Infrastructure, Local Government

and Planning - 28/2/2022)

Attachment 2: Approved plans and specifications

Attachment 3: Extract of appeal provisions



Attachment 1 Conditions of Approval

PART 1: ASSESSMENT MANAGER CONDITIONS

In general the development proposal is in compliance with the requirements of Gladstone Ports Corporation Limited (GPC). This development approval is subject to each the following conditions which are stated by GPC, the Assessment Manager.

Part 1a: Approval sought under Planning Act 2016 – Material Change of Use and Operational works on Strategic Port Land and tidal areas

GENERAL

- 1. Development must be carried out generally in accordance with the Approved plans, except where modified by conditions of this permit.
- 2. Unless otherwise stated, all conditions must be complied with and completed prior to the commencement of the development.
- 3. Where additional "approval" is required under these conditions by the Assessment Manager (GPC) for drawings or documentation the proponent must submit for review, amend to the satisfaction of, and obtain written approval from the Assessment Manager.

Furthermore, where additional approval is required "prior to works commencing", for "amendments" or as otherwise required in this Decision, the Assessment Manager will require no less than the following assessment periods, or as agreed in writing by the proponent and Assessment Manager, to initially assess the drawings or documentation submitted:

- a. 15 business days for management plans;
- b. 10 business days for proposals, including engineering drawings or further details.

Should further information be required for assessment, the Assessment Manager will require a further 5 business days to complete the information request / amendment assessment and response.

Works are not to commence and are not deemed approved until any additional drawings or documents have been approved in writing by the Assessment Manager.

4. The proponent must at its cost and expense, keep and maintain the development footprint, including existing services, in a state that is satisfactory to the Assessment Manager.

Amended Plans

- 5. Prior to the submission of an Operational Works, Building work application, or commencement of use for Stage 1A, whichever comes first, submit to and have approved by the Assessment Manager, amended drawings/plans and/or documents which incorporate the following relevant to that stage:
 - a. Demonstration of no adverse physical or environmental nuisance from air emissions from loading activities to adjoining port land;
 - Demonstration of no adverse physical or environmental contamination from uncontrolled emergency water discharges or washdown water discharges to adjoining port land. The proponent must consider in this solution that where any emergency release of any product to adjoining land must be rectified to the satisfaction of the Assessment Manager;
 - Stormwater drainage layout plan to demonstrate formalised stormwater management as per relevant conditions contained in this Approval;
 - d. Pond construction and maintenance;
 - e. Water capture and irrigation infrastructure;
 - f. Washdown water and stormwater quality monitoring and provision of monitoring results to Assessment Manager upon request; and



Details of materials and external finishes and colouring.

Once approved, the amended plans will form part of the Approved plans.

- 6. Prior to the submission of an Operational Works, Building work application, or commencement of use for Stage 1B, whichever comes first, submit to and have approved by the Assessment Manager amended and updated drawings/plans and/or documents which incorporate the following relevant to that stage:
 - a. Details of stormwater connection to Buss Street stormwater system and pond emergency spillway to Buss Street including agreement from Bundaberg Regional Council;
 - Details of vehicle access to Buss Street including agreement from Bundaberg Regional Council;
 - c. Demonstration of no adverse physical or environmental nuisance from air emissions from loading activities to adjoining port land;
 - d. Demonstration of no adverse physical or environmental contamination from uncontrolled emergency water discharges or washdown water discharges to adjoining port land. The proponent must consider in this solution that where any emergency release of any product to adjoining land must be rectified to the satisfaction of the Assessment Manager;
 - e. Pond construction and maintenance;
 - f. New or additional water capture and irrigation infrastructure;
 - g. Location and engineering detail of all services and related infrastructure, including but not limited to water, power and fire systems;
 - h. Washdown water and stormwater quality monitoring and provision of monitoring results to Assessment Manager upon request;
 - i. Details of materials and external finishes and colouring.
 - j. All structural components and construction details of the stage.

Once approved, the amended plans will form part of the Approved plans.

ENGINEERING & PLANNING

- 7. Prior to works commencing for the relevant stage, the proponent must supply to the Assessment Manager for approval 100% design 'for construction' plans in electronic CAD format which illustrate all infrastructure and services installed on, under or over Port land associated with the development. The drawings must include, but not be limited to:
 - a. Relocated Telstra fibre cable:
 - b. New potable water pipelines;
 - c. Electrical and Mechanical infrastructure;
 - d. Fire water source connections:
 - e. Relocated and new high voltage power infrastructure and associated transformers and motor control centre room.
- 8. Upon completion of the works, the proponent must supply the Assessment Manager with the full suite of project RPEQ certified "as constructed" plans in electronic CAD format which illustrate all infrastructure and services installed on, under or over Port land associated with the development, including tidal works.
- 9. Prior to the use commencing, the proponent must certify in writing to the Assessment Manager that the development is constructed as per design and that the development has been constructed generally in accordance with the Approved plans.
- 10. Loading and unloading activities associated with exporting bulk materials and minerals under this Decision Notice are limited to the following products:



a. Minerals

- Silica sand
- Ilmenite
- Kaolin
- Feldspar
- Gypsum
- Other minerals of similar properties and characteristics, including density, odour, toxicity and dust output, where approved in writing by the Assessment Manager.

b. Materials

- Maize
- Corn
- Sorgham
- Feed grains
- Wood pellets
- Woodchip
- Soil products
- 11. Records must be kept for each product of tonnes exported per annum and made available to the Assessment Manager upon request.

Visual Amenity

- 12. Prior to any works commencing on the construction of the approved use, provide to the Assessment Manager for review and approval, additional details on the external appearance of the approved use and associated structure/s, including but not limited to:
 - a. Specifications for material details, including samples of the colours and textures of external building materials;
 - b. The inclusion of landscaping and/or screens for visual amenity improvements (including for stabilisation of batters), screens and the like that enhance the visual amenity of the development including the galleries, towers, ground modules and energy/control rooms.

Outdoor Lighting

- 13. Any site lighting used during construction / works should not negatively impact on the visibility of Navigational Aids utilised for the primary shipping channels nor illuminate a landward glare beyond the site boundary. Lighting must be reviewed during construction and operations with respect to navigation. Where an issue is identified or a validated complaint received, the proponent must immediately rectify to the satisfaction of the Assessment Manager.
- 14. The proponent must install Phoenix EMS brand 'illuminator' light (or other similar brand approved by Assessment Manager) where new exterior lighting will be in direct line of sight of the river surface.
- 15. Prior to works commencing, the proponent must submit for review and approval by the Assessment Manager, details of proposed mitigation measure/s to reduce skyglow from all external lighting associated with the development.
 - Note: The proponent may achieve compliance through the use of relevant standards of Bundaberg Regional Council.

Fencing

16. Install and maintain security fencing along external boundaries of the premises as indicated on approved plans, Drawing No. 255200-G008 and 255200-G009. Fencing must be constructed of 1.8m high transparent black PVC plastic coated chain wire mesh with black posts, unless otherwise approved by the Assessment Manager.



Infrastructure

- 17. The applicant must notify the Assessment Manager of damage caused to any port or port user infrastructure or services including, but not limited to, security related devices, buildings, fences, lighting etc., roads, walkways and underground services or infrastructure, as a result of the approved use or during construction. The proponent must undertake necessary repairs at their expense and to the satisfaction of the Assessment Manager.
- 18. All connection points to existing potable water supply must have an isolation value installed on either side of the connection.
- 19. All steelwork must have appropriate corrosion protection measures applied in accordance with GPC Engineering site standard no. GPC-CSS-107 Protective coating unless otherwise approved in writing by the Assessment Manager.

Fire Service

20. An appropriate fire service must be established and maintained to the satisfaction of the relevant authority.

Tidal works

- 21. Prior to works commencing, the proponent must supply to the Assessment Manager for review and approval, 100% design RPEQ certified "for construction" tidal works drawings in electronic (CAD format) which illustrate all infrastructure and services installed on, under or over Port land in Lot 276 on SP128643.
- 22. In the event that any aspect of the approved tidal works fails, collapses or otherwise is not fit for purpose as intended, at the expense of the approval holder the works must be:
 - a. reinstated in accordance with this development approval; or
 - b. demolished and disposed of appropriately.
- 23. Any material which is deposited or any debris which falls or is deposited on tidal lands or into tidal waters during the construction of the approved development shall be removed by the applicant at their cost and expense. The applicant is to notify the Assessment Manager if any material or debris is deposited.
- 24. Upon completion of construction, the applicant shall provide the Assessment Manager with written confirmation that the seabed is clear of foreign materials.
- 25. If, as a result of the works, or other cause attributable to the proponent, any Port bank or tidal structure is displaced, the proponent at its cost and expense shall restore the bank or structure to its former condition and take such other action as is necessary to ensure the stability of the bank or structure to the satisfaction of the Assessment Manager.

Stormwater

- 26. Uncontrolled discharges of contaminated washdown water or contaminated stormwater to the adjoining premises or road network, including Wharf Drive, are not permitted.
- 27. The irrigation area/s must be in accordance with those approved by the relevant State environment authority and must have formal tenure arrangements where on GPC land.
- 28. Prior to works commencing for the relevant stage, a lawful point/s of discharge, demonstrating no actionable nuisance, must be established within Lot 276 on SP128643, for all stormwater overflow, exclusive of contaminants.
- 29. Prior to works commencing, or the submission of any Operational works application, whichever comes first, submit to, and have approved by, the Assessment Manager, a stormwater management plan, prepared by a suitably qualified person to demonstrate all stormwater management requirements within this Approval, including, but not limited to:
 - a. Frequency of rainfall events exceeding the system's capacity;



- b. Volume of rainfall/ stormwater that is exceeding the system's capacity
- c. Measures to mitigate any nuisance or damage, including erosion management, safety hazards to vehicles and users of Wharf Drive

Ground water

30. Unless otherwise approved in writing by the Queensland Government Department of Environment and Science (DES), or subsequent equivalent State agency administering the relevant legislation, any groundwater intercepted during construction activities is deemed to be a regulated waste contaminated with PFAS and must be managed and disposed of in accordance with the Environmental Protection Act 1994 (Qld) and its regulations and policies, unless the proponent has undertaken sampling and testing of the groundwater that has determined per-and polyfluoroalkyl substances (PFAS) levels are below the regulated waste threshold in the Environmental Protection Regulation 2019 (Qld).

Any written approval received from the Department of Environment and Science (DES), or subsequent equivalent State agency, must be submitted to the Assessment Manager and be approved by the Assessment Manager in writing.

31. A copy of the sampling and analysis report for any groundwater testing must be provided to the Assessment Manager for review and approval prior to disposal of groundwater offsite.

Construction Management

- 32. The proponent is required to apply for and obtain from GPC a Permit to Dig/Excavate prior to commencing works by contacting, Port Infrastructure Asset Manager on (07) 4976 1333. All reasonable measures must be taken to identify and protect existing services recorded or otherwise, and where necessary the proponent will submit a plan to GPC for approval to adjust any existing services found during this excavation that was not originally shown on the proposed plans
- 33. The hours for the construction of the facility (i.e. operation of any machinery and/or other equipment) shall be restricted to between 6.30am and 6:30pm Monday to Saturday. No works shall be undertaken on Sunday or on public holidays. Any variations to these times will be subject to the written approval of the Assessment Manager.
- 34. Prior to construction works commencing on site, a Construction Traffic Management Plan (CTMP) and Traffic Guidance Scheme (TGS), designed and implemented in accordance with the current edition of the Manual of Uniform Traffic Control Devices, Part 3 works on roads, and specific to the construction works being undertaken must be submitted to the Assessment manager for approval.
 - The CTMP must be amended and approved by the Assessment Manager as necessary for any proposed or amended construction works.
- 35. Once approved, the works must be carried out in accordance with the CTMP and TGS and the plan and scheme will form part of the approved plans.
- 36. Upon completion of the construction works, the proponent must reinstate the property to the same condition as prior to works being undertaken, with the exception of the approved works, unless agreed to in writing by the Assessment Manager.
- 37. In the event any additional construction compound is required on port land outside the proponents lease areas for offices, laydown areas, employee car parking or stockpiling areas etc., the proponent or their contractor must obtain a Consent to Enter from GPC's Property Specialist via 07 4976 1334 or prior to works commencing.



- 38. The construction compound, including offices, laydown areas and employee car parking, is to be contained within the nominated area unless otherwise approved in writing by the Assessment Manager.
- 39. No mud, dirt or other debris is to be tracked onto public roads during construction and operation of the development.
- 40. In the event acid sulphate soils are disturbed/excavated and require treatment on site, a site specific Acid sulphate management plan must be submitted to the Assessment Manager for approval prior to such works commencing. Once the management plan is approved, the works must be carried out in accordance with this plan.
- 41. Prior to disposal of excavated material outside the proponent's lease areas but on Port land, the proponent must submit to the Assessment Manager for approval, the proposed location and volume of material to be transferred to the location.
- 42. Construction fill material must be uncontaminated and reused from onsite or sourced from a licensed quarry.
- 43. Prior to the commencement of works, a Construction Environmental Management Plan (EMP) is to be submitted to the Assessment Manager for approval, specific to the development that ensures:
 - a. environmental risks are identified, managed and continually assessed; and
 - b. that staff are trained and aware of their obligations under the CEMP, including a copy of the management plan and development approval available on site at all times; and
 - c. that reviews of environmental performance are undertaken at least annually; and
 - d. any amendments to the CEMP are to be submitted to the Assessment Manager for review and approval; and
 - e. any rehabilitation and decommissioning works where required.

Once approved by the Assessment Manager, the construction of the approved development must be carried out in accordance with this CEMP.

Note: GPC has a guideline for the development of environmental management plans that may be utilised in meeting the requirements of this condition.

ENVIRONMENT

Operational Environmental Management Plan

- 44. Prior to the commencement of the use, an Environmental Management Plan (EMP) is to be submitted to the Assessment Manager for approval, specific to the development that ensures:
 - a. environmental risks are identified, managed and continually assessed; and
 - b. that staff are trained and aware of their obligations under the EMP, including a copy of the management plan and development approval available on site at all times; and
 - c. that reviews of environmental performance are undertaken at least annually; and
 - d. any amendments to the EMP are to be submitted to the Assessment Manager for review and approval; and
 - e. any rehabilitation and decommissioning works where required.

Once approved by the Assessment Manager, the approved development must be carried out in accordance with this EMP.



Note: GPC has a guideline for the development of environmental management plans that may be utilised in meeting the requirements of this condition.

Incident notification

- 45. Gladstone Ports Corporation Environment Hotline (07) 4976 1617 is to be notified of the occurrence of any:
 - a. release / spill of contaminants (e.g. fuels / chemicals / sewerage) greater than 250L to land;
 - b. release / spill of contaminants (e.g. fuels / chemicals / sewerage) of any amount to water;
 - c. release / spill of contaminants (e.g. fuels / chemicals / sewerage/bulk material and minerals) of any amount beyond the footprint of the Development Approval;
 - d. any environmental complaints received by the holder of this approval; and
 - e. non-compliance with conditions of this approval or any other environmental approval obtained in relation to the development.
- 46. Environmental incident notification must be included in any Environmental Management Plans for the premises/development.



Part 1c: Assessment Manager Advice Notes

- A. All other relevant approvals must be obtained before commencement of the development or operation of the development, including any Building works or Plumbing, drainage works or Material change of use e.g. substation. Refer to tables of assessment (Table 4.1 and 4.2) to determine whether proposed development is Accepted subject to requirements or Code assessable.
- B. This decision notice does not represent an approval to commence Building work.
- C. The applicant is advised that parts of this approved development are outside of the proposed formal tenure arrangements i.e. lease. Where tenure is required for the development site, the proponent or their contractor must apply for and obtain appropriate tenure from GPC's Property Advisor via 07 4976 1334 or property@gpcl.com.au prior to works commencing.
- D. Where a construction compound, laydown area or acid sulphate soil treatment site is required, the proponent or their contractor is required to apply for and obtain a Consent to Enter from GPC's Property Advisor via 07 4976 1334 or property@gpcl.com.au prior to works commencing.
- E. Connections to water and sewerage infrastructure will require Plumbing and Drainage works approvals from a suitably qualified person.
- F. The premises is located on parts of lots that are registered on the Queensland Environmental Management Register. Therefore, disposal of any excavated material off site must be in accordance with relevant legislation, or alternately retained on site in accordance with all relevant legislative requirements.
- G. Any future extensions or improvements to the proposed activity or establishment, including any future car parking or signage are likely subject to assessment under the Port of Bundaberg Land use plan 2020 and the applicant is encouraged to ensure all necessary enquiries are made and approvals obtained.
- H. Where a Permit to Dig/Excavate prior to commencing excavation or digging for the development, the proponent or their contractor is required to apply for and obtain the permit by contacting the Port Infrastructure Asset Manager on 4976 1332 or bartono@gpcl.com.au.
- I. The Environmental Protection Act 1994 states that a person must not carry out any activity that causes, or is likely to cause, environmental harm unless the person takes all reasonable and practicable measures to prevent or minimise the harm. Environmental harm includes environmental nuisance. In this regard persons and entities, involved in the civil, earthworks, construction, and operational phases of this development, are to adhere to their 'general environmental duty' to minimise the risk of causing environmental harm.
- J. Where the Applicant is required to submit further documentation to the Assessment Manager, this is to be directed to the Planning section at planning@gpcl.com.au, including reference to the allocated development application number.



PART 2: REFERRAL AGENCY CONDITIONS

Referral Agency Name: Department of State Development, Infrastructure, Local Government and Planning



SARA reference: 2106-23148 SRA Council reference: DA202/05/01

28 January 2022

Chief Executive Officer
Port of Gladstone Ports Corporation Limited
PO Box 259
GLADSTONE QLD 4680
planning@gpcl.com.au

Attention: Judy Horsfall

Dear Ms Horsfall

SARA Response—Wharf Drive, Buss Street and Powers Street, Burnett Heads—Common User Infrastructure

(Referral agency response given under section 56 of the Planning Act 2016)

The development application described below was confirmed as properly referred by the State Assessment and Referral Agency (SARA) on 11 October 2021.

Response

Outcome: Referral agency response – with conditions.

Date of Response: 28 January 2022

Conditions: The conditions in **Attachment 1** must be attached to any

development approval.

Advice: Advice to the applicant is in **Attachment 2**.

Reasons: The reasons for the referral agency response are in **Attachment 3**.

Development Details

Description: Development Permit

- Material Change of Use for Loading and Unloading Infrastructure and Activities (Common User Infrastructure) and Environmentally Relevant Activities 50(1)(a) and 50(2)
- Operational Work involving Excavating and Filling and Engineering and Landscaping Work associated with a Material Change of

Use

SARA Role: Referral Agency

SARA Trigger:

• Schedule 10, Part 5, Division 4, Table 2, Item 1 of the Planning

Regulation 2017

Development application for material change of use for an

environmentally relevant activity

• Schedule 10, Part 17, Division 3, Table 1, Item 1 of the Planning

Regulation 2017

Development application for operational work that is tidal works

SARA Reference: 2106-23148 SRA

Assessment Manager: Port of Gladstone Ports Corporation Limited

Street Address: Wharf Drive, Buss Street and Powers Street, Burnett Heads

Real Property Description: Lot 1 on RP122698, lot 1 on SP308111, lot 276 on SP128643, lot 2 on

RP137256, lot 3 on SP133687 and lot 501 on SP279707

Applicant Name: Sugar Terminals Limited

Applicant Contact Details: c/- Aurecon

PO Box 1060

MACKAY QLD 4740

planning.mackay@aurecongroup.com

Environmental Authority: This referral included an application for an environmental authority

under section 115 of the Environmental Protection Act 1994. Below

are the details of the decision:

Approved

• Reference: P-EA-100147468

Effective date: Date the development application DA202/05/01 is

approved by Ports of Gladstone Corporation Limited

Prescribed environmentally relevant activity (ERA): ERA 50(1)(a)

and ERA 50(2)

If you are seeking further information on the environmental authority, the Department of Environment and Science's website includes a

register. This can be found at: www.des.qld.gov.au

Representations

An applicant may make representations to a concurrence agency, at any time before the application is decided, about changing a matter in the referral agency response (s.30 Development Assessment Rules) Copies of the relevant provisions are in **Attachment 4**.

A copy of this response has been sent to the applicant for their information.

For further information please contact Cavannah Deller, Planning Officer, on (07) 4331 5614 or via email WBBSARA@dsdilgp.qld.gov.au who will be pleased to assist.

Yours sincerely

Luke Lankowski

Manager, Planning - Wide Bay Burnett

cc Sugar Terminals Limited, planning.mackay@aurecongroup.com

enc Attachment 1 - Referral agency conditions

Attachment 2 - Advice to the applicant

Attachment 3 - Reasons for referral agency response

Attachment 4 - Representations provisions

Attachment 5 - Approved plans and specifications

Attachment 1—Referral Agency Conditions

(Under section 56(1)(b)(i) of the *Planning Act 2016* the following conditions must be attached to any development approval relating to this application) (Copies of the plans and specifications referenced below are found at Attachment 5)

No.	Conditions	Condition Timing
Oper	ational Work	
2016 enfor	dule 10, Part 17, Division 3, Table 1, Item 1—The chief executive admin nominates the Director-General of the Department of Environment cement authority for the development to which this development anistration and enforcement of any matter relating to the following condition	and Science to be the approval relates for the
1.	 The proposed development must be carried out generally in accordance with the following plans: BST CUI Sugar Terminal Upgrade, Overall Site Layout Plan, prepared by Linear Engineering dated 6 October 2021, reference 255220-C-002, revision E; BST CUI Sugar Terminal Upgrade, Site Layout Plan, prepared by Linear Engineering, dated 6 October 2021, reference 255220-C-003, revision E; BST CUI Sugar Terminal Upgrade, New Conveyors, General Arrangement Plan, prepared by Linear Engineering, dated 30 August 2021, reference 255200-G-003, revision B; BST CUI Sugar Terminal Upgrade, New Yard Conveyor C22, General Arrangement Sheet 1 of 2, prepared by Linear Engineering, dated 30 August 2021, reference 255230-M-030, revision B; BST CUI Sugar Terminal Upgrade, Shiploader, Ilmenite Telechute, General Arrangement and Operating Range, prepared by Linear Engineering, dated 7 September 2021, reference 255260-M-081, revision A; BST CUI Sugar Terminal Upgrade, Shiploader, Existing Sugar Telechute – Modifications, General Arrangement and Operating Range, prepared by Linear Engineering, dated 7 September 2021, reference 255260-M-082, revision A. 	For the duration of the works.
2.	For the proposed works, only use clean materials and ensure that the works do not cause contamination. To achieve this only use materials which are free from contaminants as defined under section 11 of the <i>Environmental Protection Act 1994</i> .	For the duration of works
3.	Erosion and sediment control measures which are in accordance with the Best Practice Erosion and Sediment Control (BPESC) Guidelines for Australia (International Erosion Control Association), are to be installed and maintained to prevent the release of sediment to tidal waters.	For the duration of works
4.	Should any aspect of the wharf equipment subject to this development approval collapse, fail or otherwise suffer structural consequences which impact their integrity or ability to function as intended, the works must be: (a) reinstated in accordance with this development approval; or	As soon as reasonably practicable subsequent to the damage

	(b) removed and disposed of at an appropriately licensed facility.	
5.	(a) Obtain RPEQ certification confirming that the tidal works, have been constructed in accordance with the Department of Environment and Heritage Protection Guideline 'Building and Engineering Standards for Tidal Works'.	Within two (2) weeks of the completion of the works
	(b) A copy of the certification must be provided to palm@des.qld.gov.au or mailed to:	
	Department of Environment and Science Permit and Licence Management Implementation and Support Unit GPO Box 2454 BRISBANE QLD 4001	
6.	Submit "As Constructed drawings" to palm@des.qld.gov.au or mail to:	Within two (2) weeks of
	Department of Environment and Science Permit and Licence Management Implementation and Support Unit GPO Box 2454 BRISBANE QLD 4001	the completion of the works
7.	(a) In the event that the works cause disturbance or oxidisation of acid sulfate soil, the affected soil must be treated and thereafter managed (until the affected soil has been neutralised or contained) in accordance with the current Queensland Acid Sulfate Soil Technical Manual: Soil Management Guidelines, prepared by the Department of Science, Information Technology, Innovation and the Arts, 2014.	(a) Upon disturbance or oxidisation until the affected soil has been neutralised or contained
	(b) Certification by an appropriately qualified person, confirming that the affected soil has been neutralised or contained, in accordance with (a) above is to be provided to palm@des.qld.gov.au or mailed to:	(b) At the time the soils have been neutralised or contained
	Department of Environment and Science Permit and Licence Management Implementation and Support Unit GPO Box 2454 BRISBANE QLD 4001	
	Note: Appropriately qualified person(s) means a person or persons who has professional qualifications, training, skills and experience relevant to soil chemistry or acid sulfate soil management and can give authoritative assessment, advice and analysis in relation to acid sulfate soil management using the relevant protocols, standards, methods or literature.	

Attachment 2—Advice to the Applicant

General Advice

1. Terms and phrases used in this document are defined in the *Planning Act 2016* its regulation or the State Development Assessment Provisions (SDAP) version 2.6. If a word remains undefined it has its ordinary meaning.

Attachment 3—Reasons for Referral Agency Response

(Given under section 56(7) of the *Planning Act 2016*)

The reasons for SARA's decision are:

- The proposed development is for loading and unloading infrastructure and activities at the Port of Bundaberg (involving Environmentally Relevant Activity 50(1)(a) and 50(2) and tidal works), specifically a multi-user conveyor.
- The proposed development maintains coastal processes and will not cause an increase of coastal erosion impacts.
- The proposed development maintains existing access to State coastal land.
- The proposed development has been located and designed to mitigate impacts on environmental values of the natural environment and sensitive receptors.
- Conditions are required to ensure the proposed development complies with State Code 8: Coastal Development and Tidal Works of the State Development Assessment Provisions.

Material used in the assessment of the application:


- The development application material and submitted plans
- Planning Act 2016
- Planning Regulation 2017
- The State Development Assessment Provisions (version 2.6), as published by the department
- The Development Assessment Rules
- SARA DA Mapping system
- State Planning Policy mapping system


Attachment 4—Change Representation Provisions

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Attachment 5—Approved Plans and Specifications

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€ TAIL PULLEY N 7260386.025

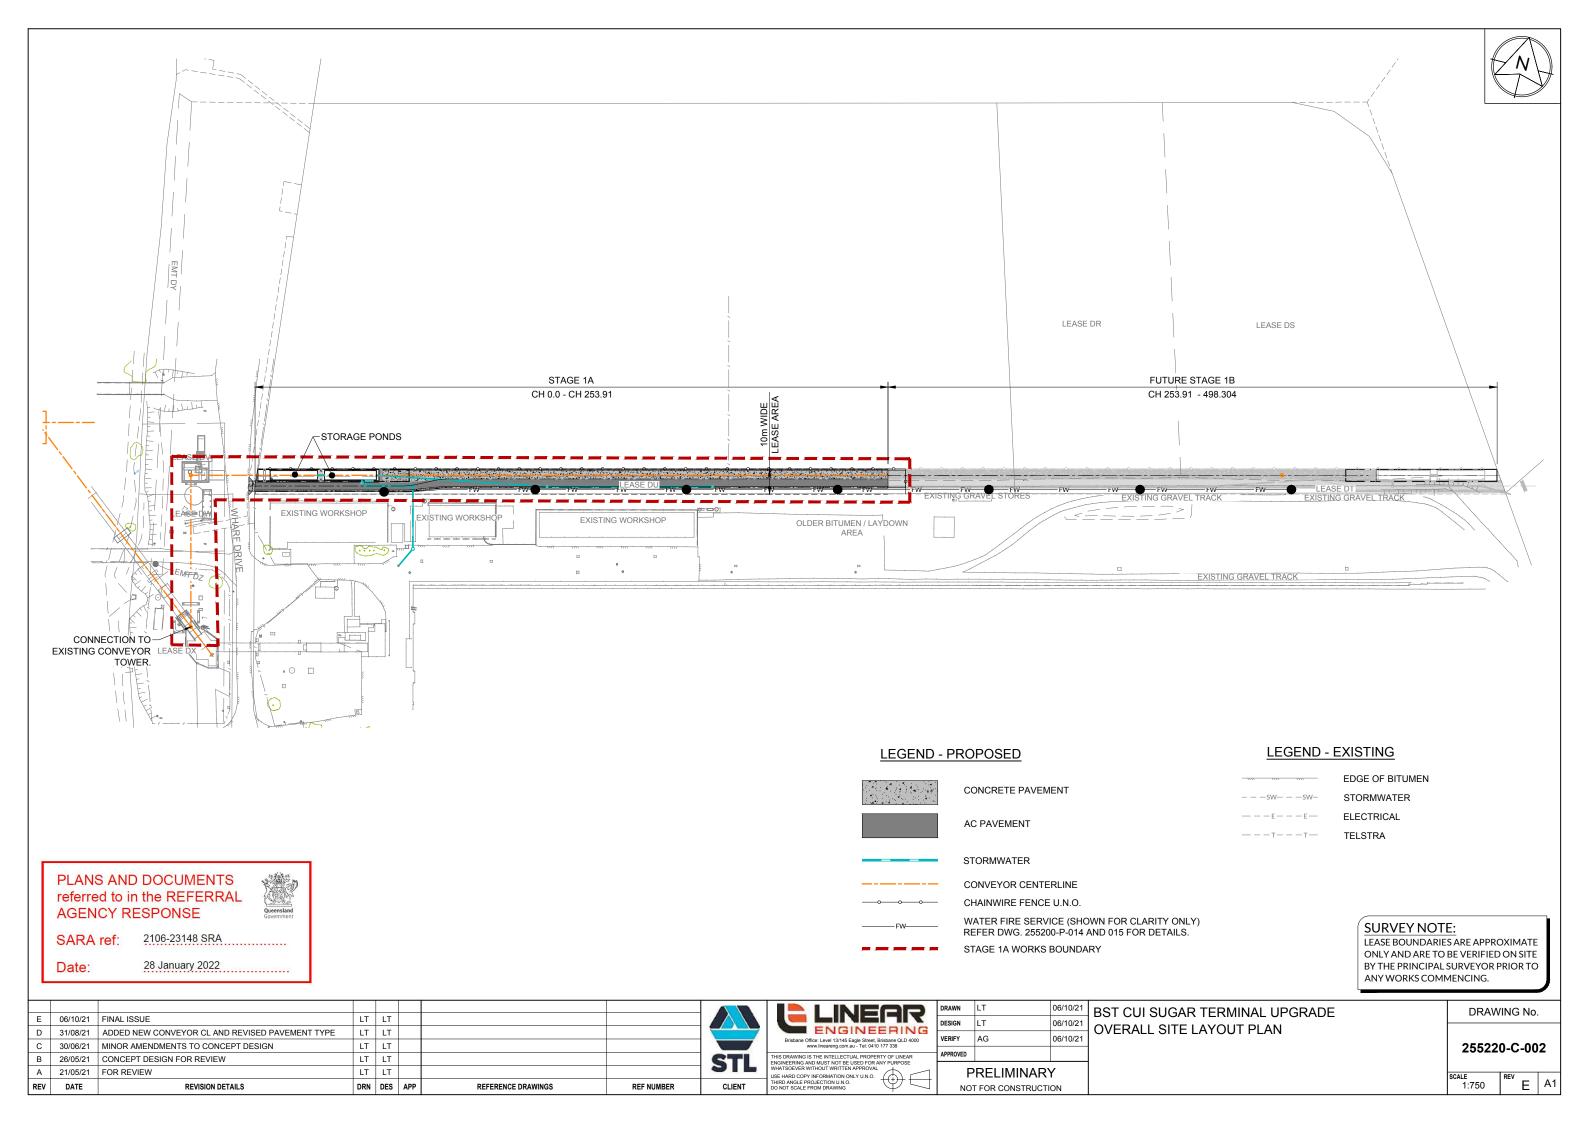

<u>PLAN</u>

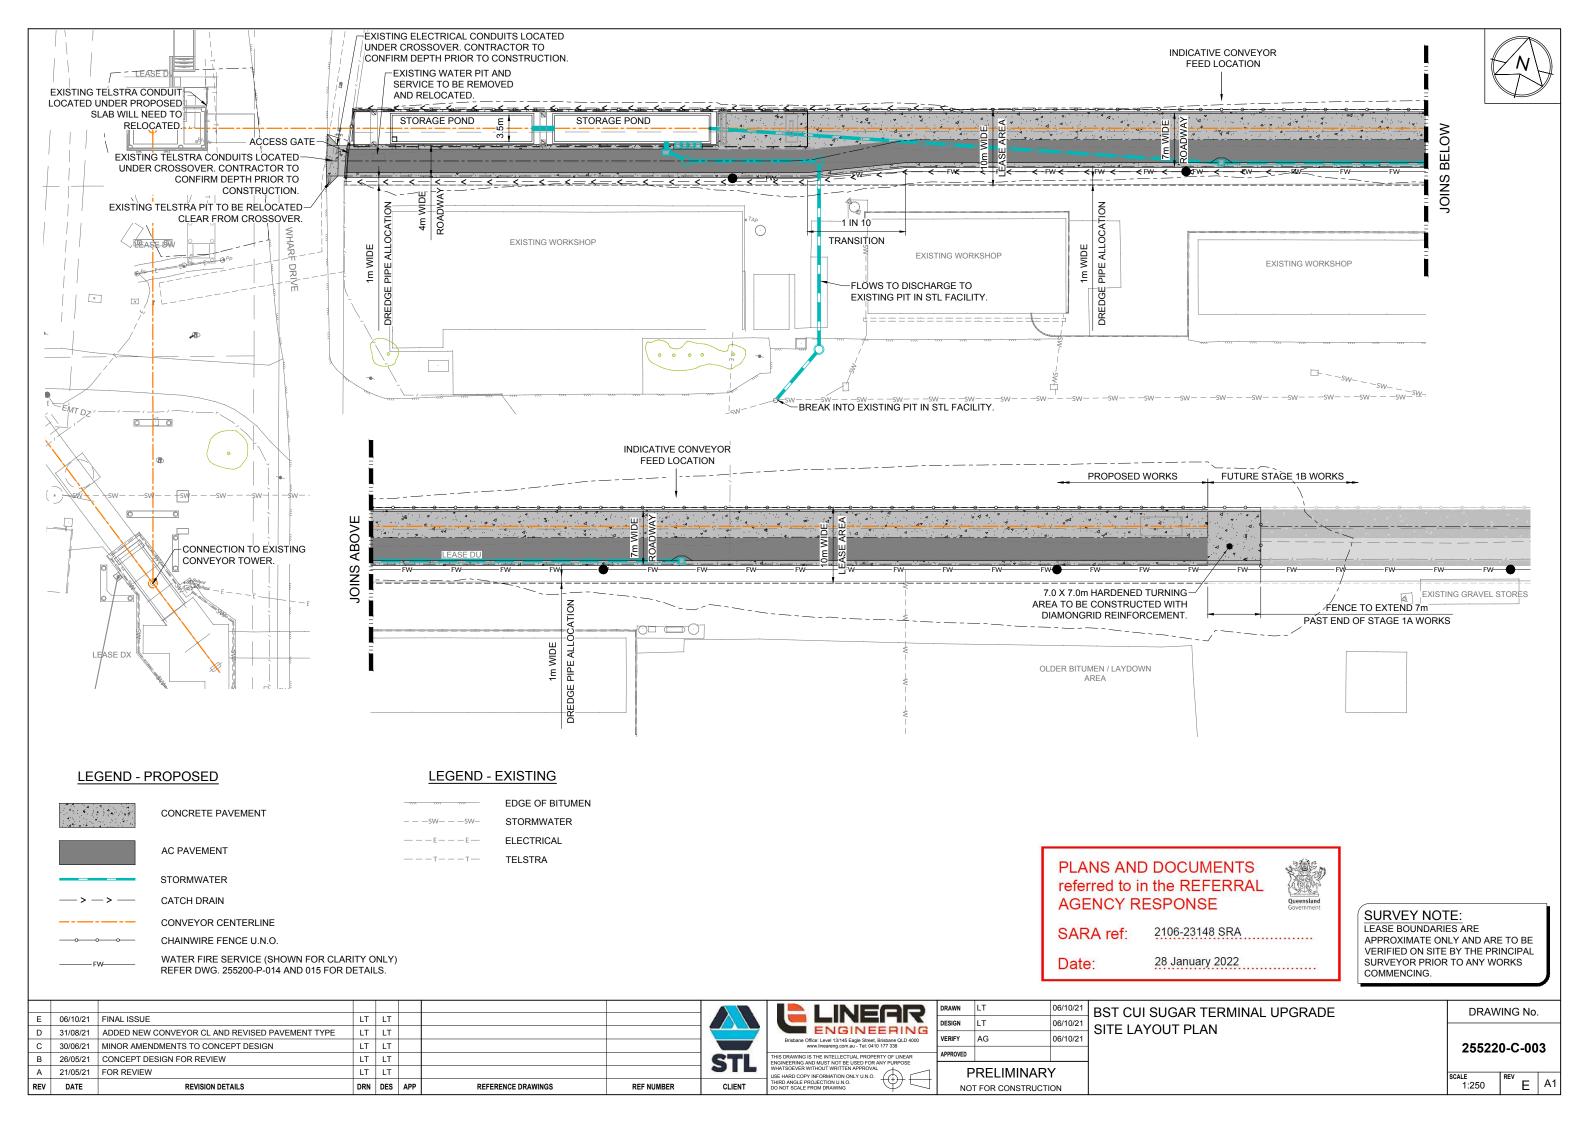NOTES

1. BASIS OF SETOUT. MGA94 ZONE 56 FIXED OFF PSM 3853 + 36119 E 437586.809 N 7260217.502 Z 4.369 PSM 36119 E 437589.795 N 7260510.443 Z 4.425

PLANS AND DOCUMENTS referred to in the REFERRAL AGENCY RESPONSE

- NEW LEASE BOUNDARIES

- EXISTING FENCING

SARA ref:

2106-23148 SRA

Date:

28 January 2022

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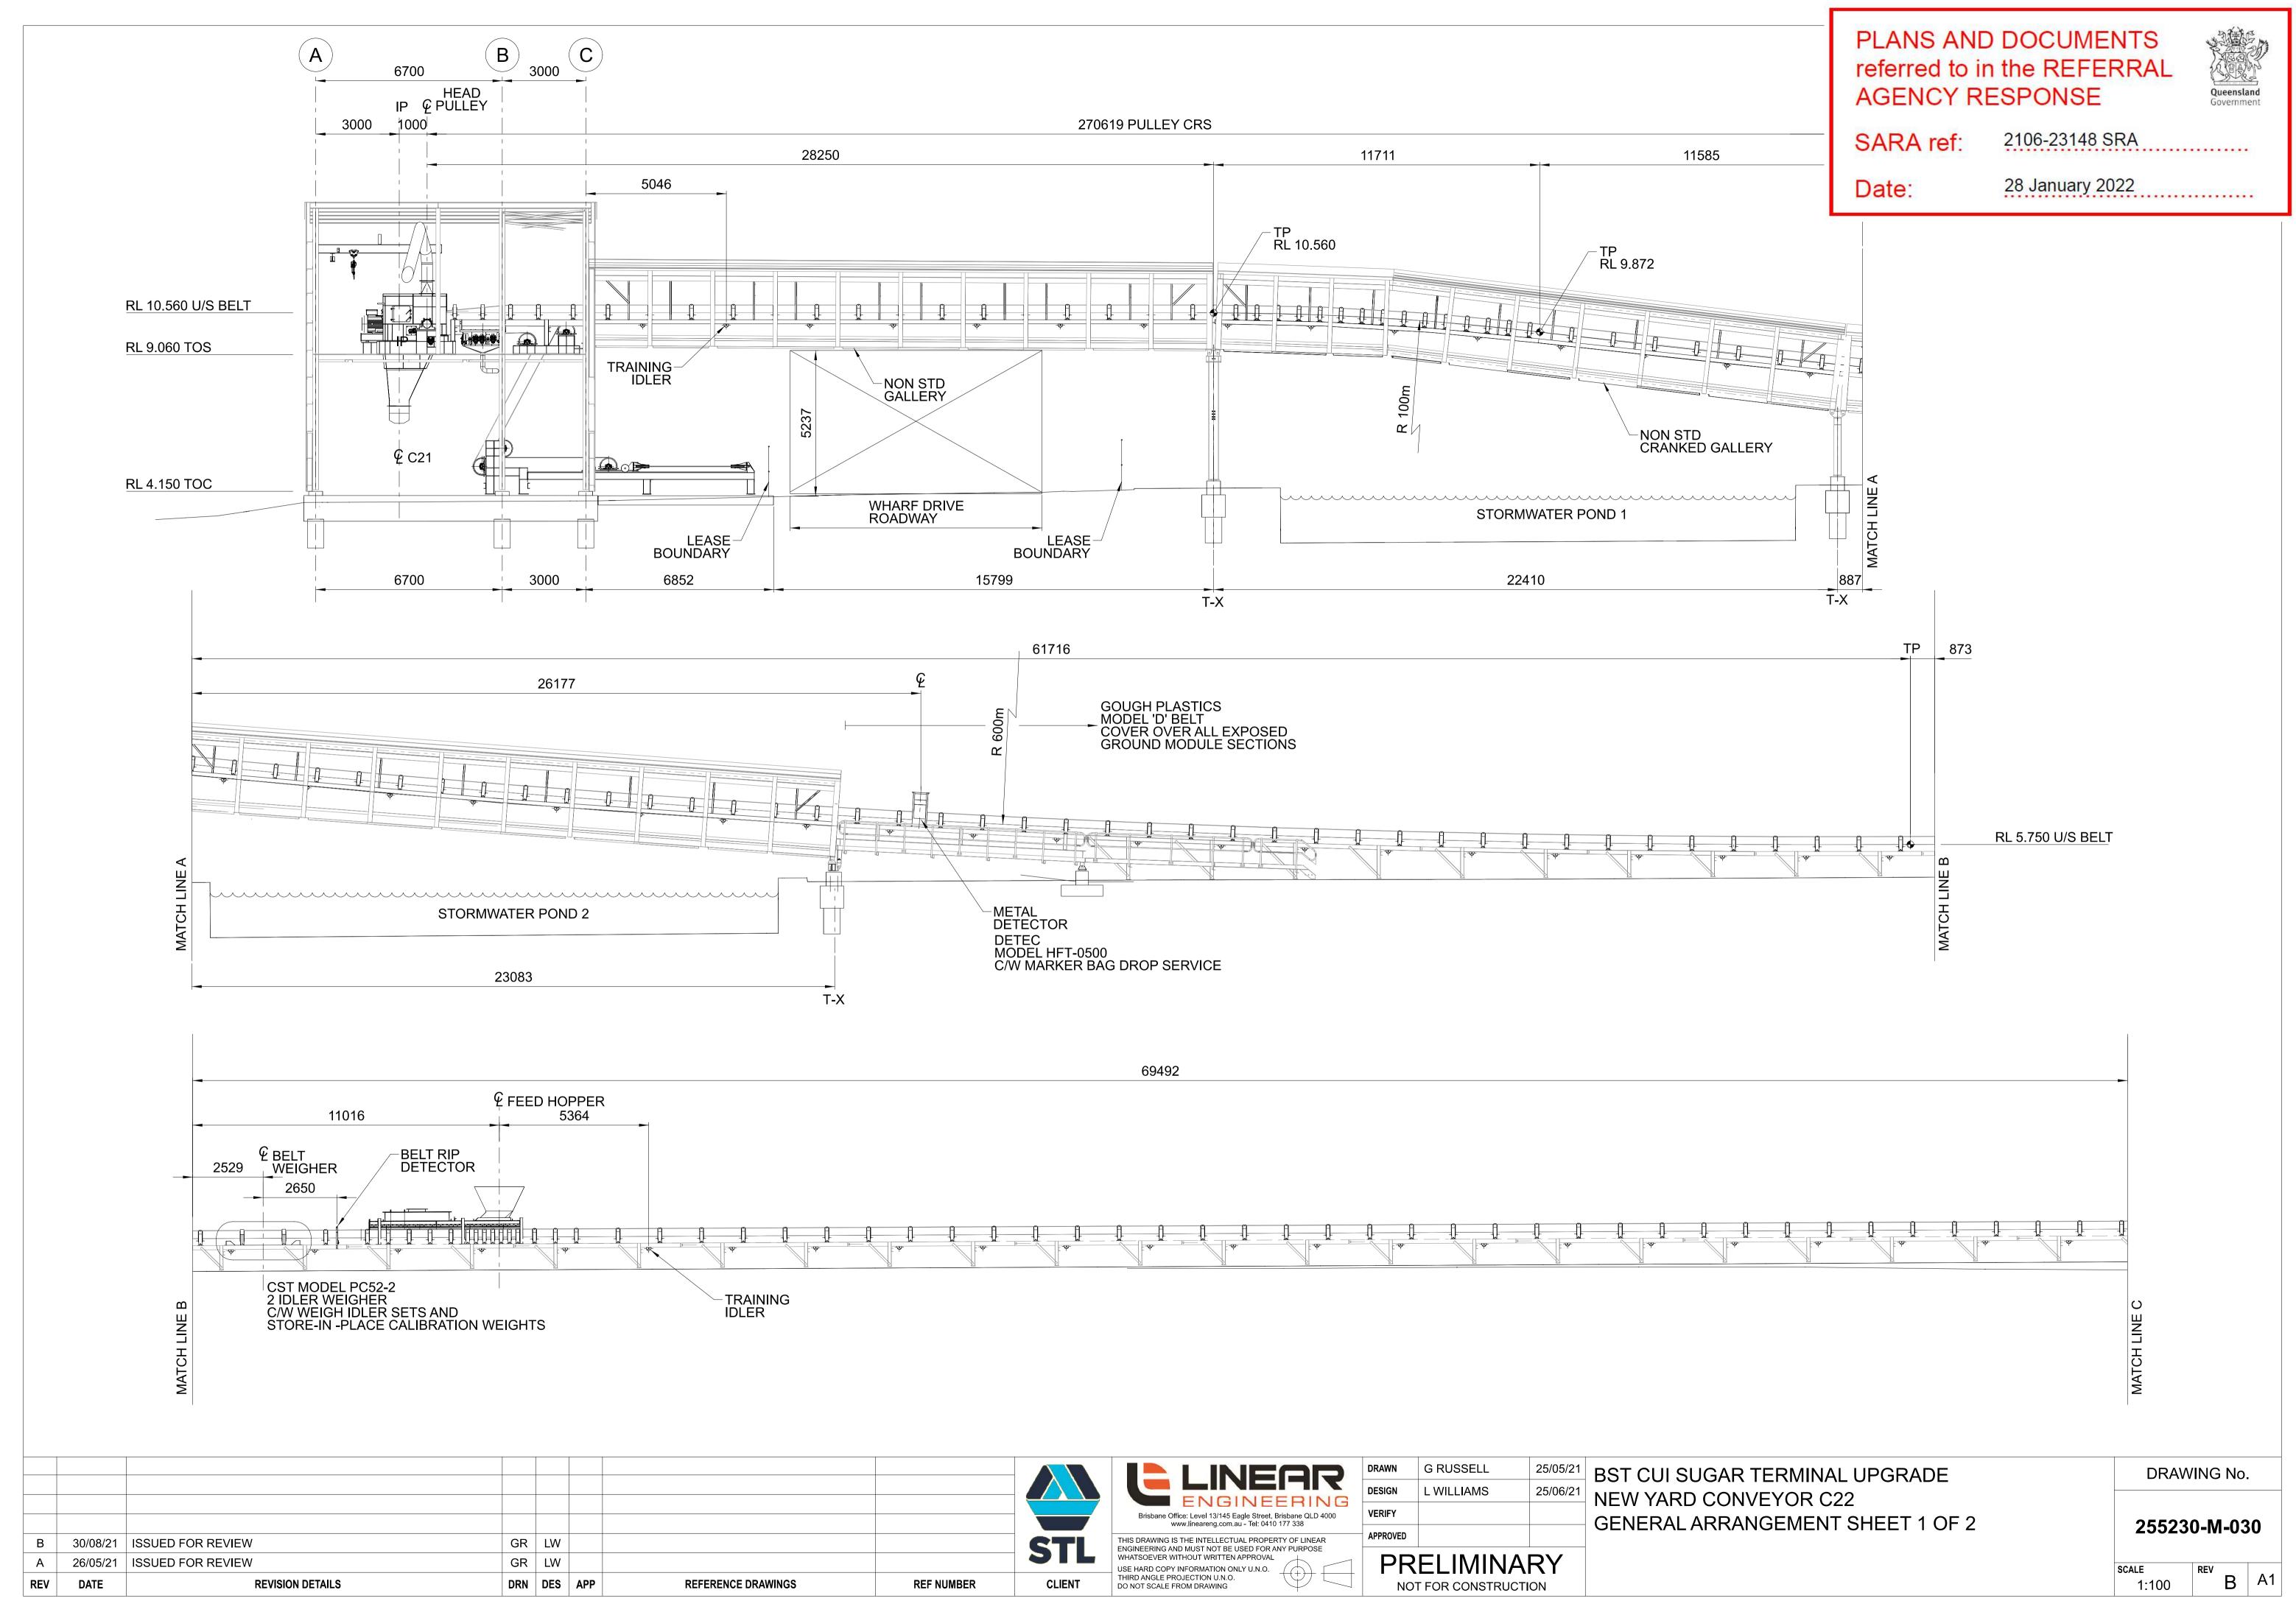
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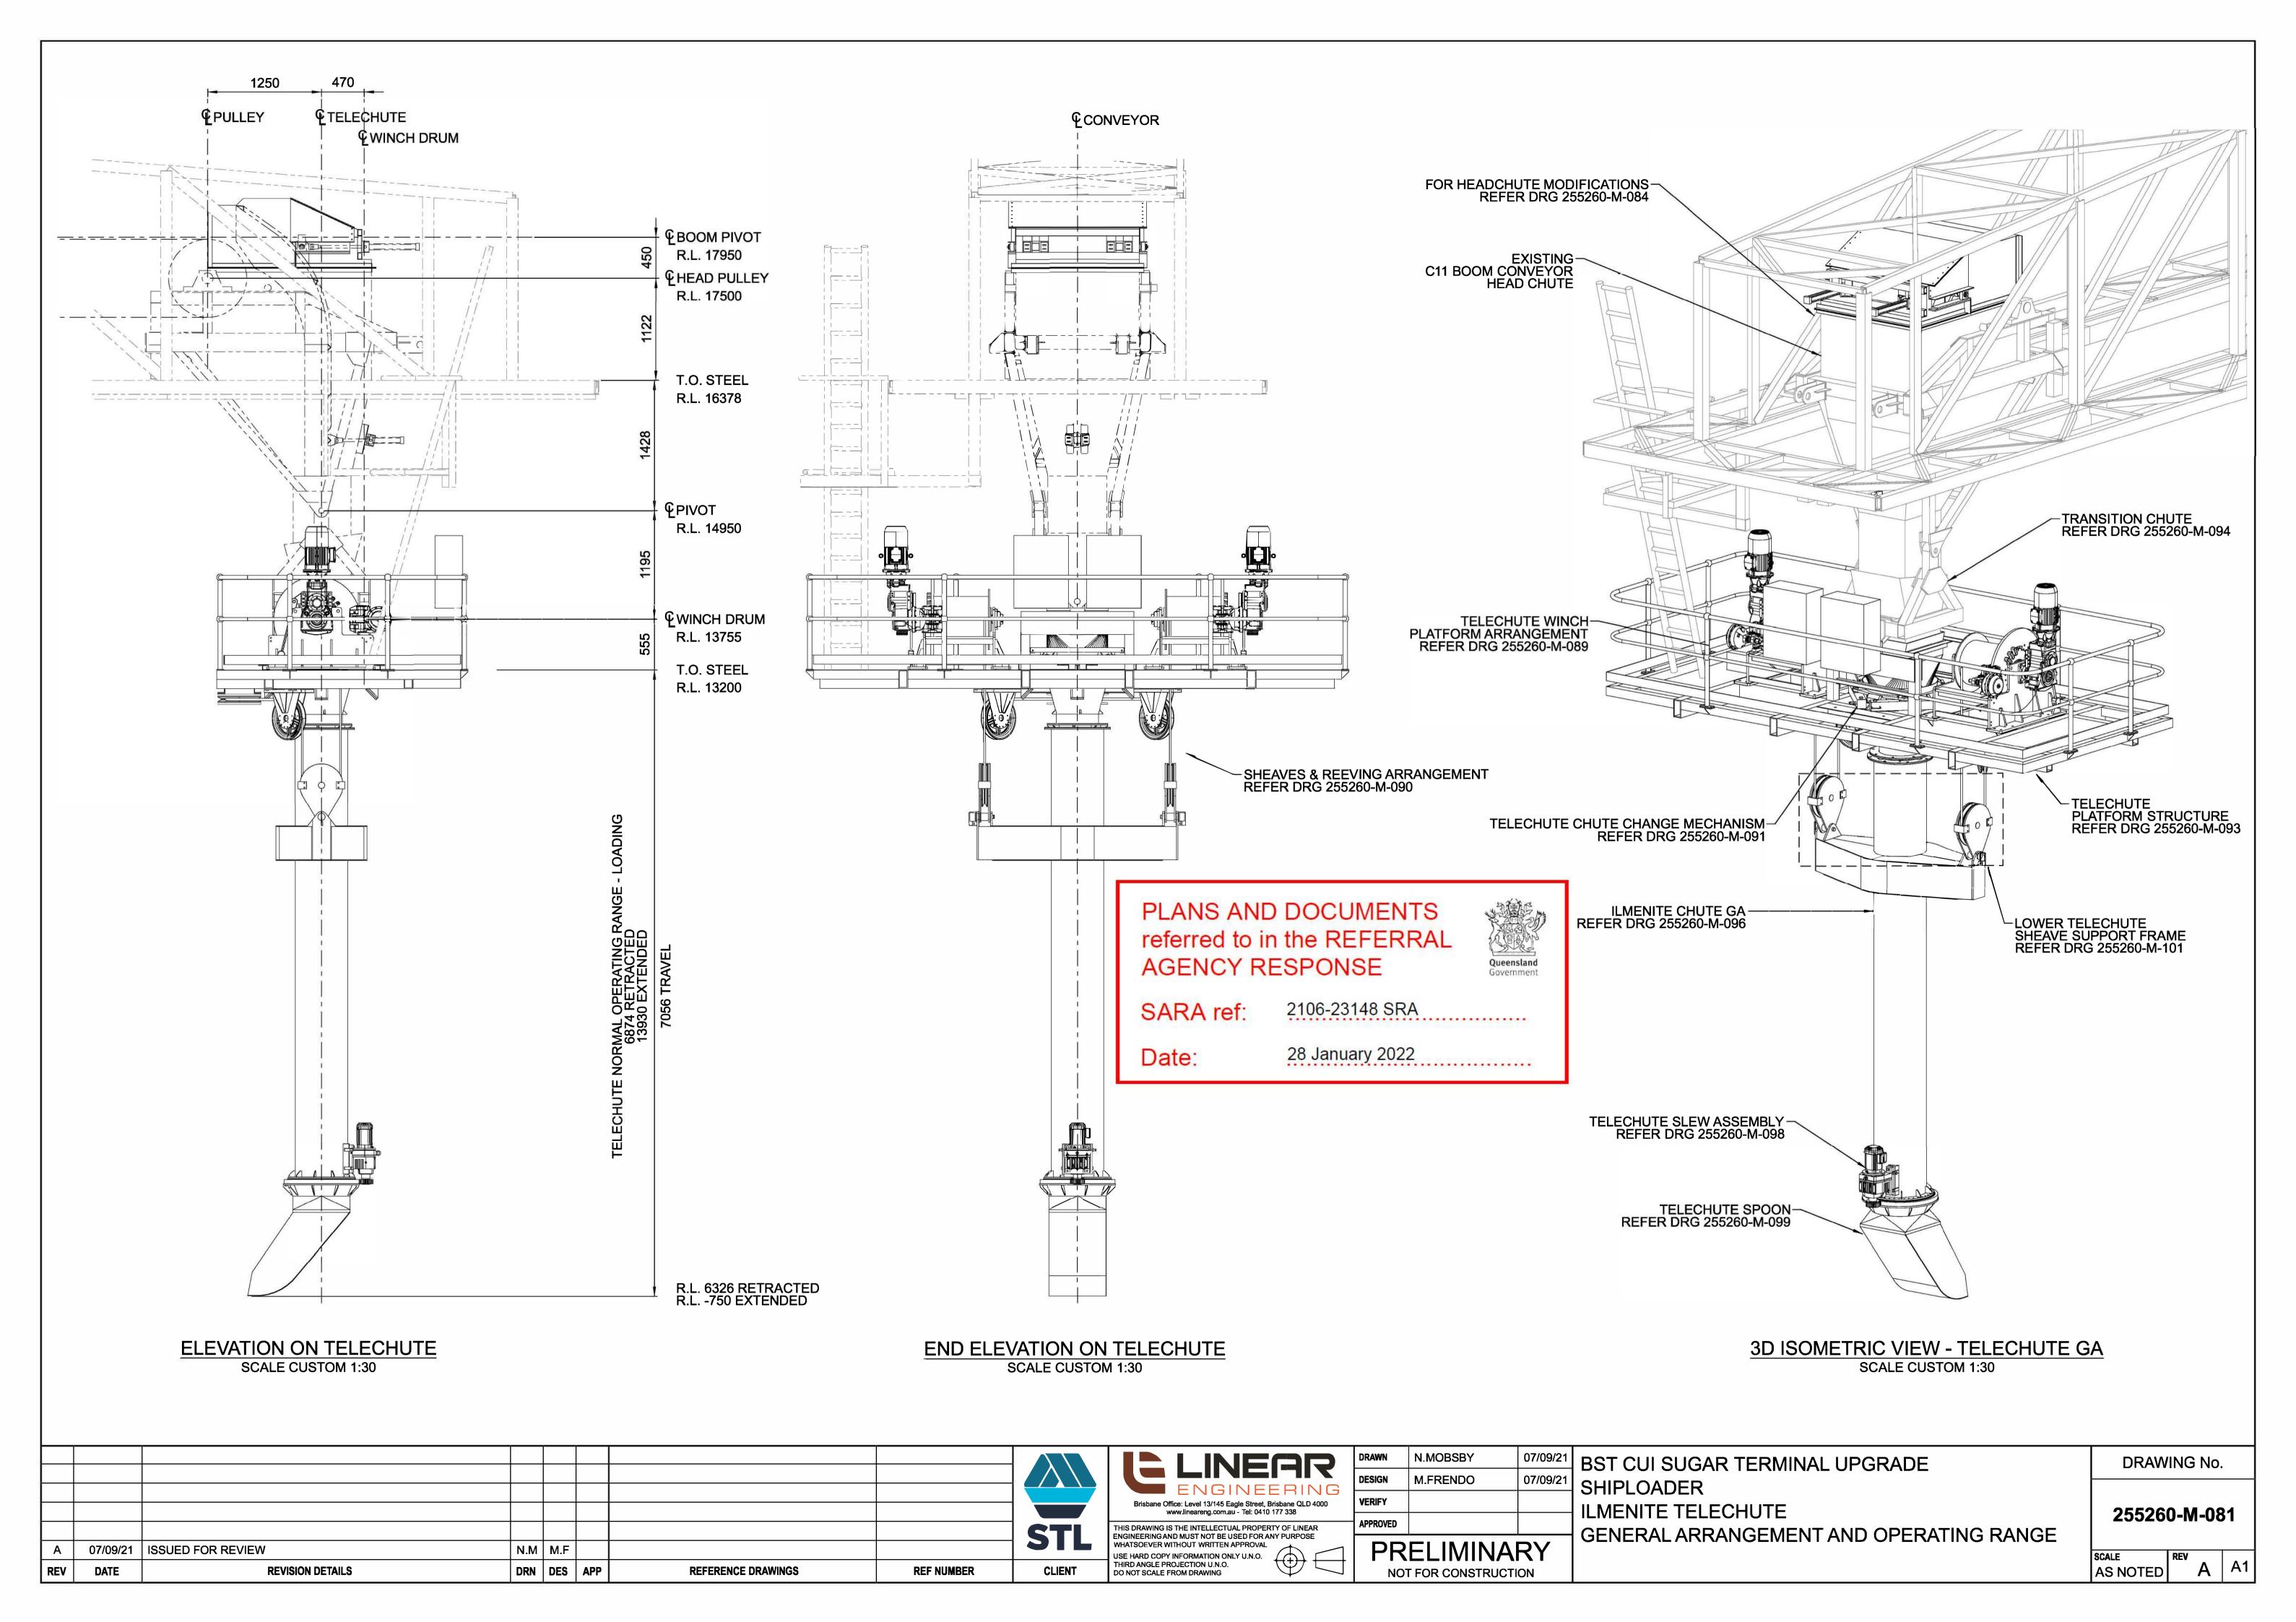
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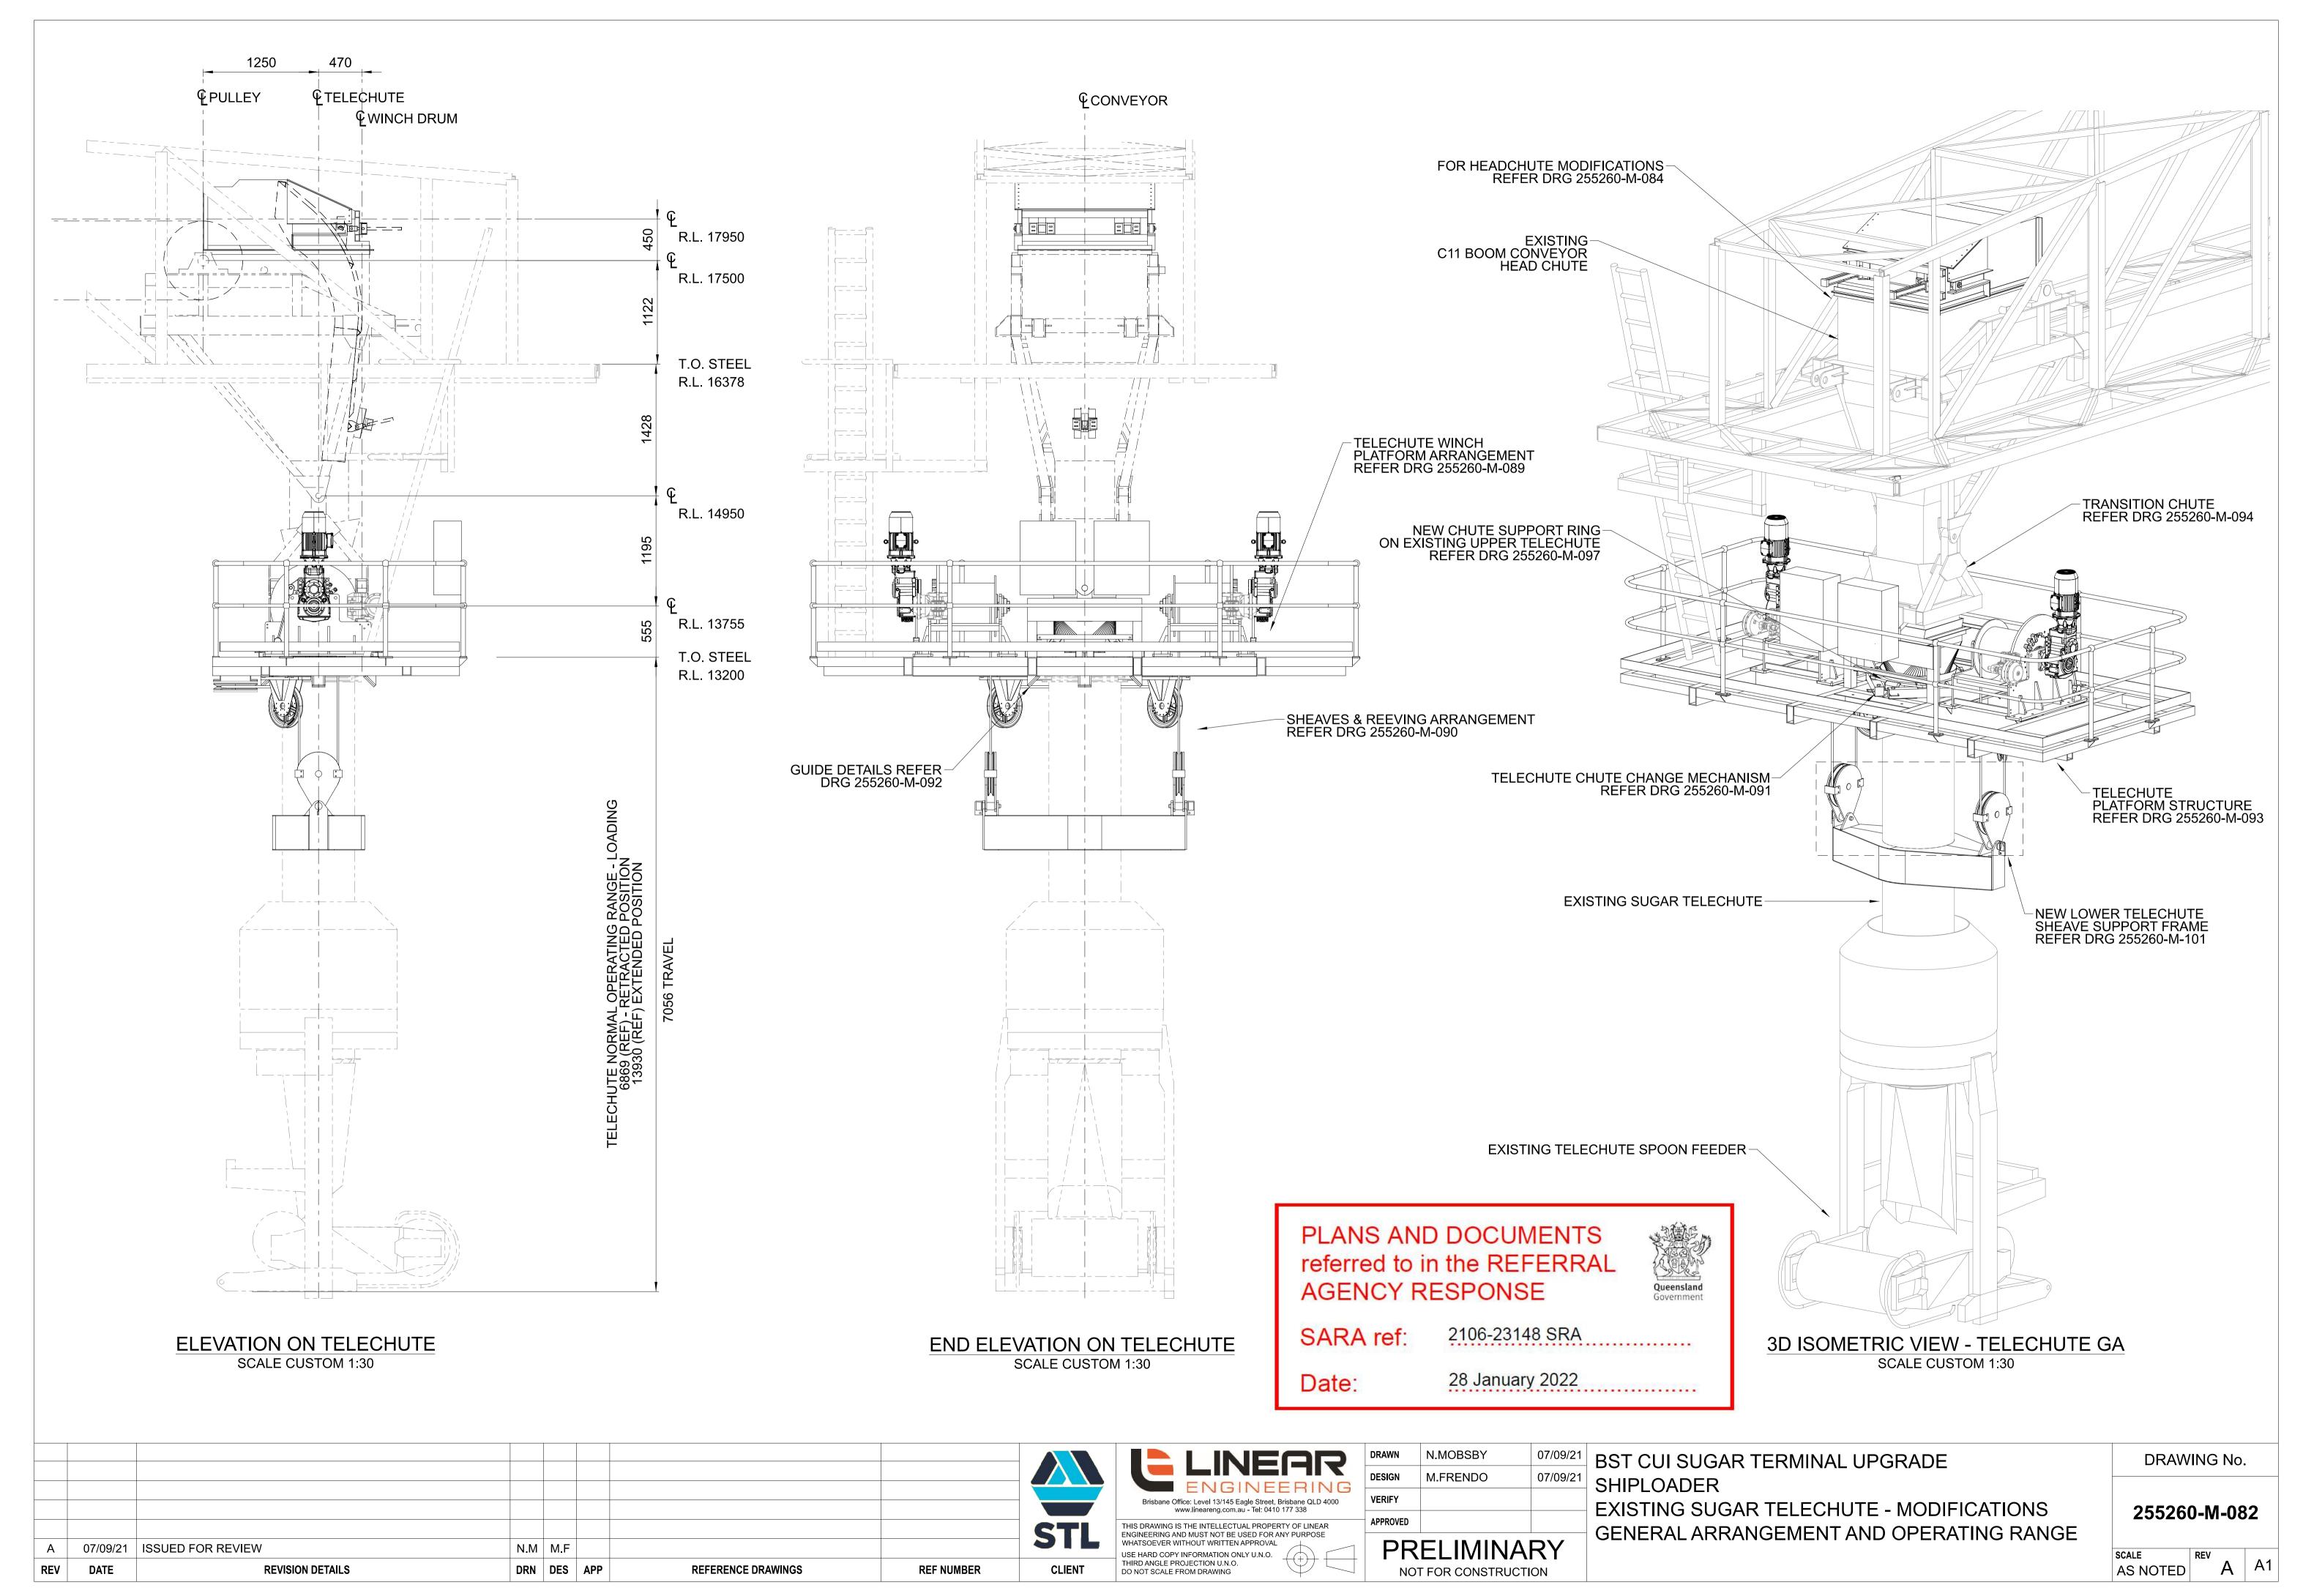
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Development Assessment Rules—Representations about a referral agency response

The following provisions are those set out in sections 28 and 30 of the Development Assessment Rules¹ regarding representations about a referral agency response

Part 6: Changes to the application and referral agency responses

28 Concurrence agency changes its response or gives a late response

- 28.1. Despite part 2, a concurrence agency may, after its referral agency assessment period and any further period agreed ends, change its referral agency response or give a late referral agency response before the application is decided, subject to section 28.2 and 28.3.
- 28.2. A concurrence agency may change its referral agency response at any time before the application is decided if—
 - (a) the change is in response to a change which the assessment manager is satisfied is a change under section 26.1; or
 - (b) the Minister has given the concurrence agency a direction under section 99 of the Act; or
 - (c) the applicant has given written agreement to the change to the referral agency response.²
- 28.3. A concurrence agency may give a late referral agency response before the application is decided, if the applicant has given written agreement to the late referral agency response.
- 28.4. If a concurrence agency proposes to change its referral agency response under section 28.2(a), the concurrence agency must—
 - (a) give notice of its intention to change its referral agency response to the assessment manager and a copy to the applicant within 5 days of receiving notice of the change under section 25.1;
 and
 - (b) the concurrence agency has 10 days from the day of giving notice under paragraph (a), or a further period agreed between the applicant and the concurrence agency, to give an amended referral agency response to the assessment manager and a copy to the applicant.

Pursuant to Section 68 of the *Planning Act 2016*

In the instance an applicant has made representations to the concurrence agency under section 30, and the concurrence agency agrees to make the change included in the representations, section 28.2(c) is taken to have been satisfied.

Part 7: Miscellaneous


30 Representations about a referral agency response

30.1. An applicant may make representations to a concurrence agency at any time before the application is decided, about changing a matter in the referral agency response.³

An applicant may elect, under section 32, to stop the assessment manager's decision period in which to take this action. If a concurrence agency wishes to amend their response in relation to representations made under this section, they must do so in accordance with section 28.



Approved Plans and Specifications Attachment 2

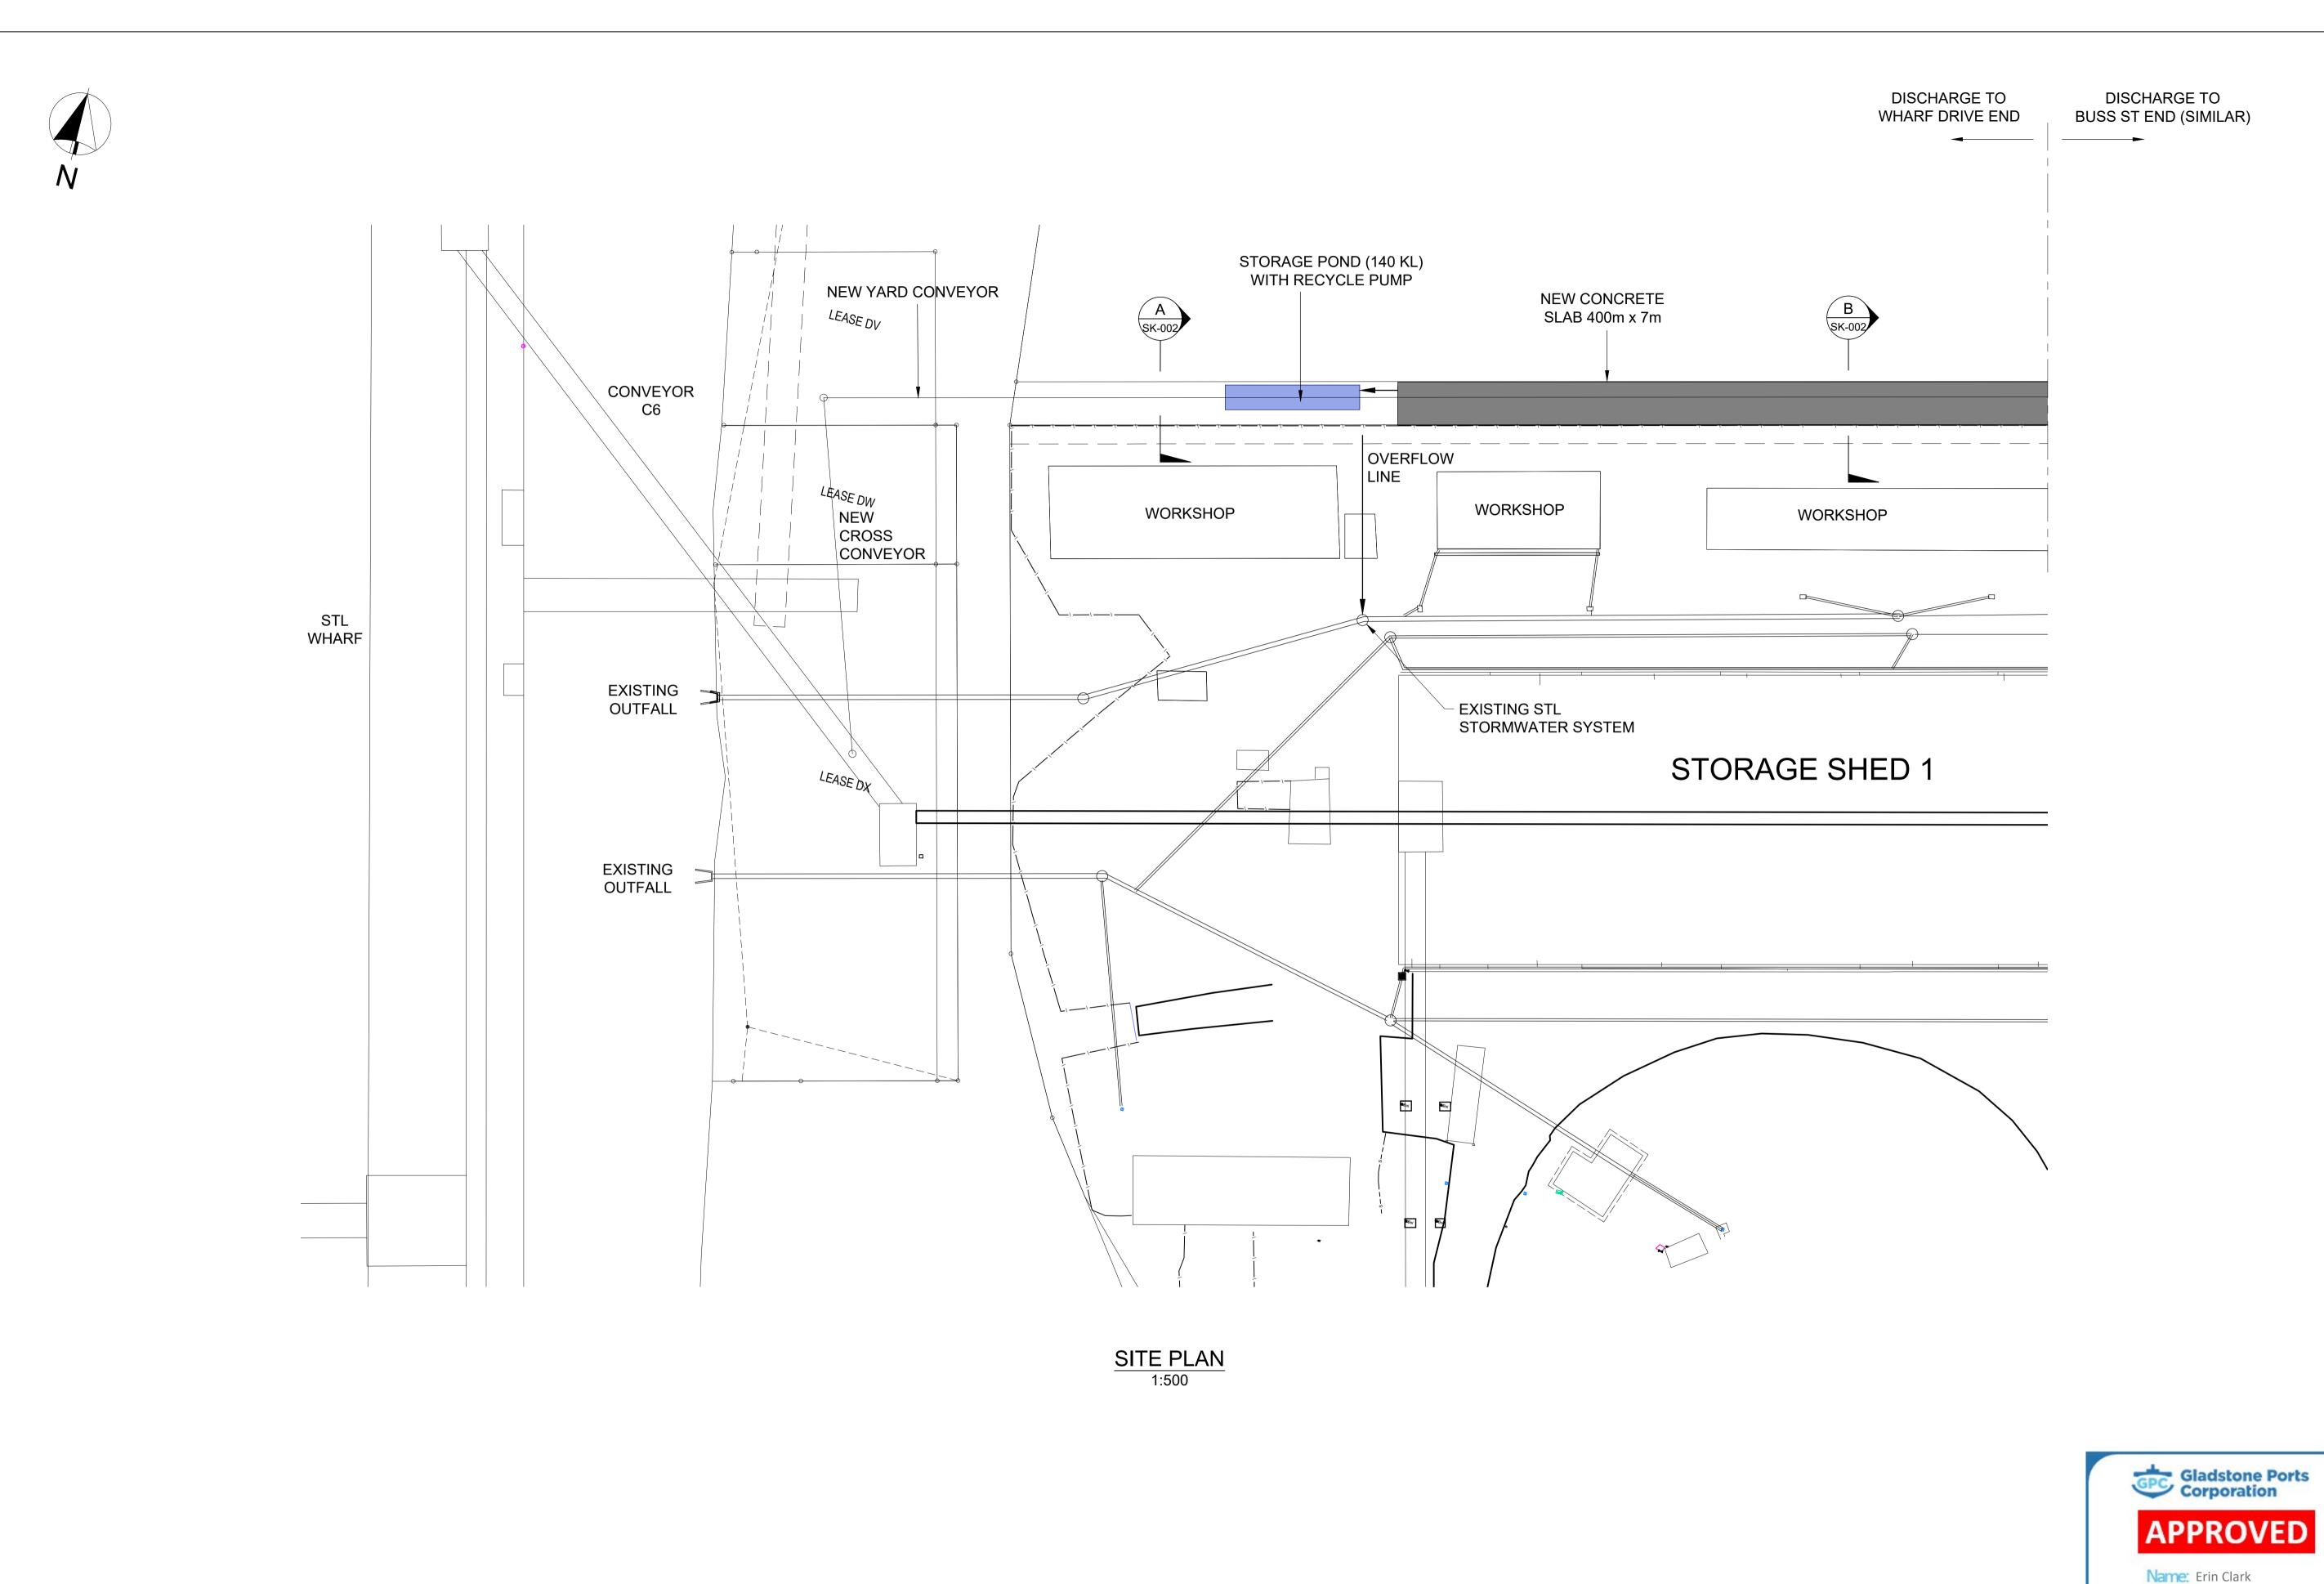



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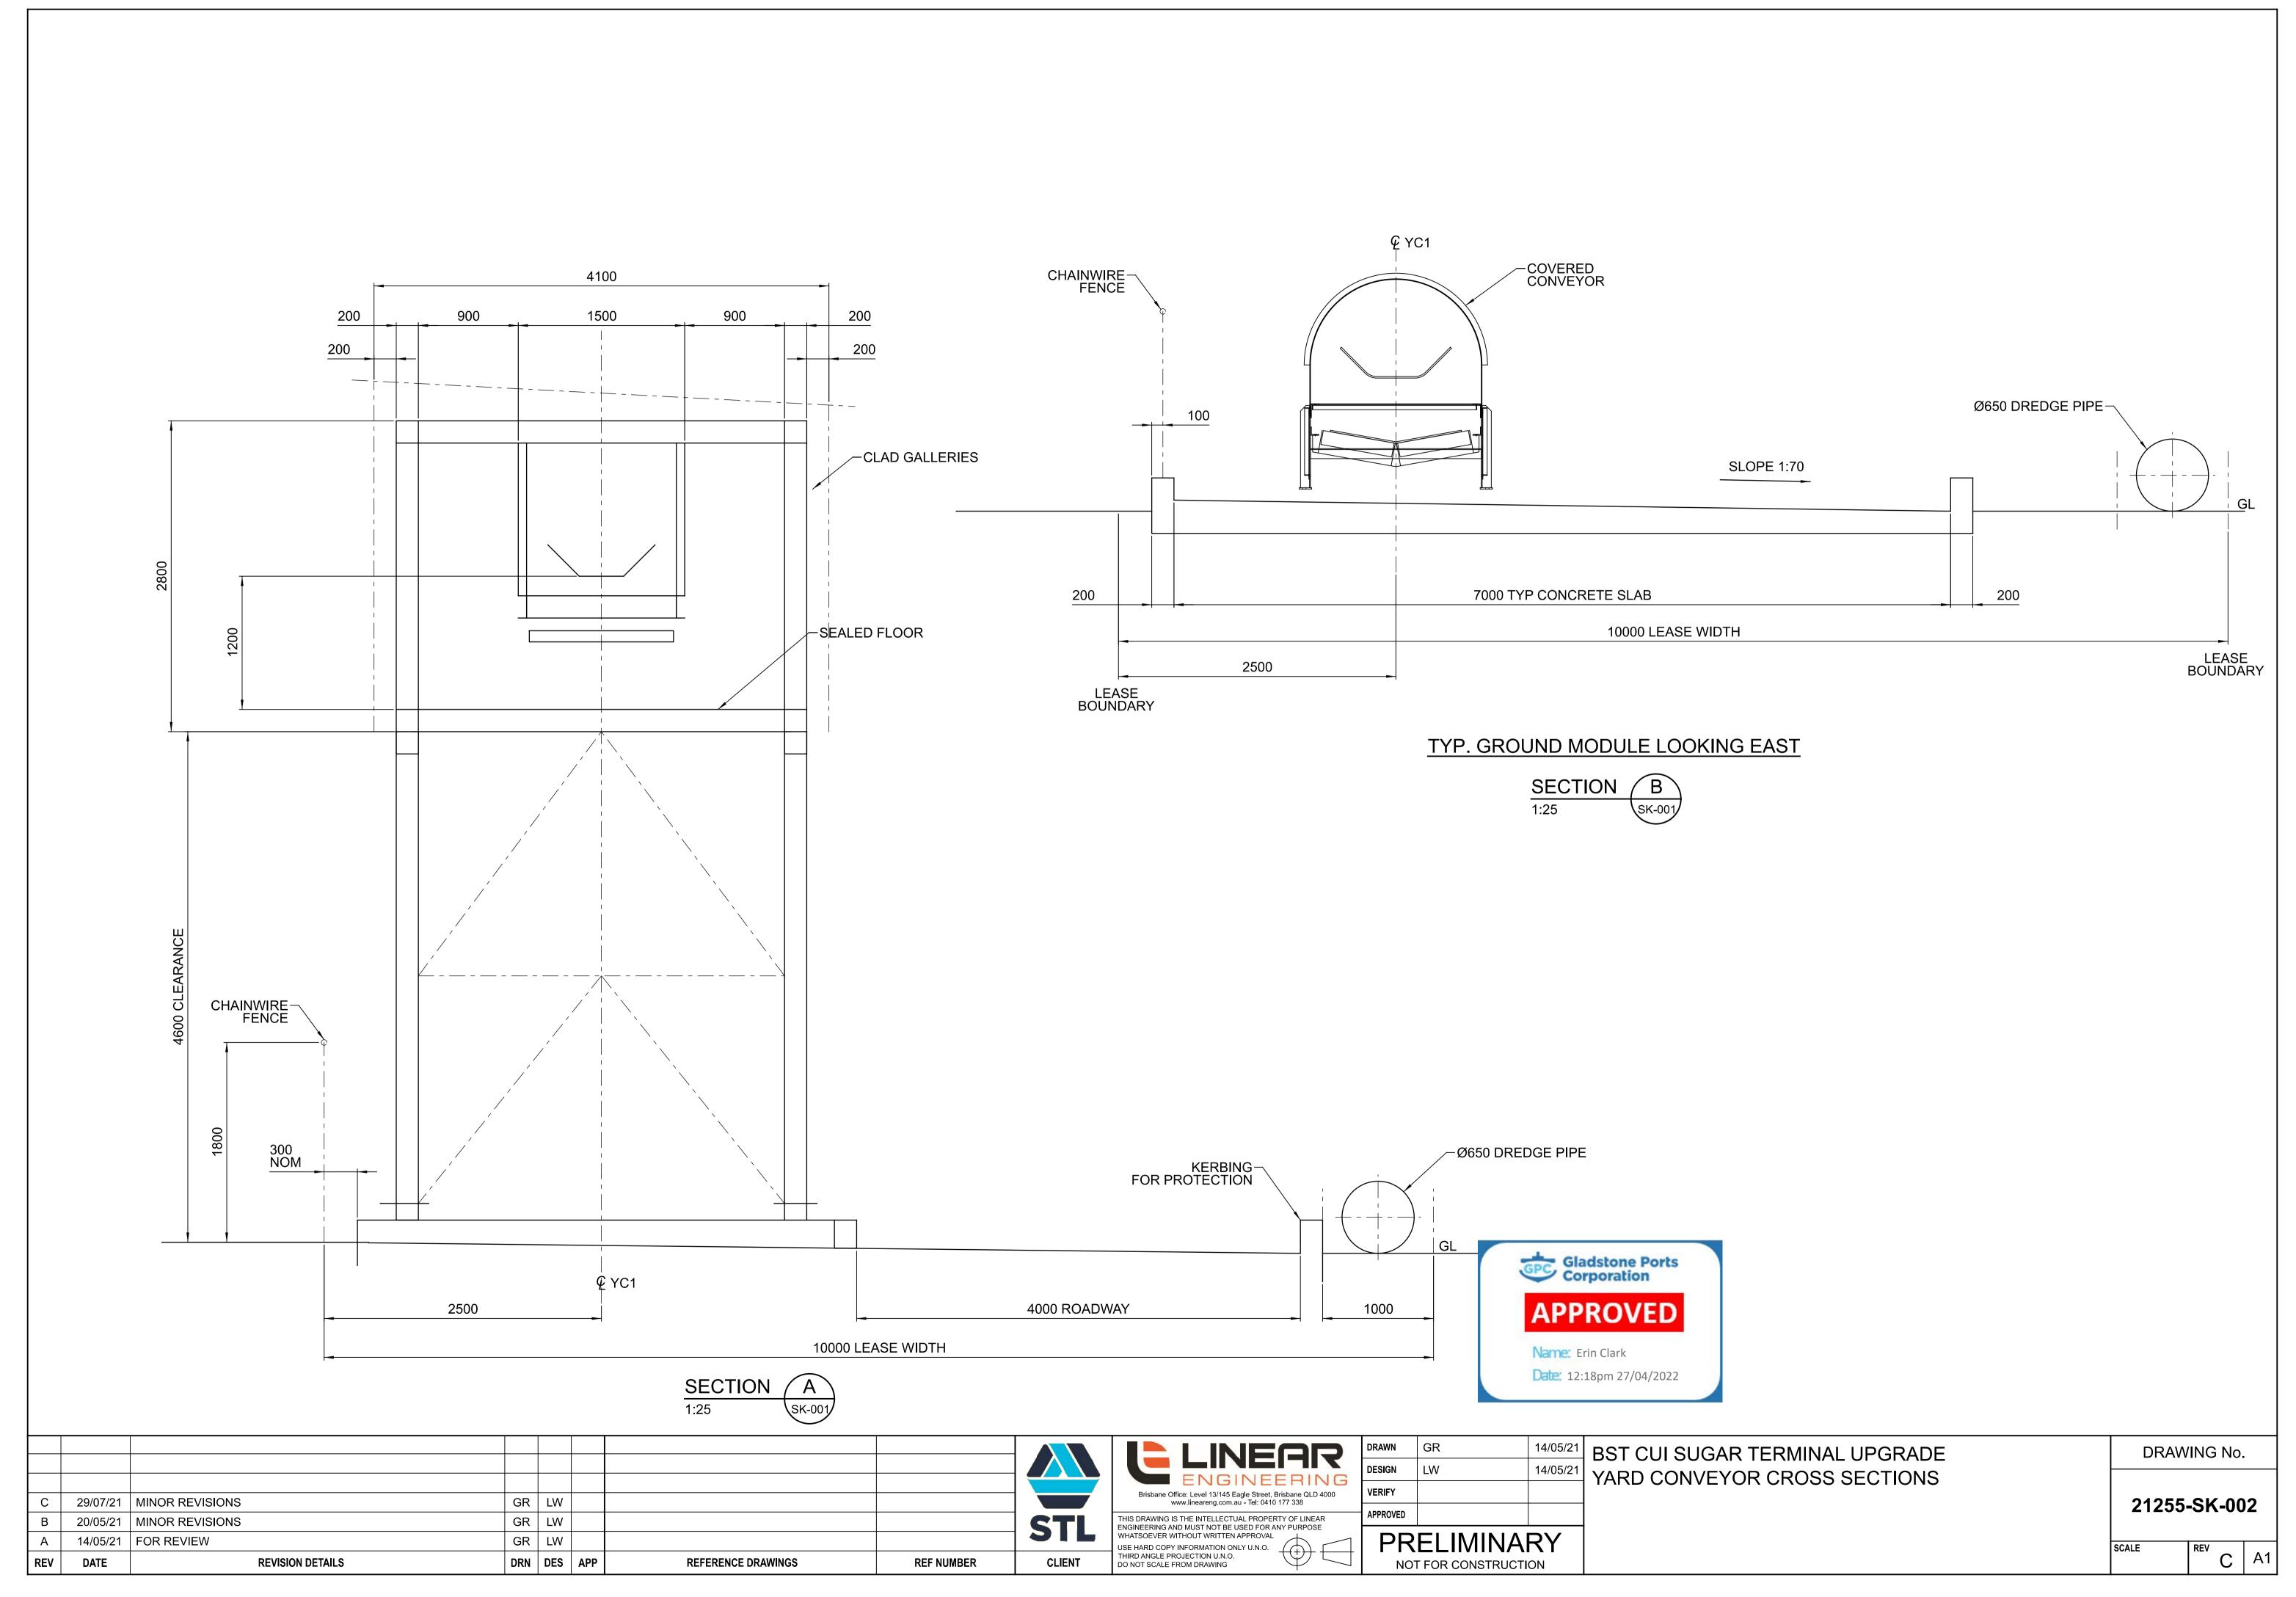
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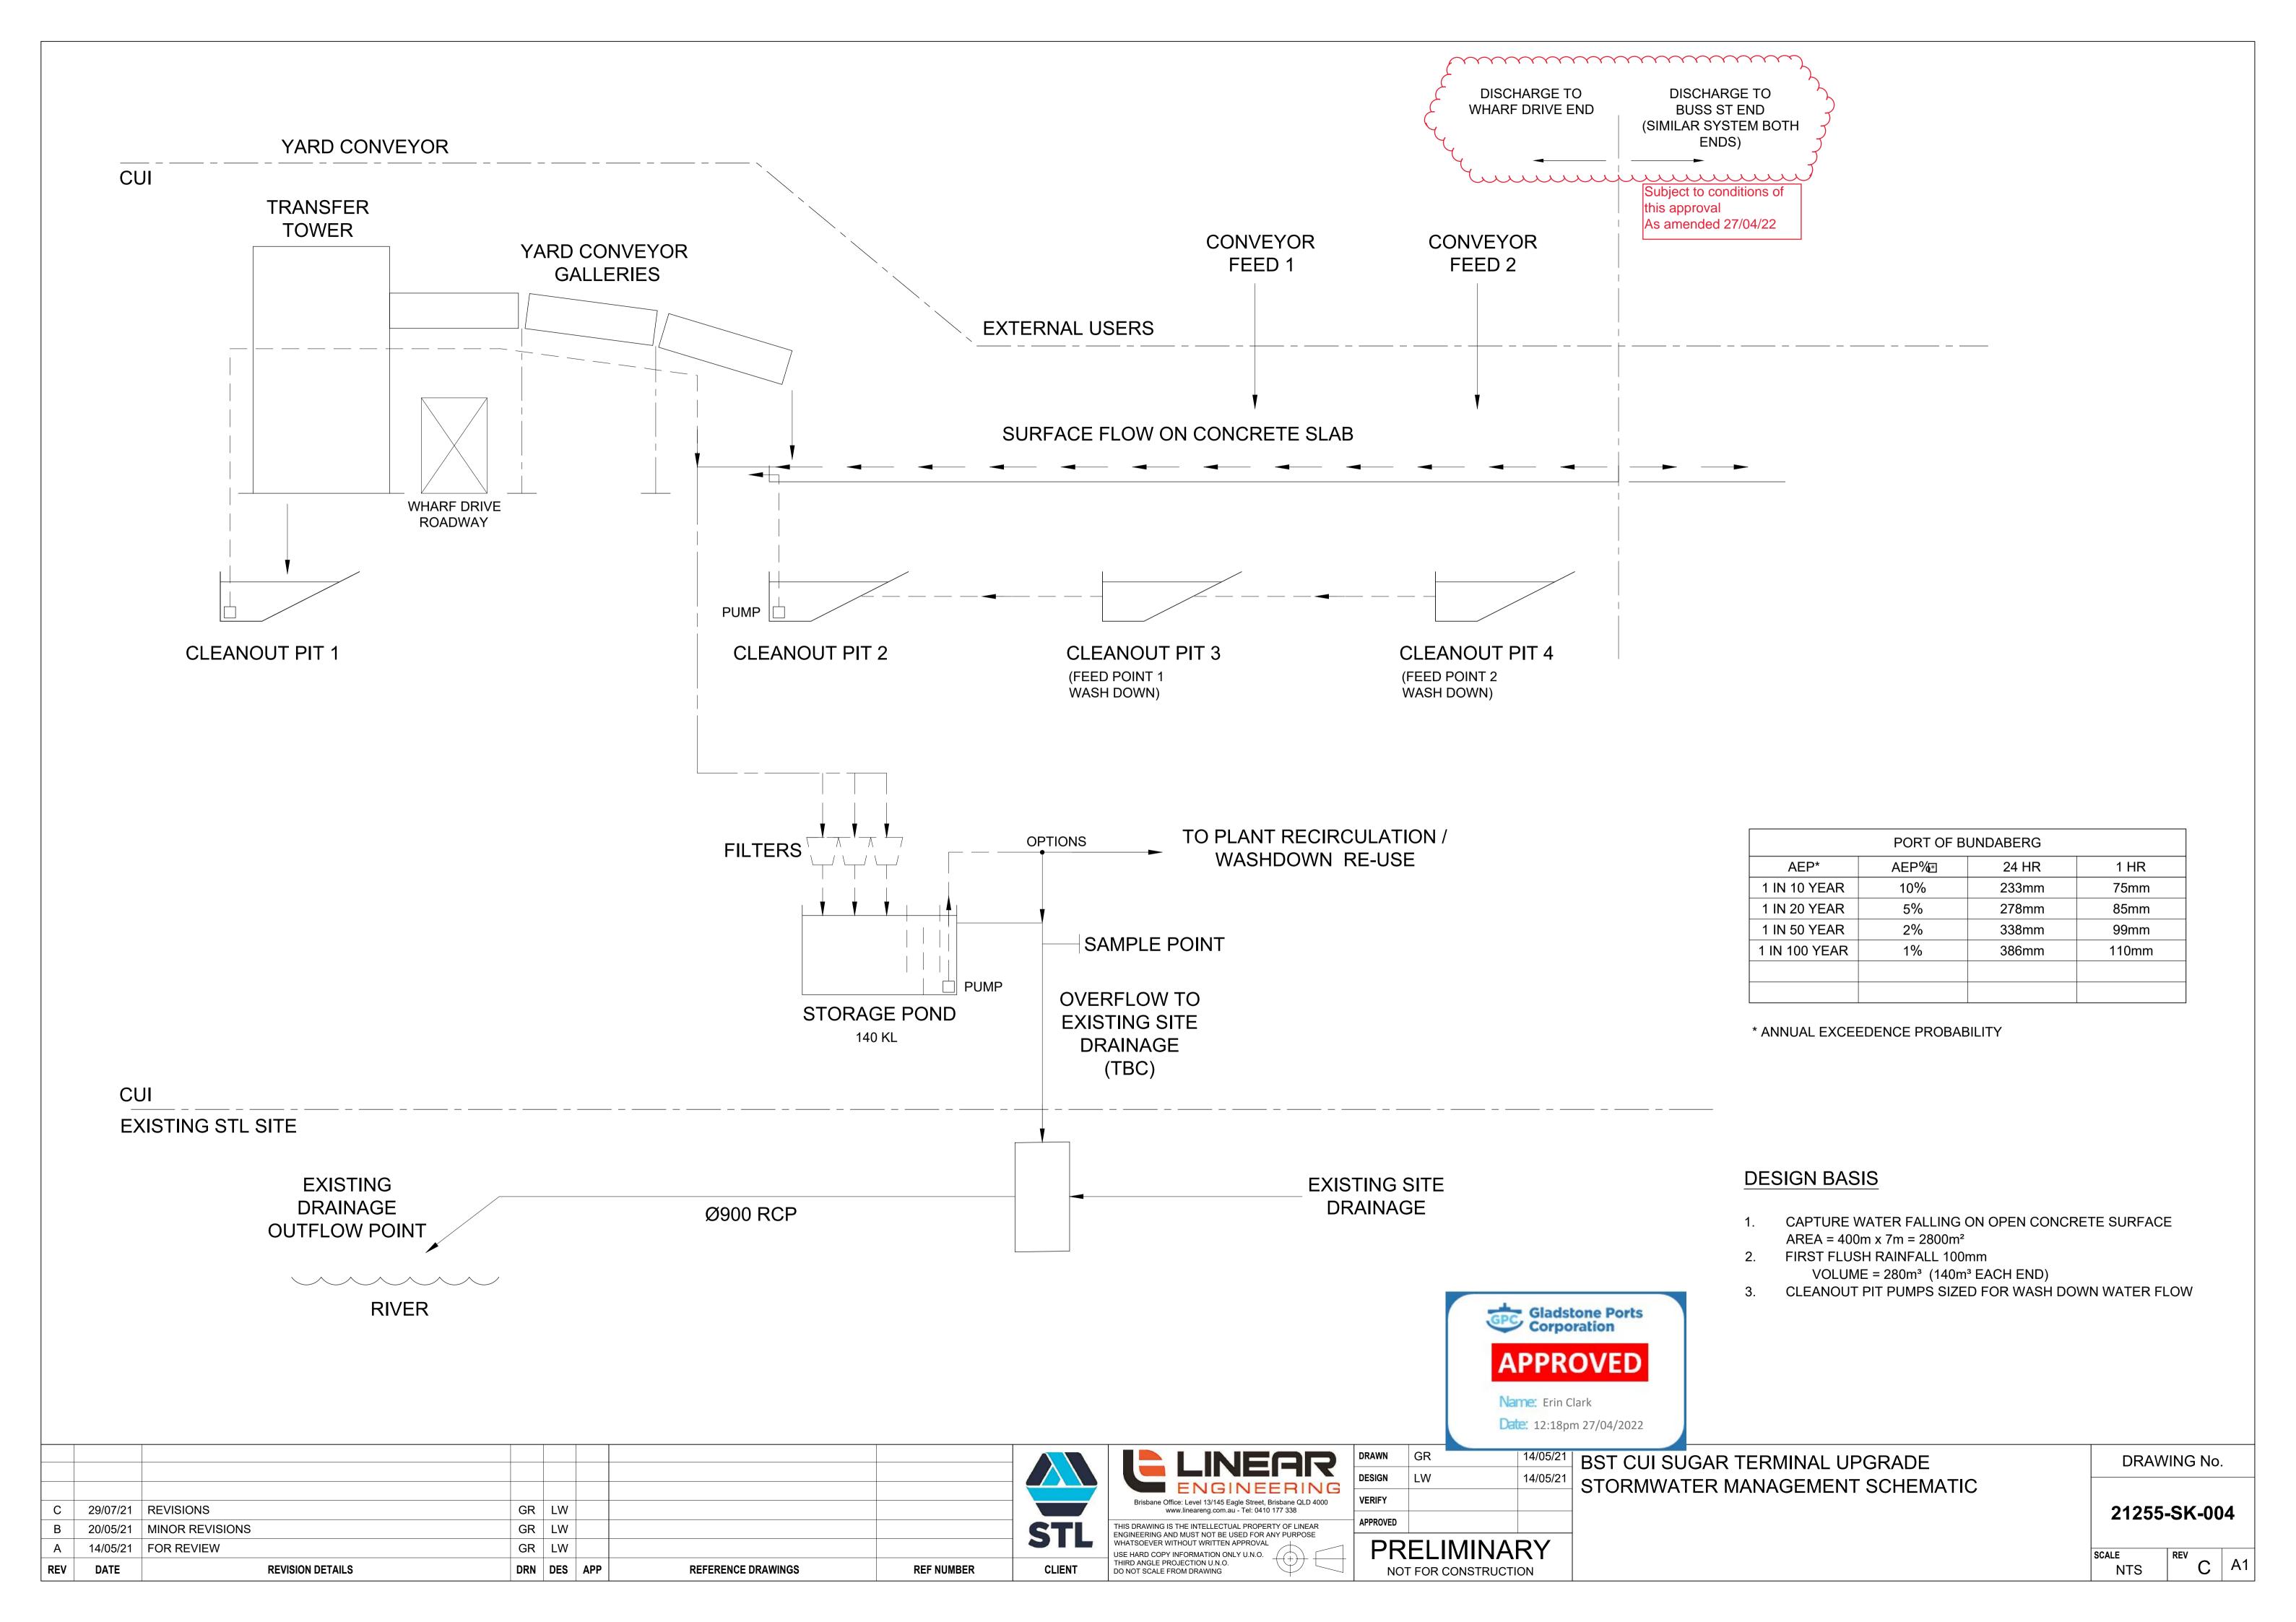
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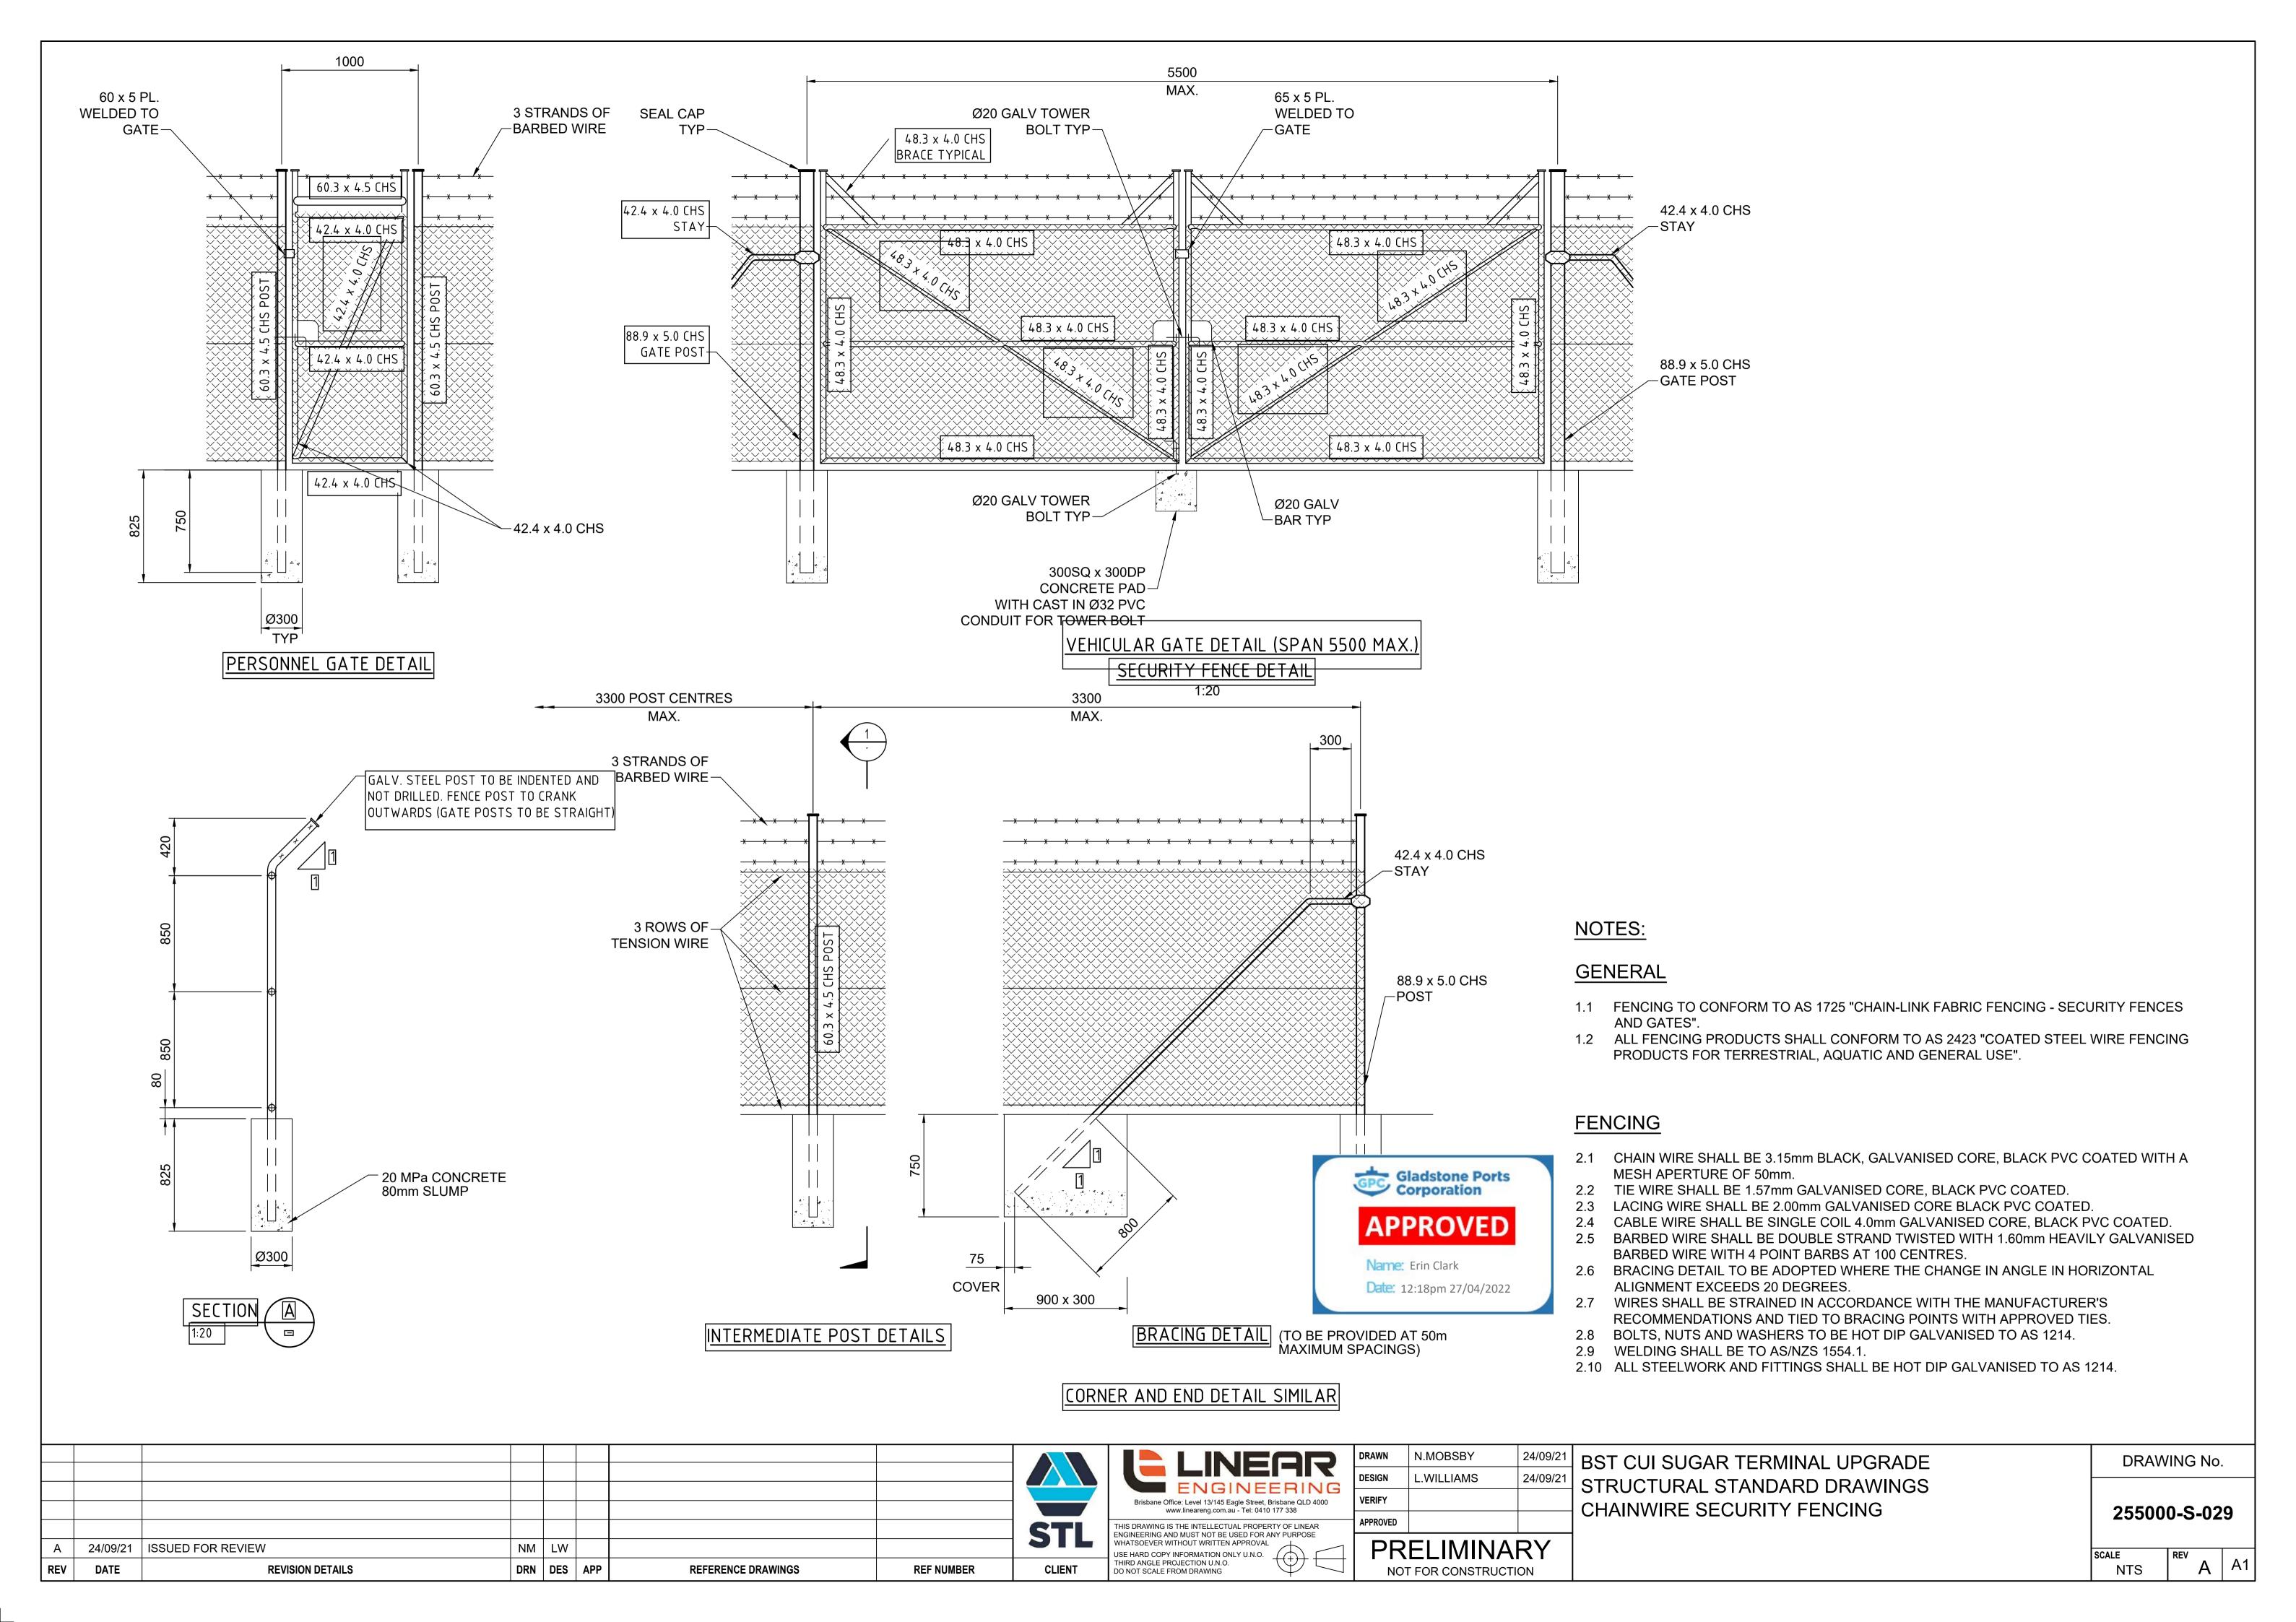
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<u>PLAN</u>

NOTES

BASIS OF SETOUT.
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 PSM 3853
 E 437586.809 N 7260217.502 Z 4.369
 PSM 36119
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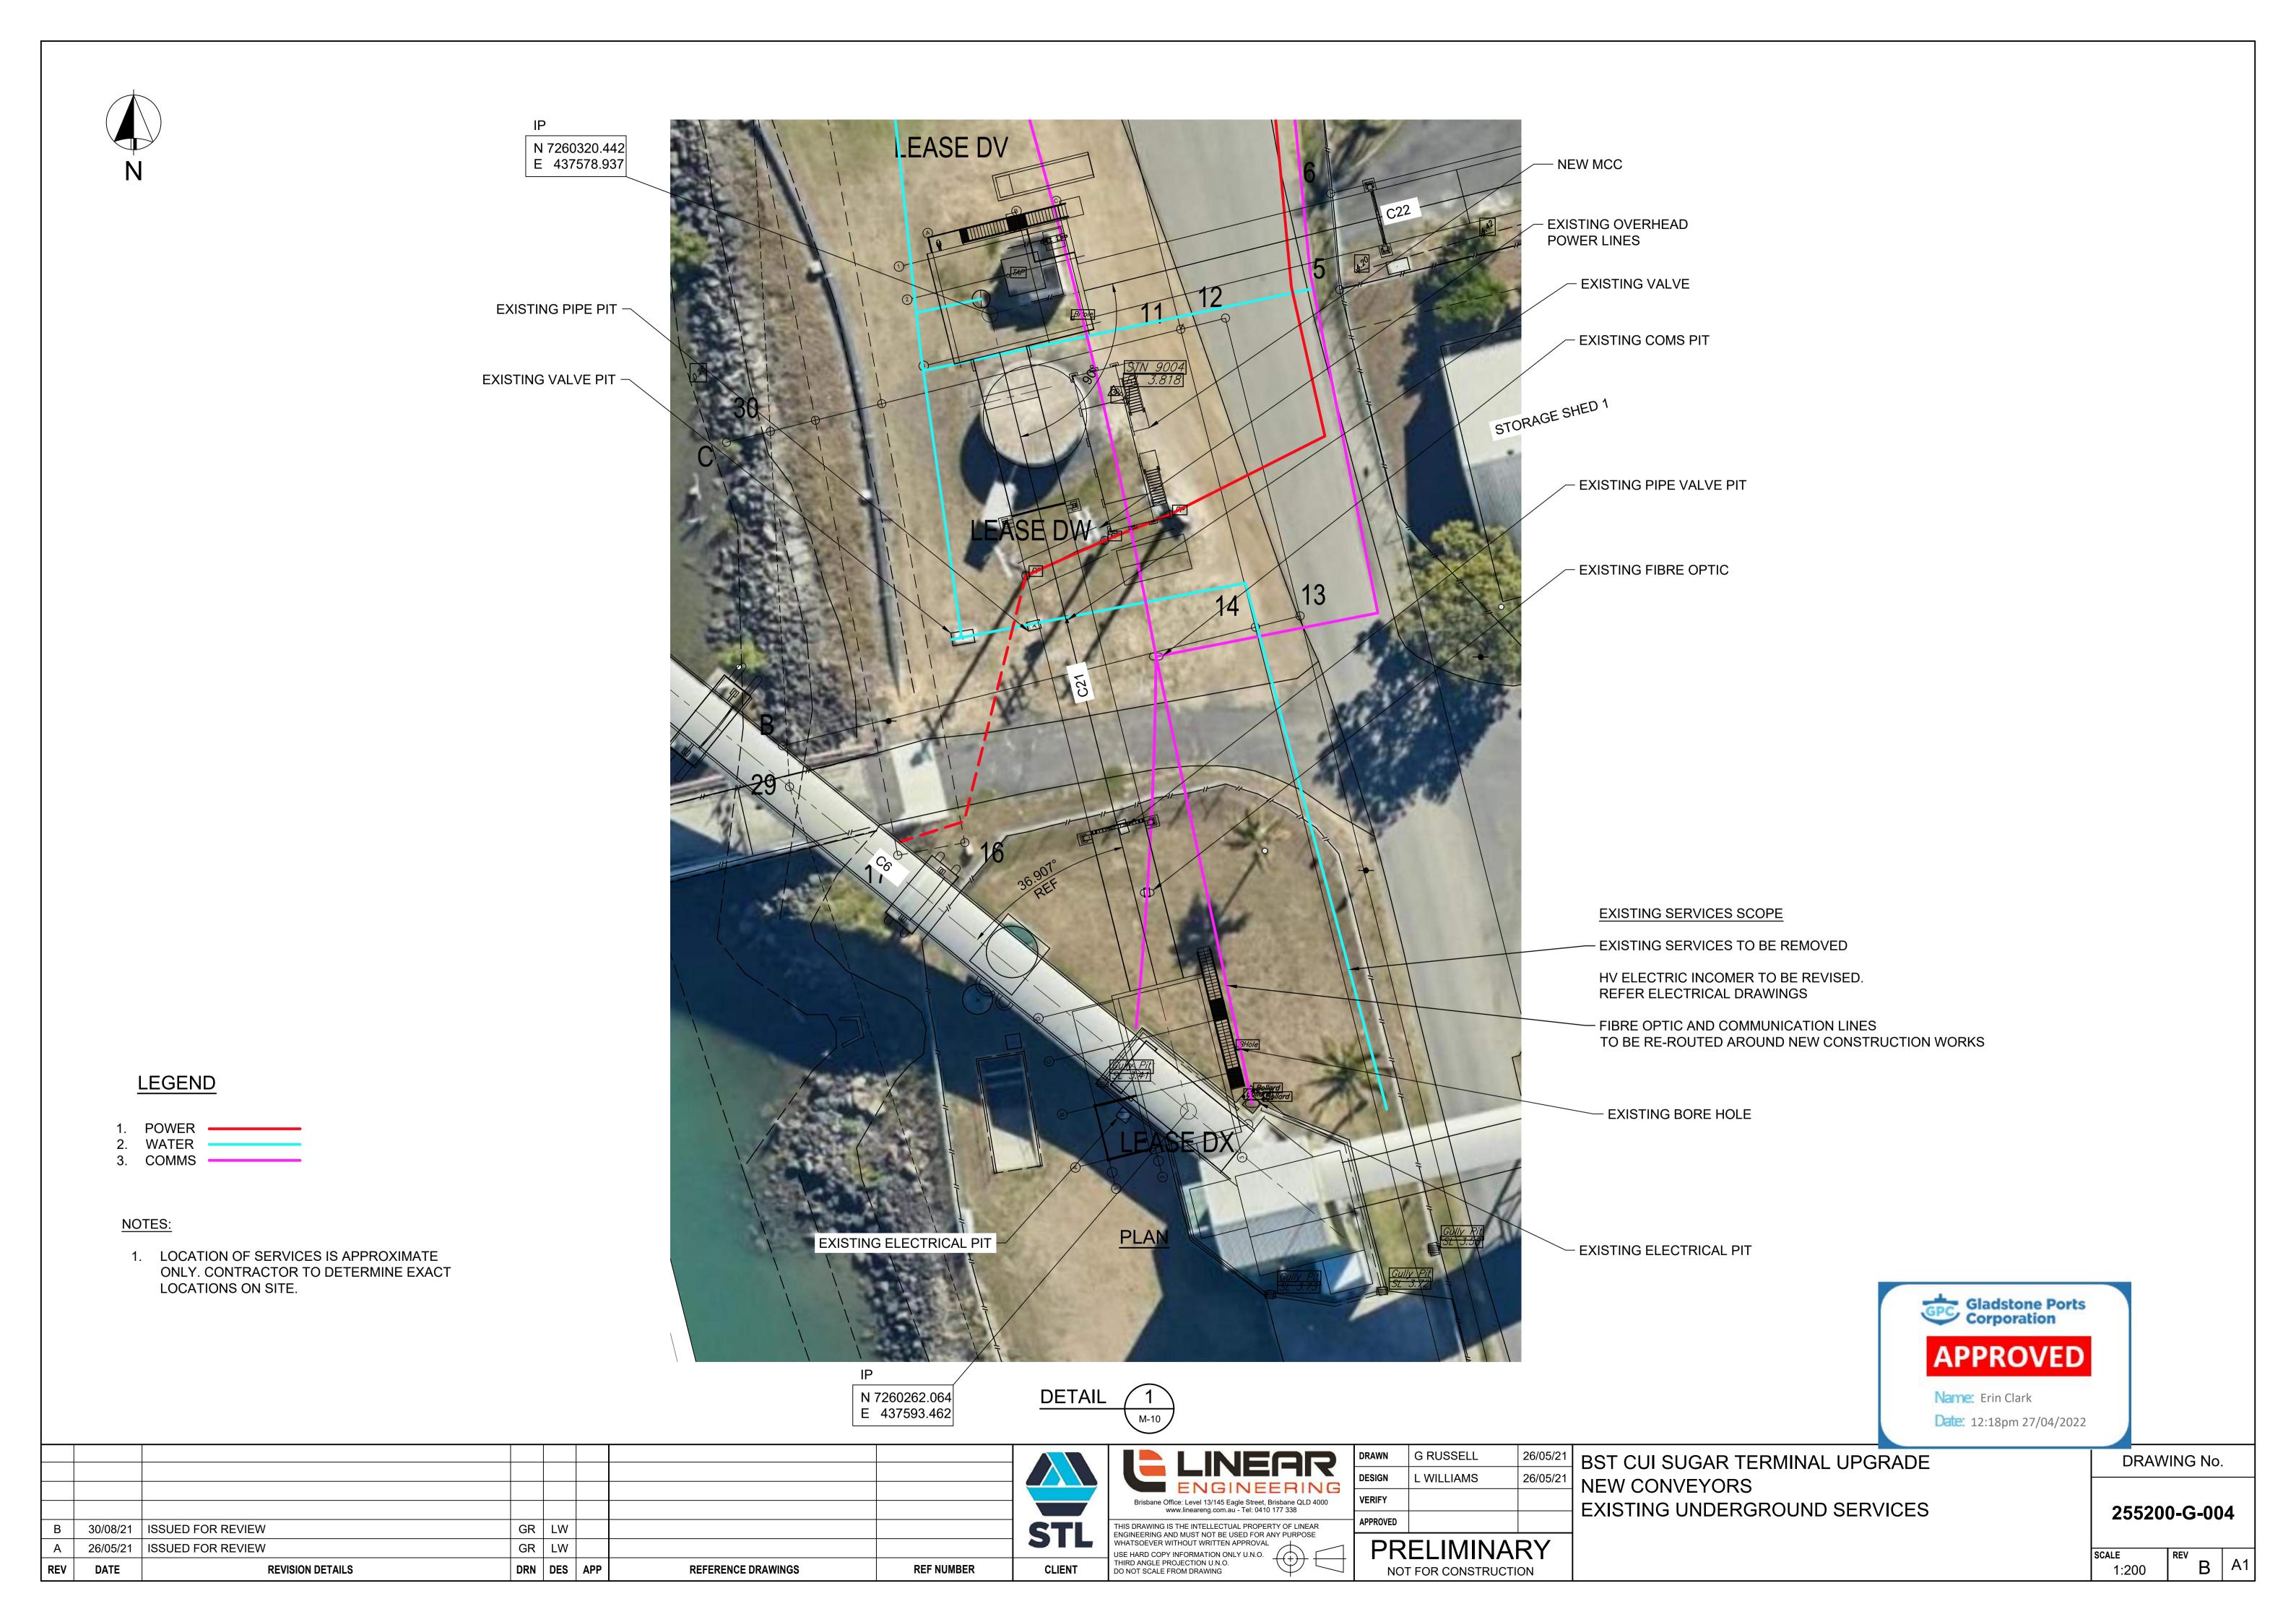
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NEW LEASE BOUNDARY

REFER TO DRG. 255200-G-009 FOR FENCING IN THIS AREA



<u>PLAN</u>



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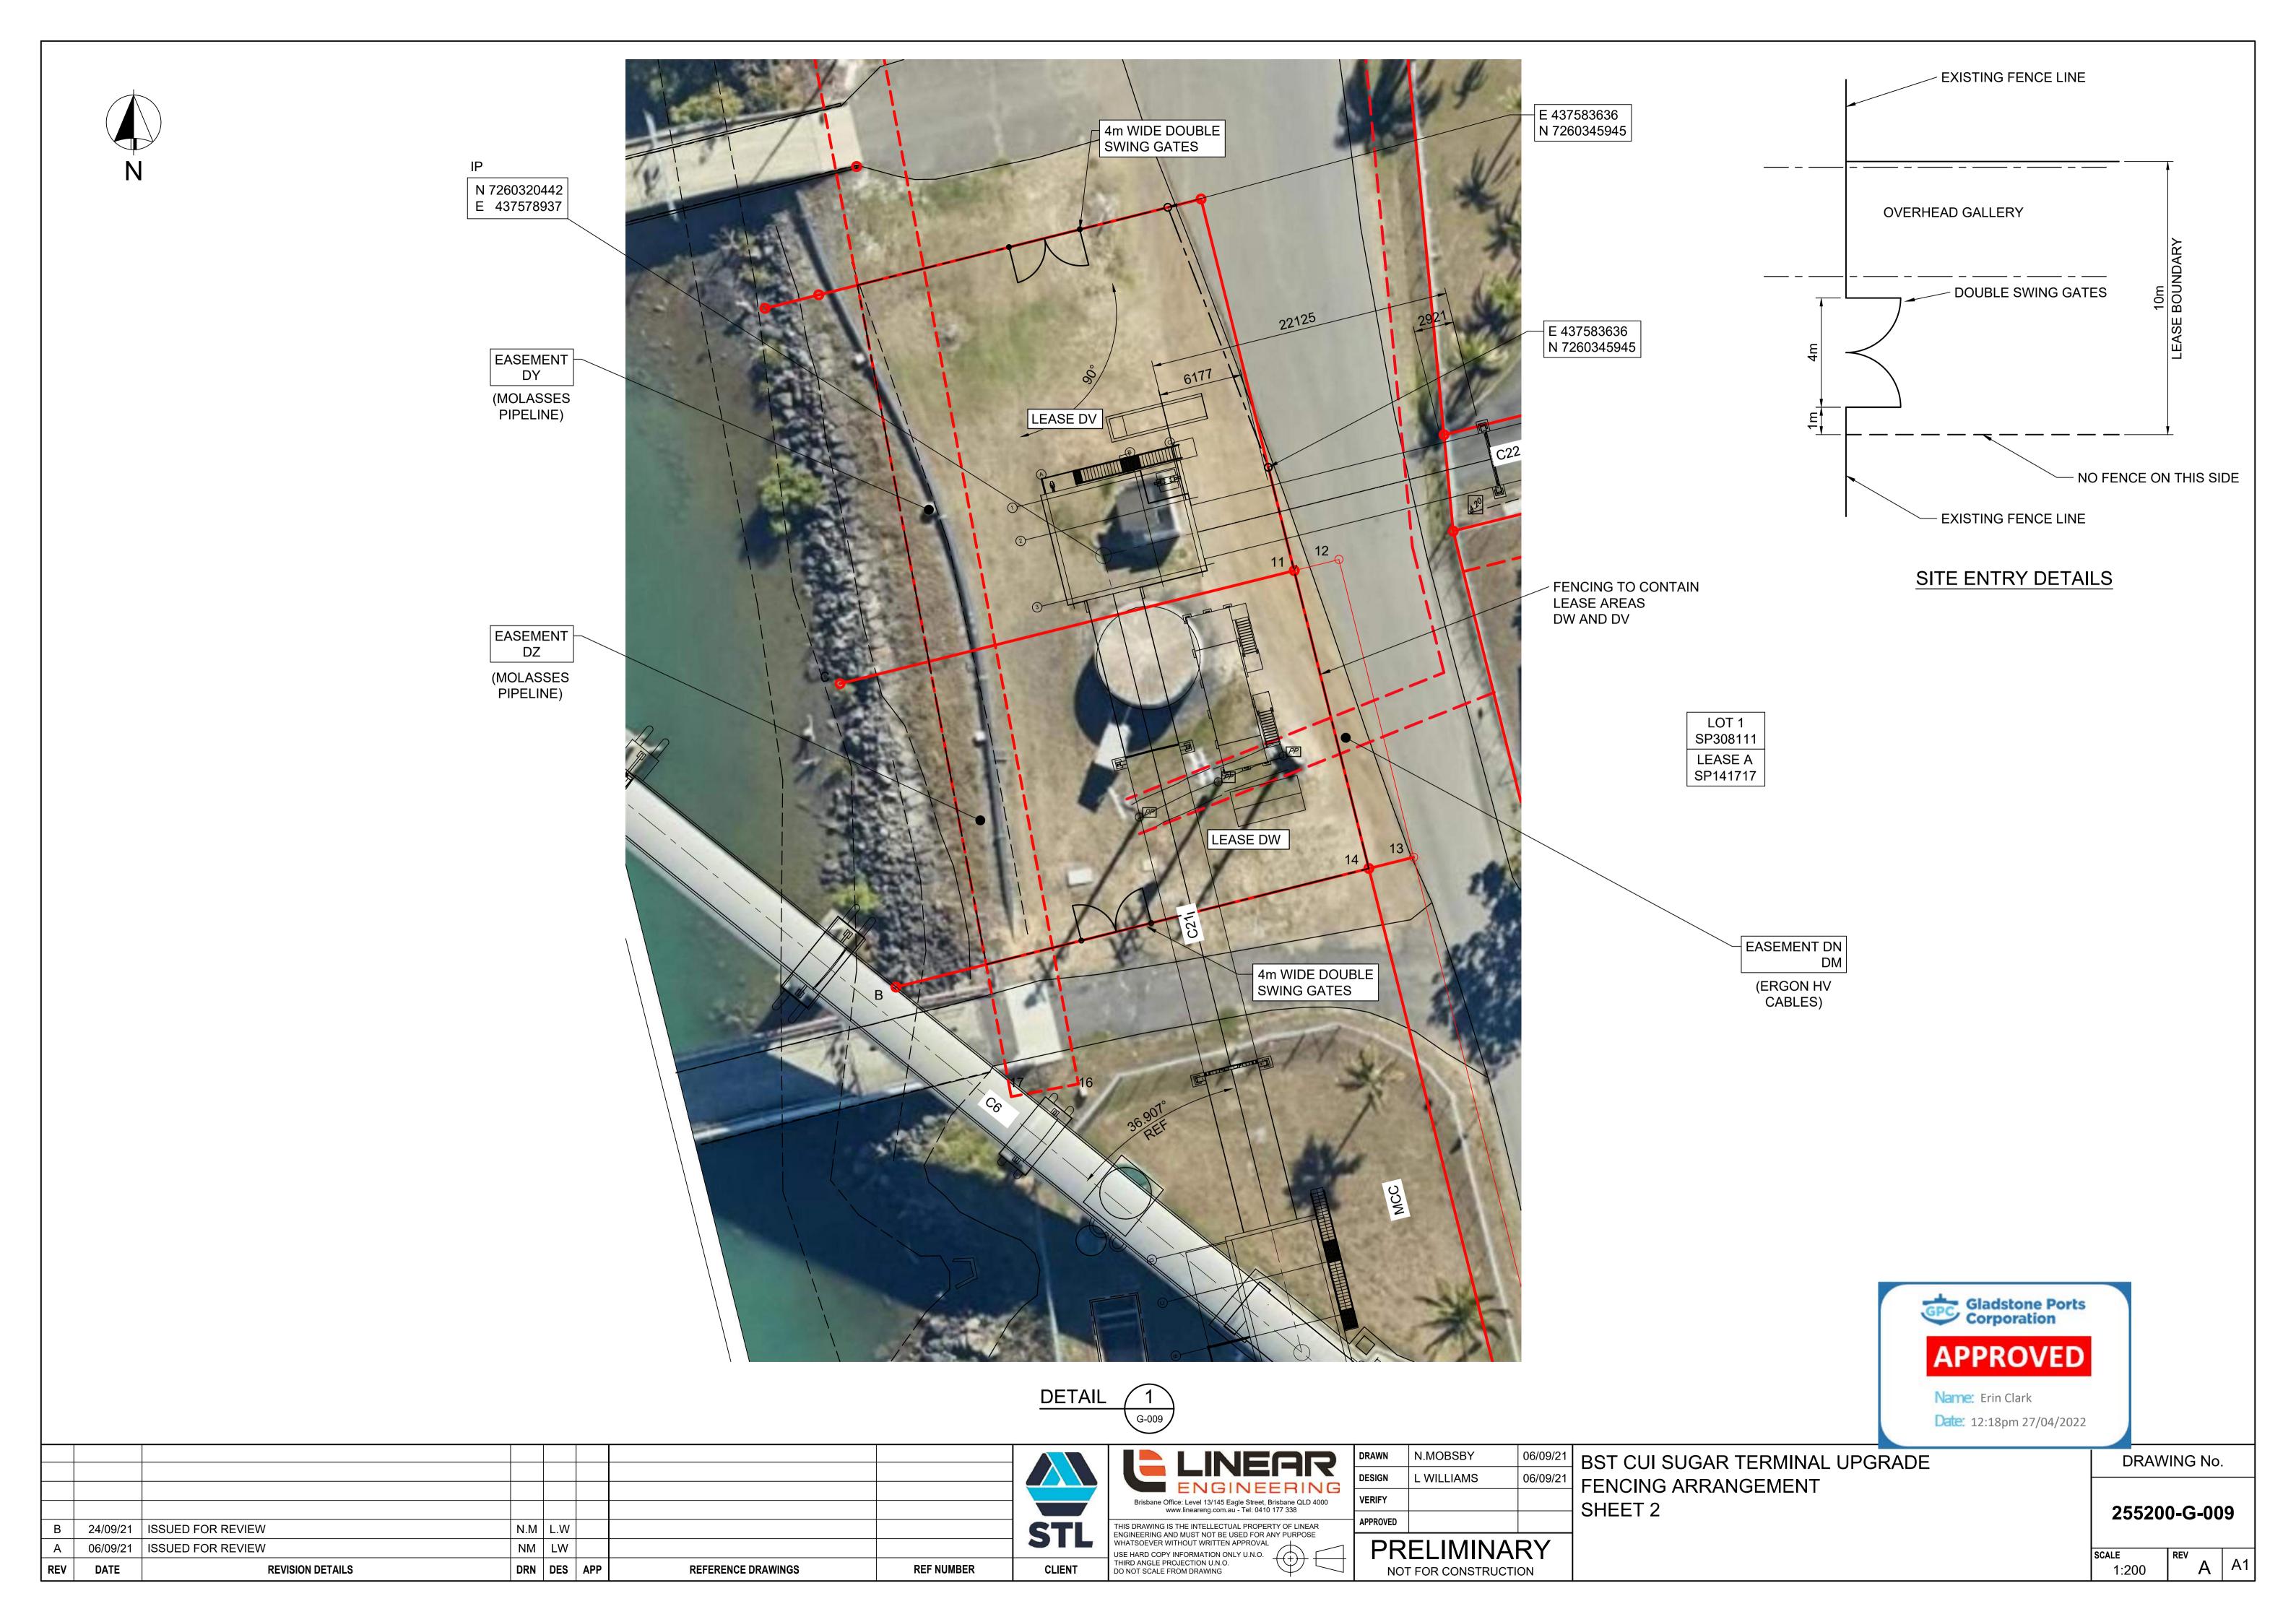


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C22 E 0275 m	ILMENITE :2000 WOODCHIP: 1350	NOMINAL: 3 ILMENITE: 2.5 (80%) WOODCHIP: 4 (130%) VSD CONTROL	1200	PN1000/4 COVERS 8+3 GRADE A EDGES CUT	570*	VSD WEG 185 kW (ILMENITE: 127.61 kW) (WOODCHIP: 97.26 kW) FOOT MOUNTED DRIVE BASE FRAME: D315S/M	SEW X3KS180eHUB 19.74:1 BEVEL HELICAL BASE MOUNTED OUTPUT TORQUE: 17.4 kNm C/W HOLDBACK	BRAKE TORQUE: 5kNm COREMO D-3N A2598 SPRING APPLIED, PNEUMATIC RELEASE	SAMIFLEX A55 DF JAW COUPLING TORQUE RATING: 1725 Nm BRAKE DISC: 500 mm Ø: 25.4 mm THICKNESS	SAMIFLEX A10 JAW COUPLING TORQUE RATING: 27.5 kNm	HEAD /DRIVE Ø800 mm LT Ø630 mm	6000 HORIZONTAL GRAVITY
C21 63 m	ILMENITE :2000 WOODCHIP: 1350	NOMINAL: 3 ILMENITE: 2.5 (80%) WOODCHIP: 4 (130%) VSD CONTROL	1200	PN1000/4 COVERS 8+3 GRADE A EDGES CUT	140*	VSD WEG 90 kW (ILMENITE: 58.47 kW) WOODCHIP: 51.82 kW) FOOT MOUNTED DRIVE BASE FRAME: D280S/M	SEW X3KS160eHUB 20.23:1 BEVEL-HELICAL BASE MOUNTED OUTPUT TORQUE: 8.9 kNm C/W HOLDBACK	BRAKE TORQUE: 3 kNm COREMO D-2N A2566 SPRING APPLIED PNEUMATIC RELEASE	SAMIFLEX A55 DF JAW COUPLING TORQUE RATING: 1725 Nm BRAKE DISC: 500mm Ø: 25.4mm THICKNESS	SAMIFLEX A9 JAW COUPLING TORQUE RATING: 13.75 kNm	HEAD /DRIVE Ø800 mm LT Ø630 mm	6000 VERTICAL GRAVITY

IDLERS								
		STD CARRY	STD RETURN	TRANSITION	TRANSITION	RETRACTABLE	RETURN TRAINING	
		3 EQUAL ROLL 45° TROUGH Ø152mm POLYMER ROLL 6305 BEARINGS	SINGLE FLAT ROLL Ø152mm POLYMER ROLL 6205 BEARINGS	3 EQUAL ROLL 22-45° TROUGH Ø152mm POLYMER ROLL 6305 BEARINGS	3 EQUAL ROLL 45° TROUGH Ø152mm POLYMER ROLL 6305 BEARINGS	3 EQUAL ROLL 45° TROUGH Ø152mm POLYMER ROLL 6305 BEARINGS	SINGLE FLAT ROLL Ø152 POLYMER ROLL 6205 BEARINGS	
TOTAL	C21	30	18	2	2	20	2	
AMOUNT	C22	200	90	2	2	10	6	

- 1. CAPACITIES BASED ON THE FOLLOWING MATERIAL DENSITY:

- ILMENITE 2570 kg/m³
 WOODCHIP 500 kg/m³
 FINAL LENGTH OF BELT TO BE CONFIRMED.
- 3. FINAL QUANTITY OF IDLERS TO BE CONFIRMED.

GPC Gladsi Corpo	tone Ports ration
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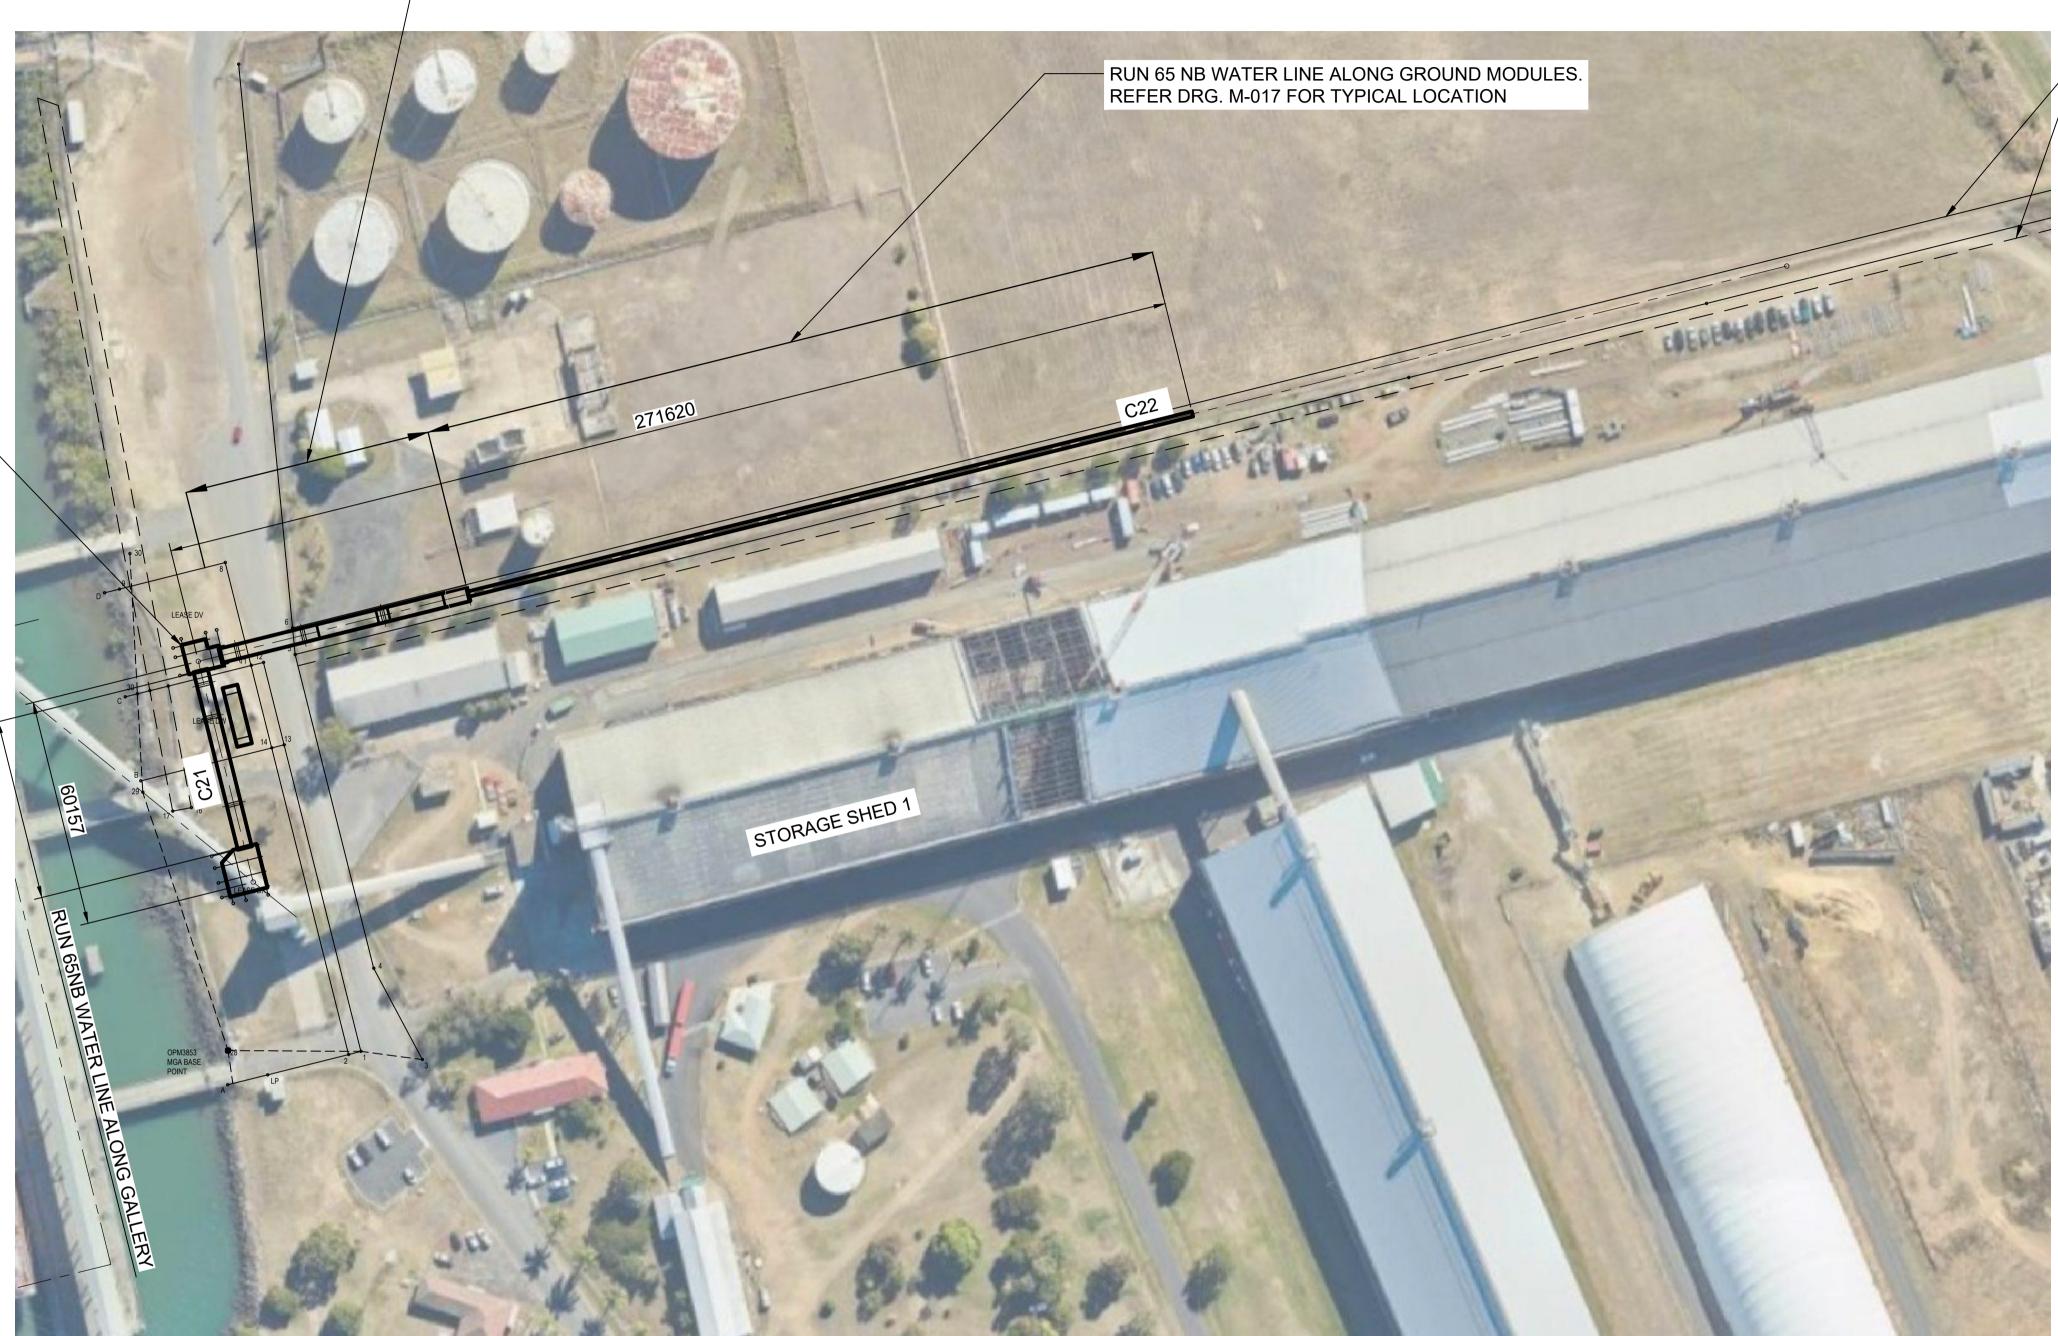
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CONNECT TO GPC — WATER LINE IN

MOLASSES PIPELINE EASEMENT

RUN 65 NB WATER LINE ALONG GALLERY.
REFER DRG. M-017 FOR TYPICAL LOCATION



- NEW LEASE BOUNDARY

GENERAL NOTES:

- 1. REFER DRG. P-012 FOR SCHEMATIC & DETAILS.
- SITE RUN WATER LINES.
 PIPING TO BE GALVANISED STANDARD WALL PIPE WITH SCREWED CONNECTIONS.

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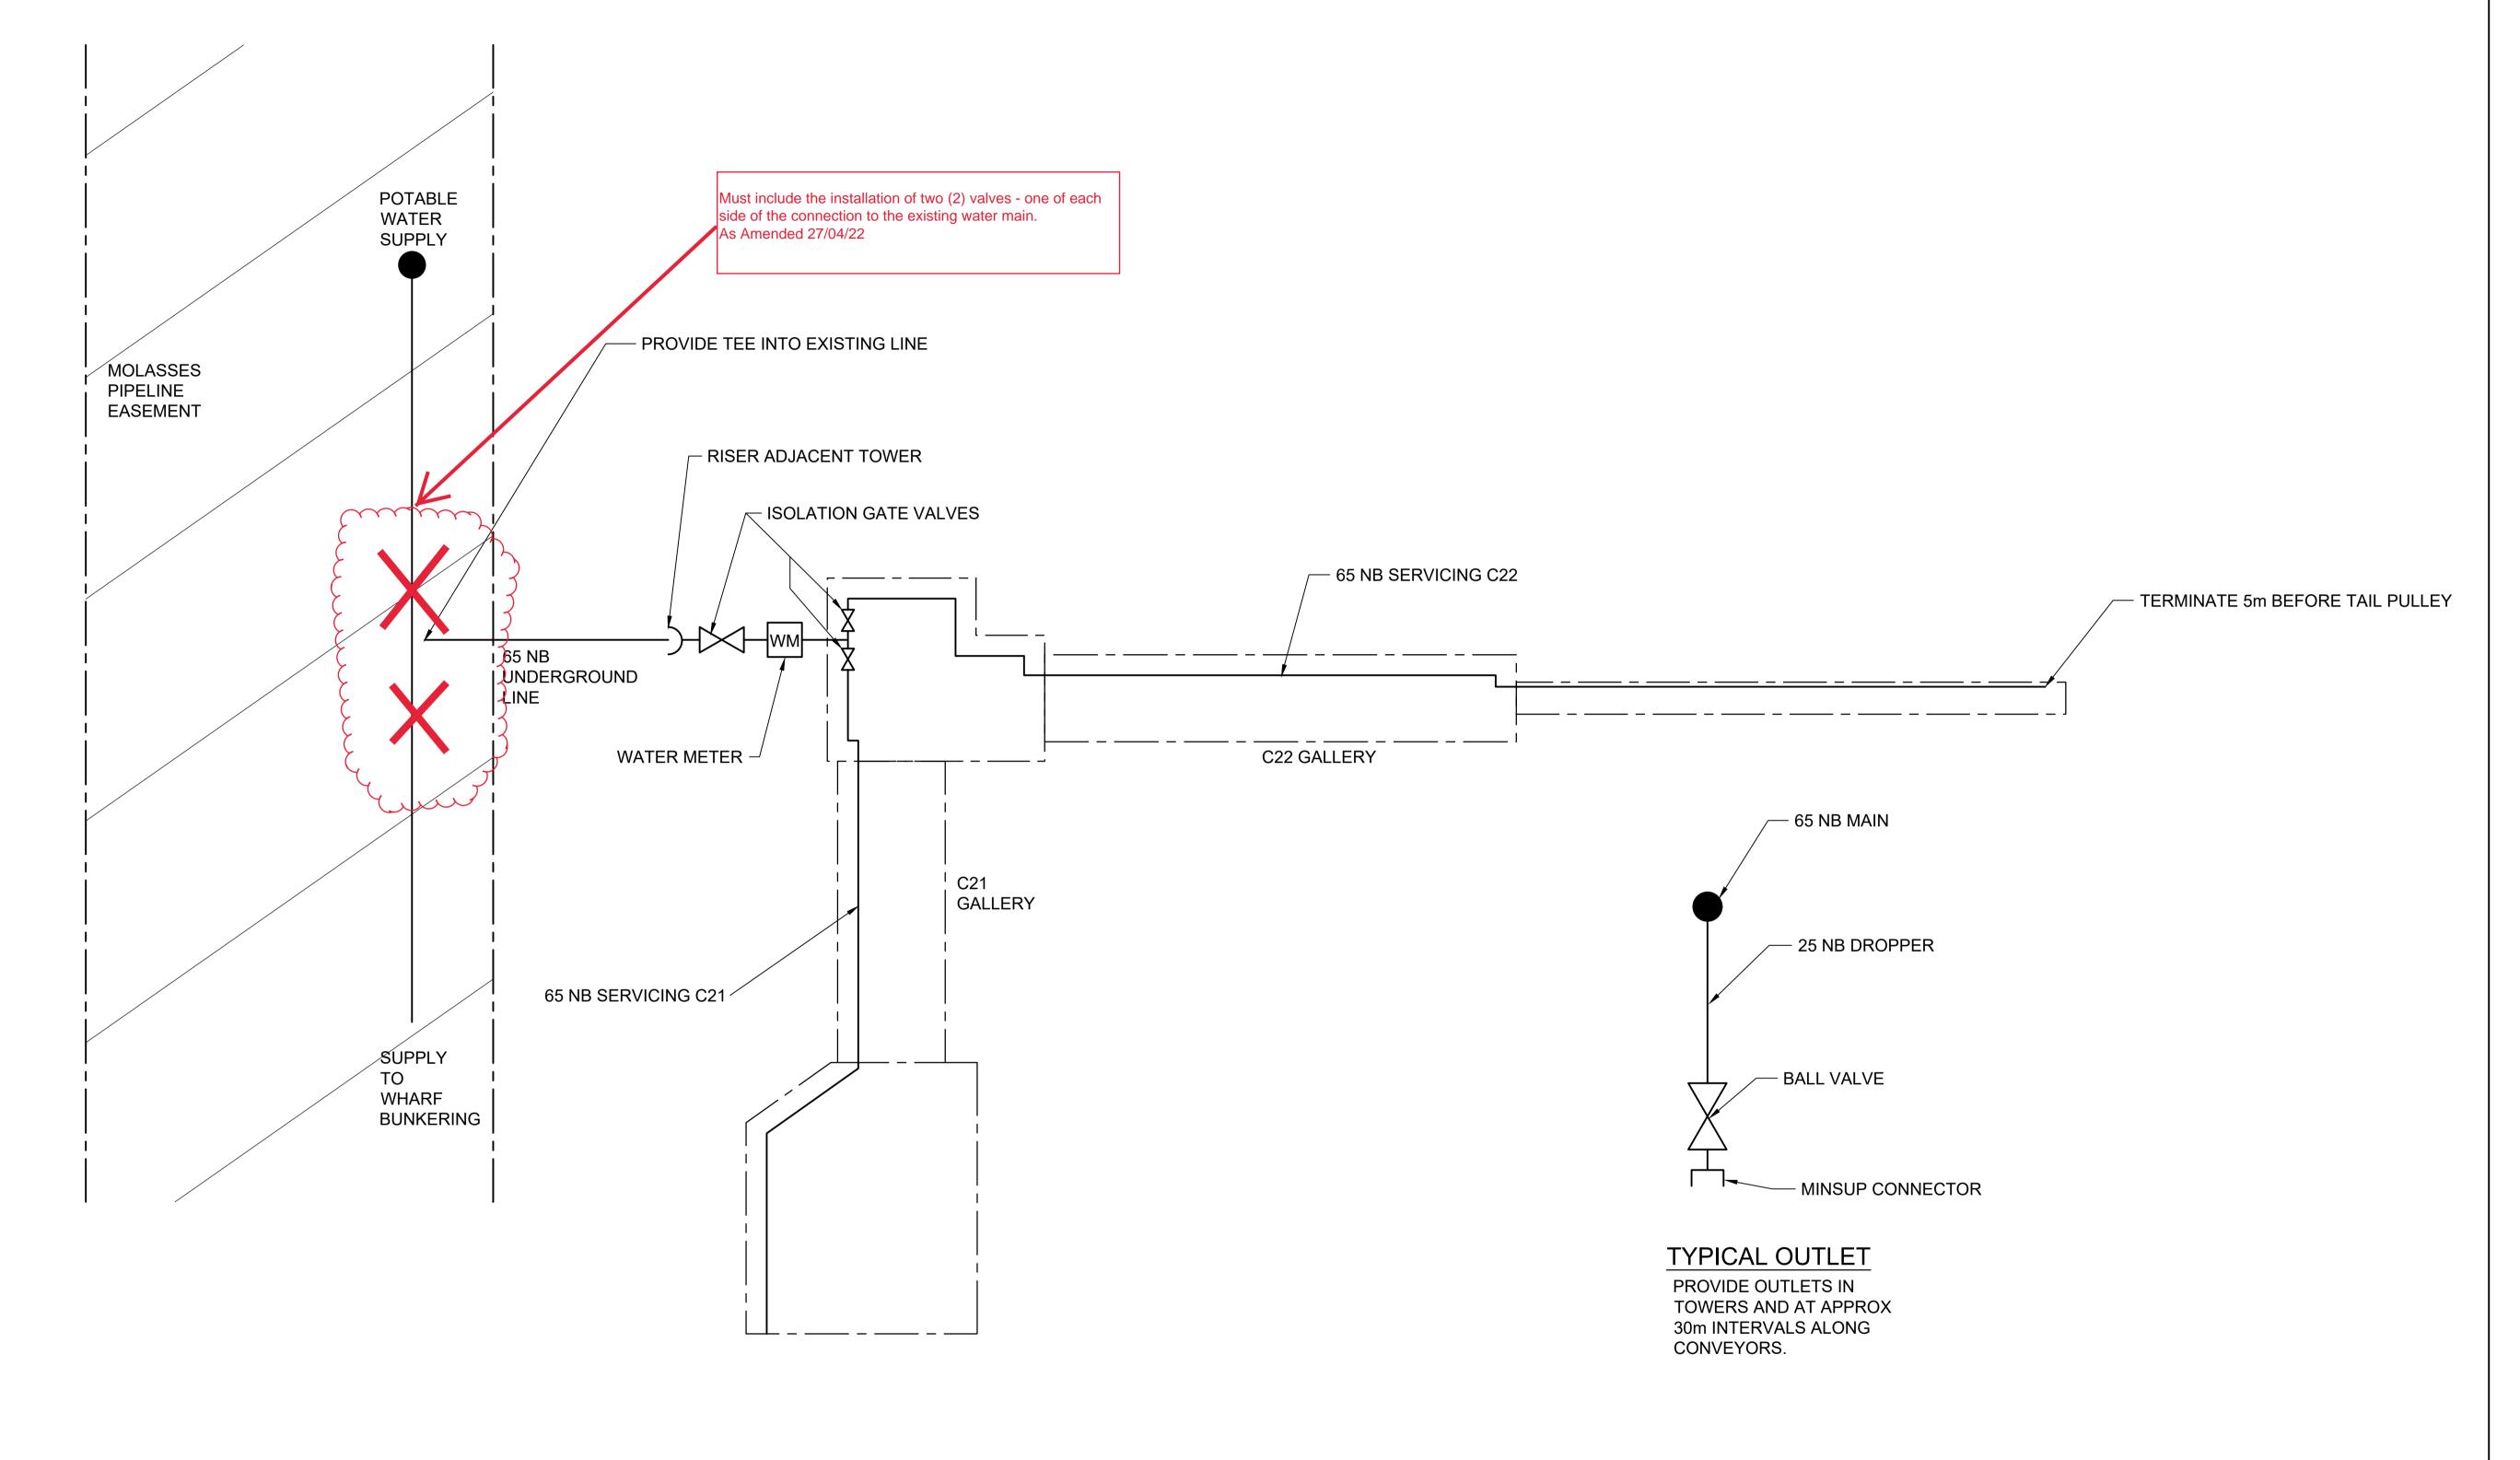
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/21	STL CUI SUGAR TERMINAL UPGRADE
/21	STL CUI SUGAR TERMINAL UPGRADE SERVICES POTABLE WATER DETAILS
	POTABLE WATER DETAILS

DRAWING No.
255200-P-012

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MAIN ALONG 65 NB

SPRINKLERS REQUIRED:

C22 GALLERIES

C22/C21 TRANSFER TOWER

- C21/C6 TRANSFER TOWER

C21 GALLERIES

EXISTING -CONVEYOR C6

NEW SPRINKLER

NEW GALLERY

SECTIONS.

CONNECT TO **EXISTING MAIN** SPRINKLER SUPPLY PIPE IN C6 GALLERY

NEW U/G HYDRANT LINE ADJACENT TO ROADWAY HYDRANT RISERS EVERY 60m 150NB UNDERGOUND LINE TO OLD TANK AREA CONNECTION TO EXISTING FIRE LINE HOSEREELS STORAGE SHED 1

- NEW LEASE BOUNDARY

⊗ FIRE HYDRANT

✓ STOP VALVE

GENERAL NOTES:

- 1. NOTIFY ENGINEER IF DISCREPANCY IS NOTED 2. UNDERGROUND PIPEWORK SHALL BE
- INSTALLED IN ACCORDANCE WITH AS2419.1, AS3500.1 AND MANUFACTURERS RECOMMENDATIONS
- 3. WRAP ALL UNDERGROUND STEEL PIPE SECTIONS WITH DENSO PETROLEUM TAPE
- 4. PIPEWORK BELOW GROUND SHALL BE RESTRAINED BY THRUST BLOCKS AT: A. TERMINATION OF PIPEWORK
 - B. AT VALVES
 - C. AT THE REDUCING FITTING IN THE DIRECTION OF SMALLER PIPE
 - D. AT ALL TEE JUNCTIONS AND BENDS
- 5. ALL ABOVE GROUND PIPE SHALL BE GALVANIZED STEEL IN ACCORDANCE WITH AS2419.1
- 6. ALL ABOVE GROUND PIPE SHALL BE PAINTED SIGNAL R13 RED
- 7. ALL EXTERNAL FIRE HYDRANTS SHALL BE PROTECTED WITH BOLLARDS
- 8. UNDERGROUND ISOLATION VALVES SHALL BE KEY SLUICE VALVES IN ACCORDANCE WITH AS2419.1 & AS2638
- 9. ALL EQUIPMENT SHALL COMPLY WITH THE RELEVANT AUSTRALIAN STANDARD
- 10. FIRE DETECTION AND ALARM CABLING SHALL BE INSTALLED IN ACCORDANCE WITH AS/ACIF S009 & AS1670

PLAN



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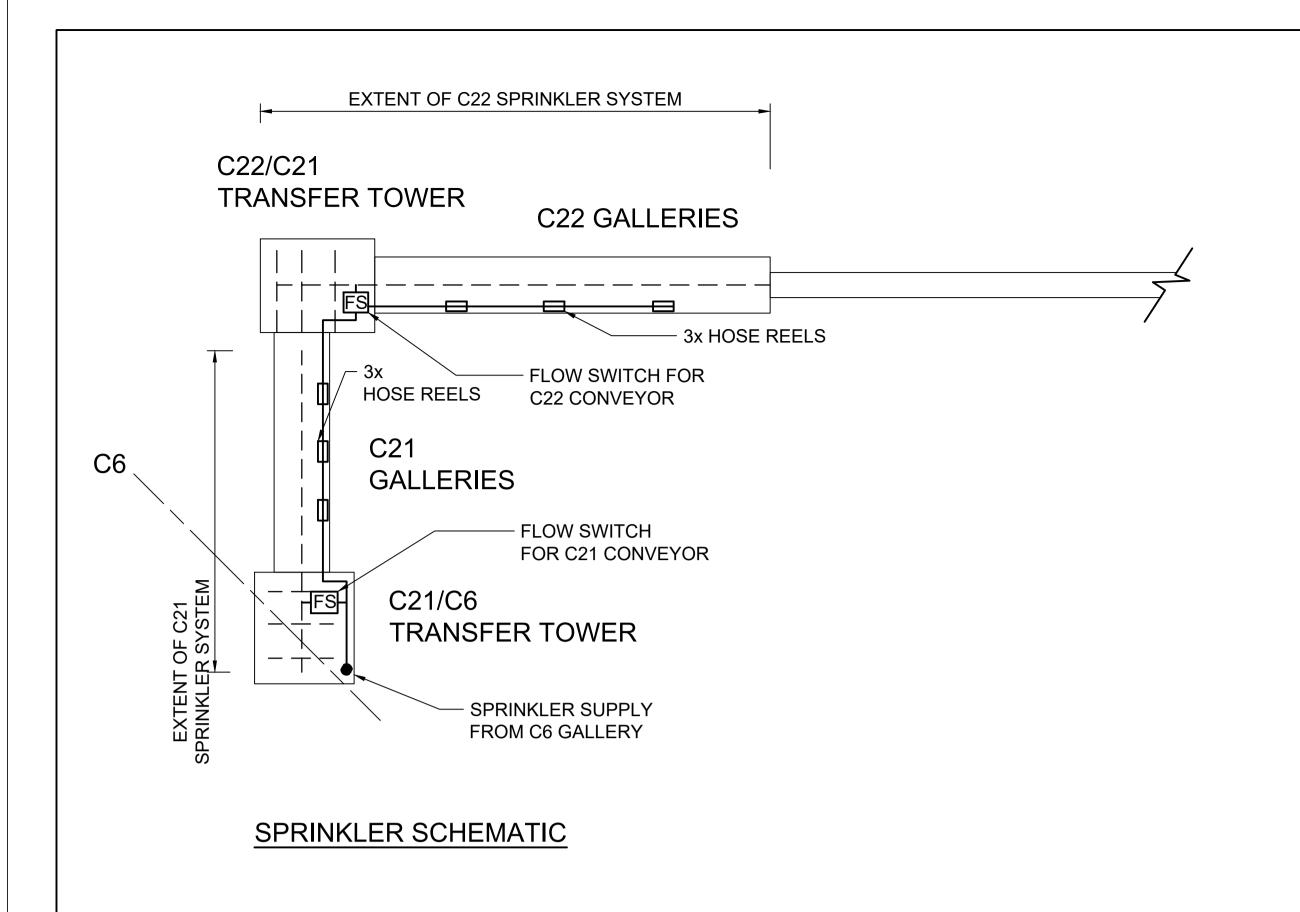
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1	STL CUI SUGAR TERMINAL UPGRADE SERVICES
1	SERVICES
	FIRE SYSTEMS ARRANGEMENT

255200-P-014

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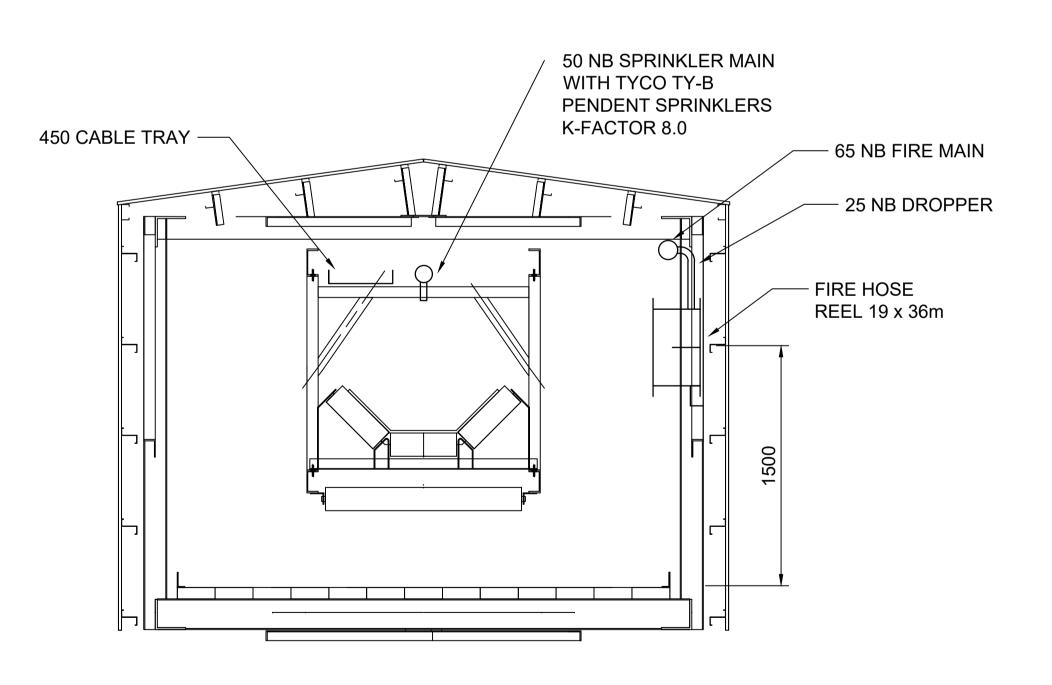
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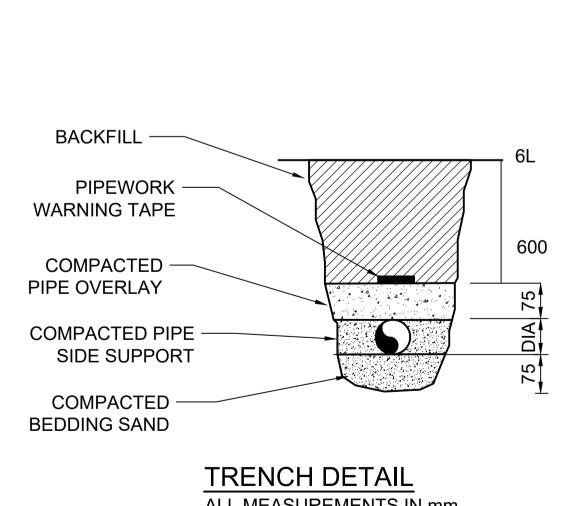
- CHAINWIRE FENCE - LANYARD 300 CABLE TRAY **COVER PIN** — HYDRANT RISER 450 – FUTURE Ø650 DREDGE PIPE APPROX 1250 100 **SLOPE 1:70** 200 TYP. 7000 TYP. CONVEYOR AND ROADWAY 200 TYP. 300 10000 LEASE WIDTH LEASE LEASE 2500 BOUNDARY BOUNDARY C22 GROUND MODULE

SPRINKLER PIPES


MAIN FIRE SUPPLY PIPE



TYPICAL GALLERY SECTION





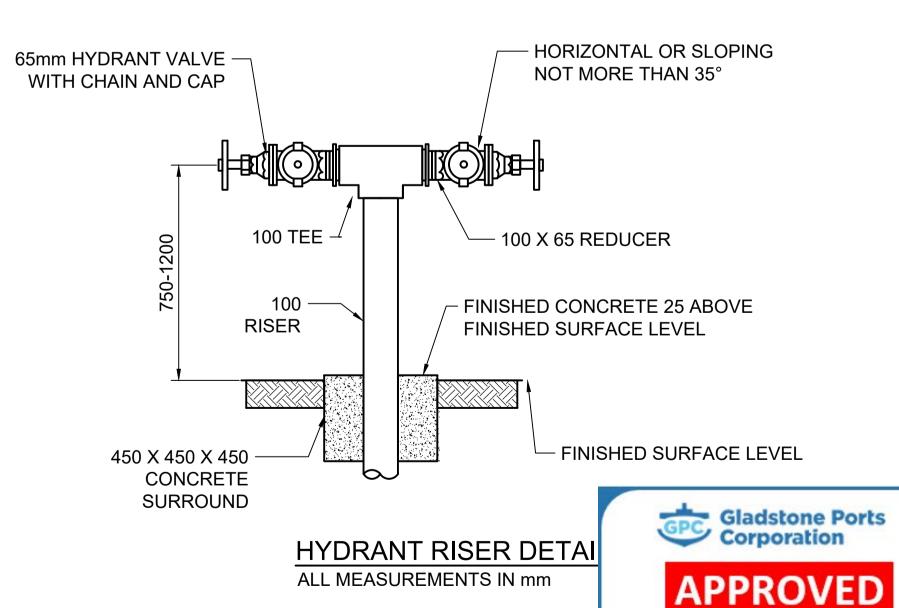

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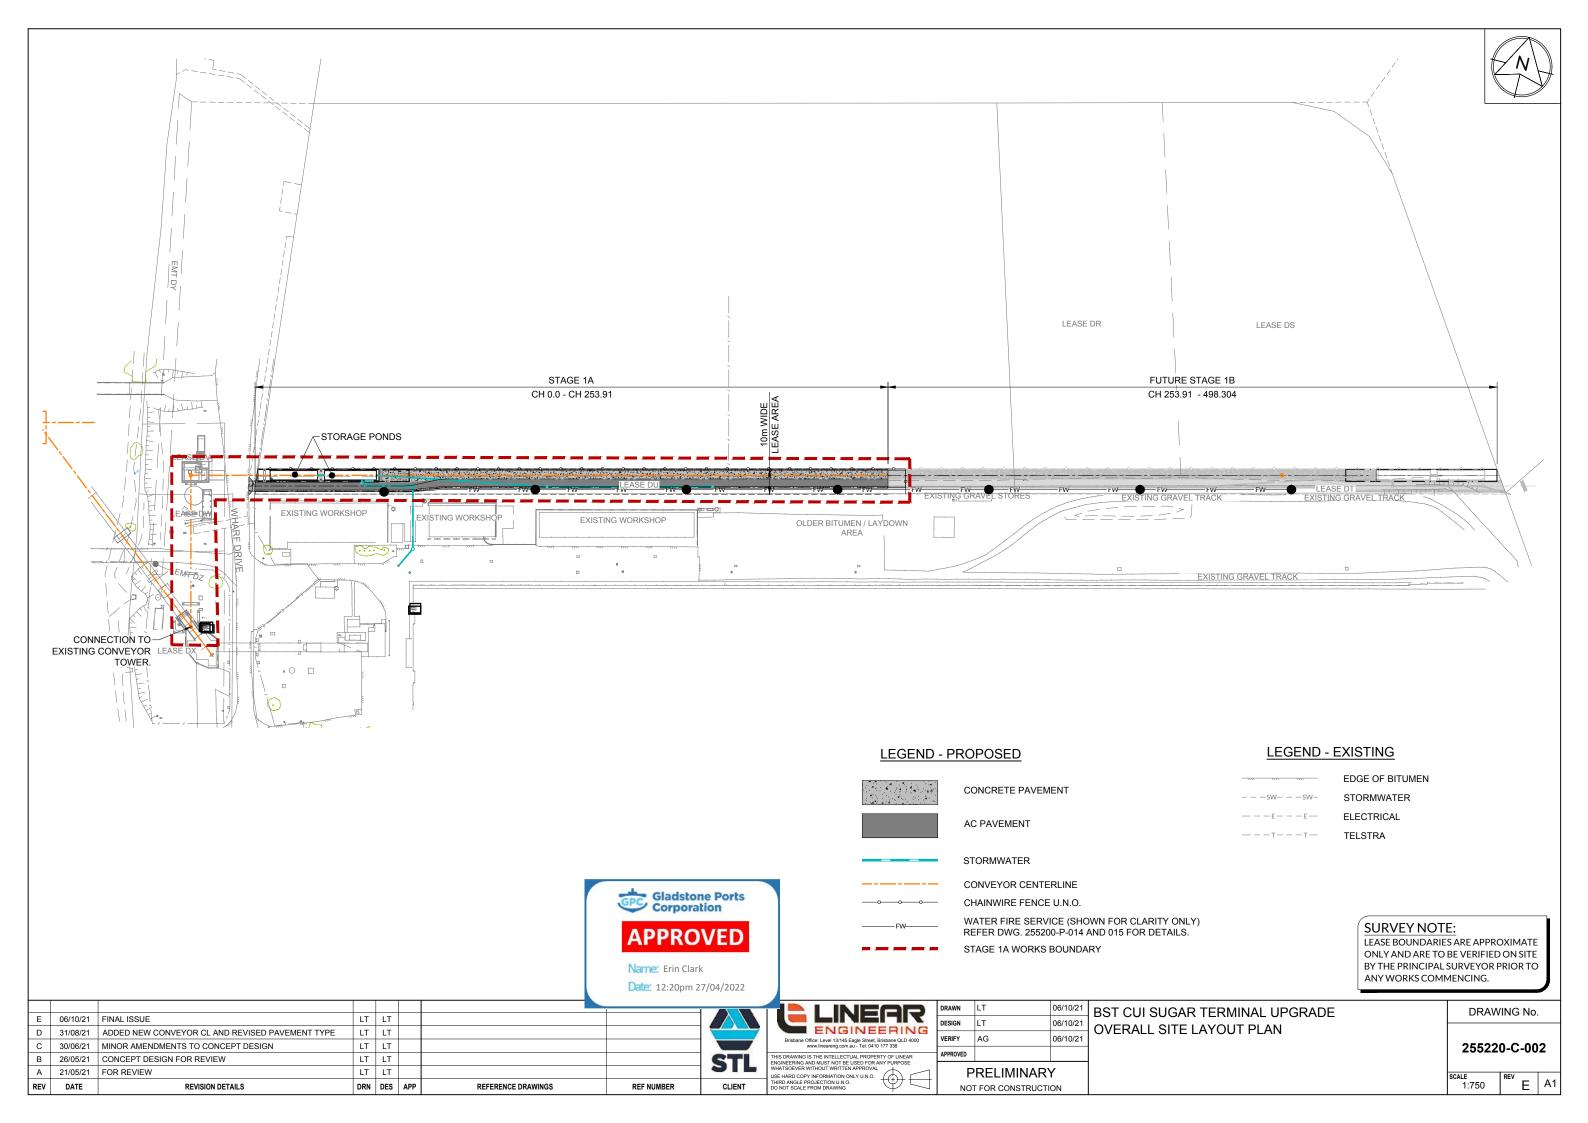
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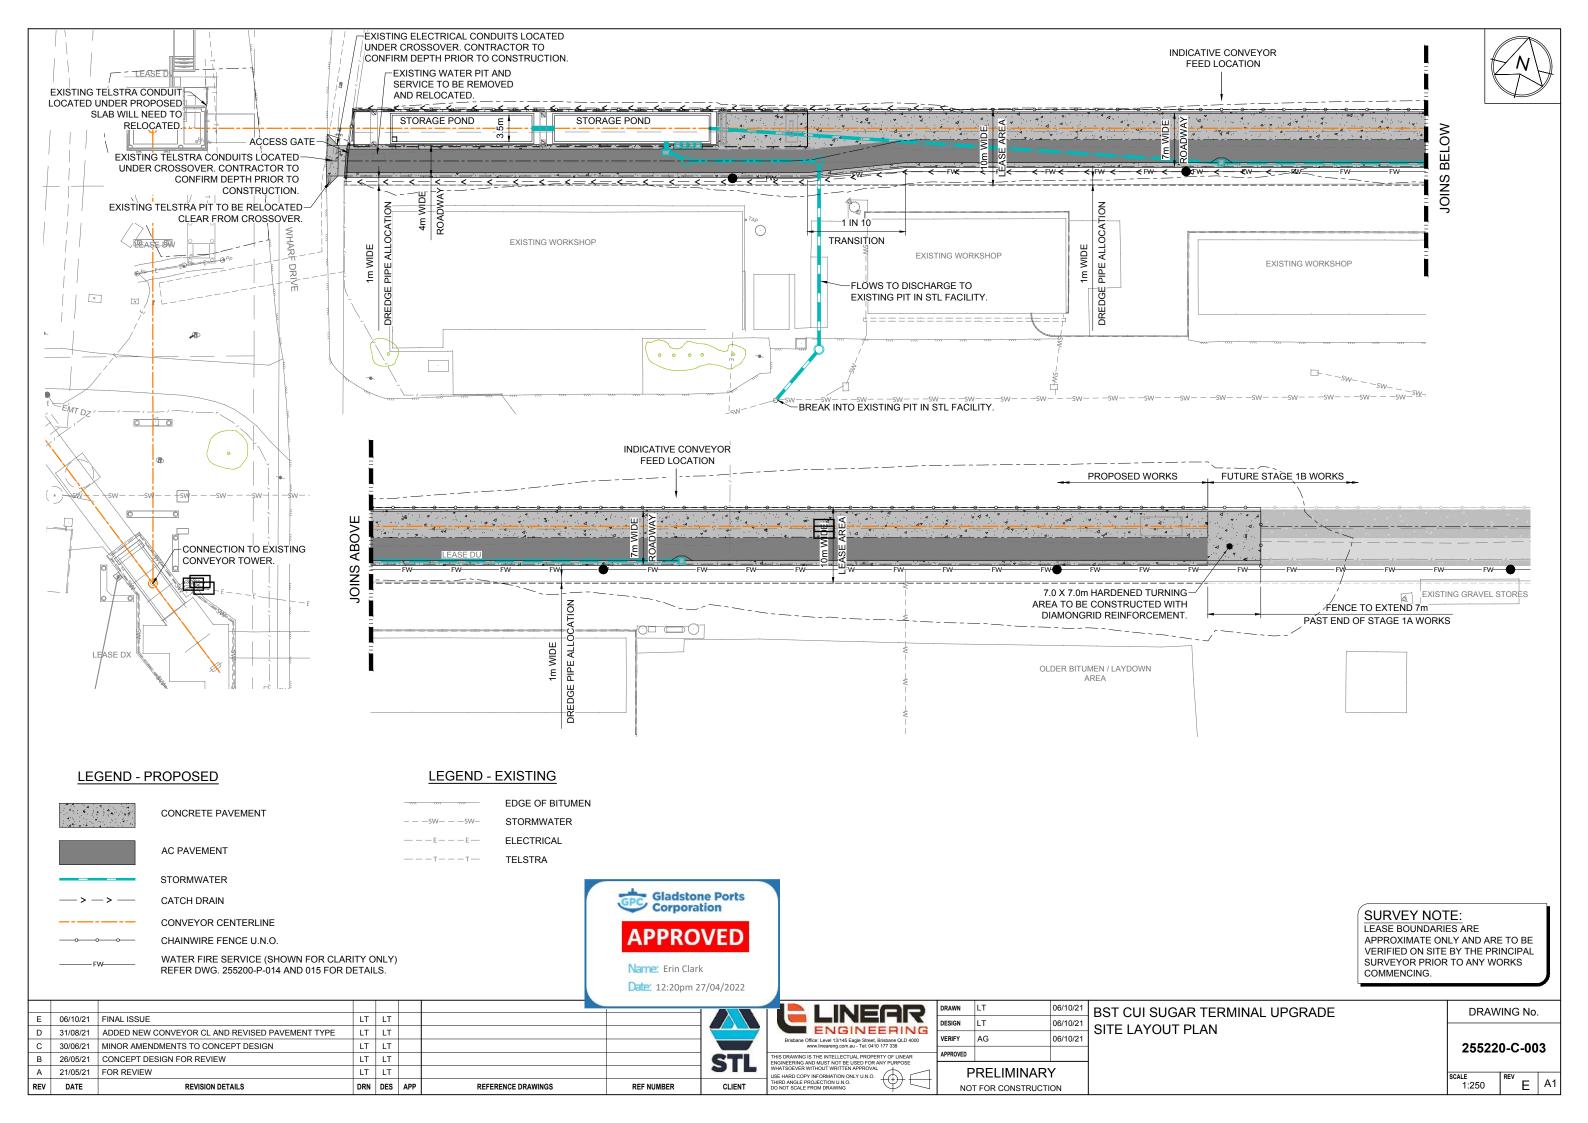
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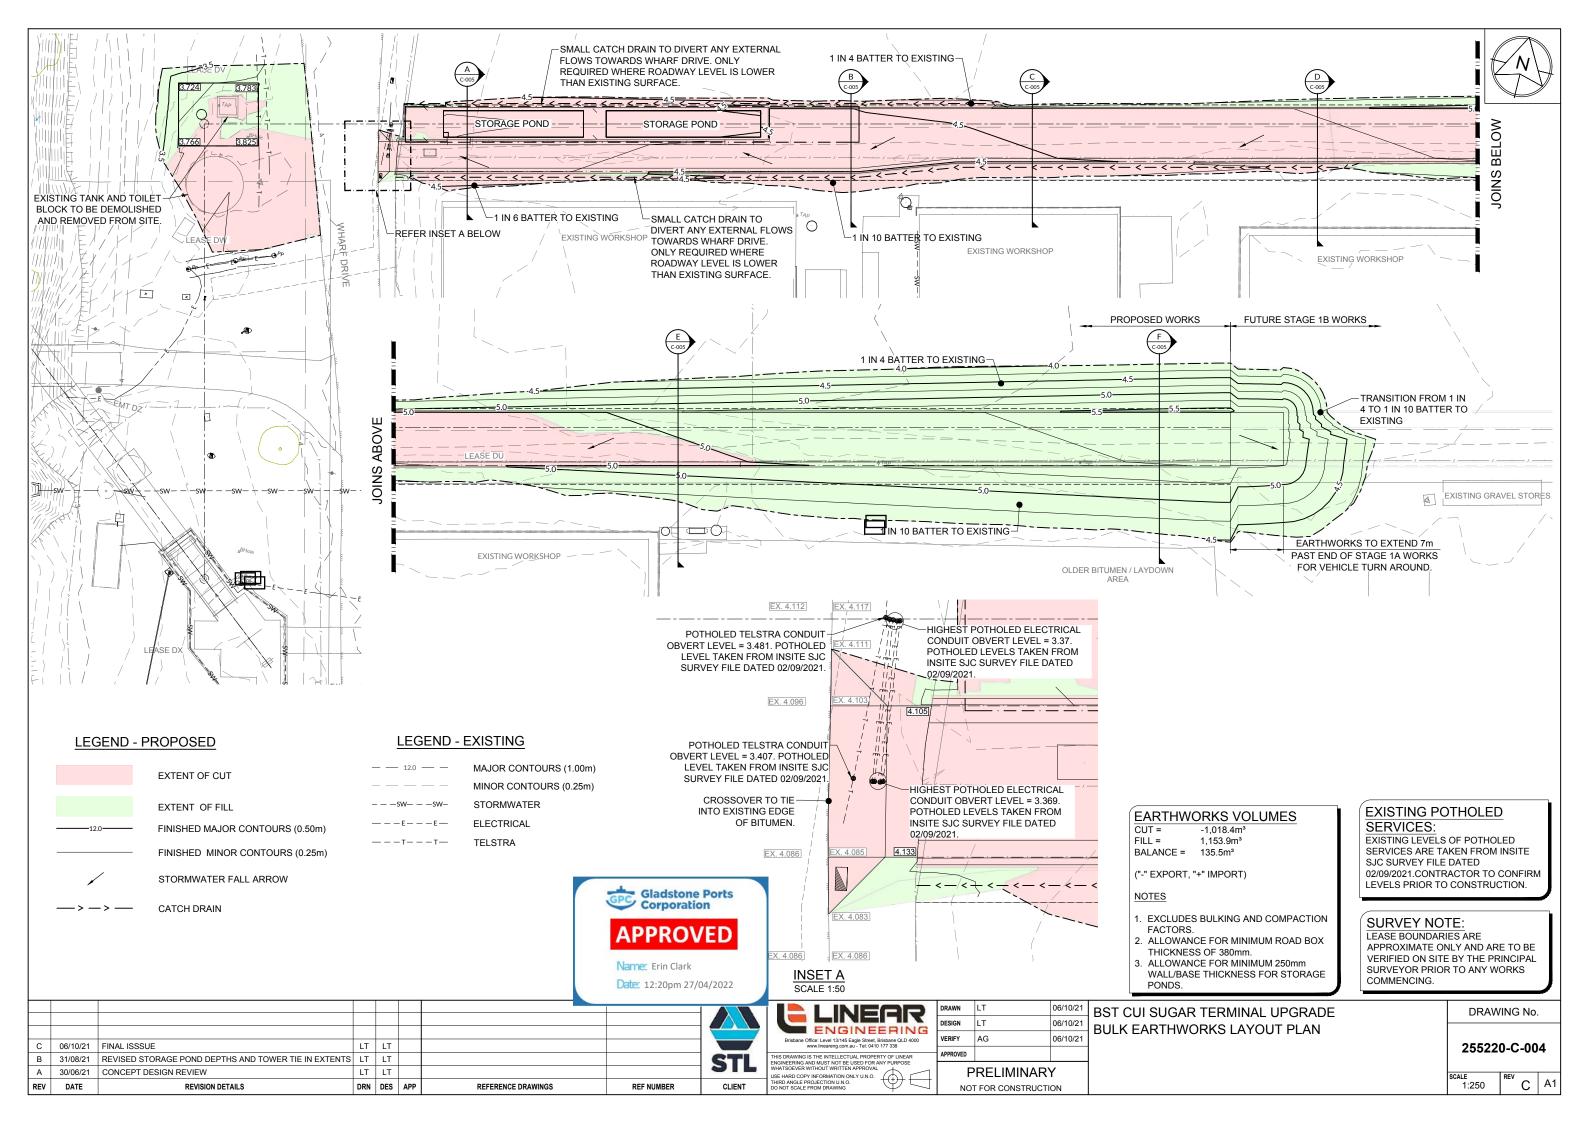
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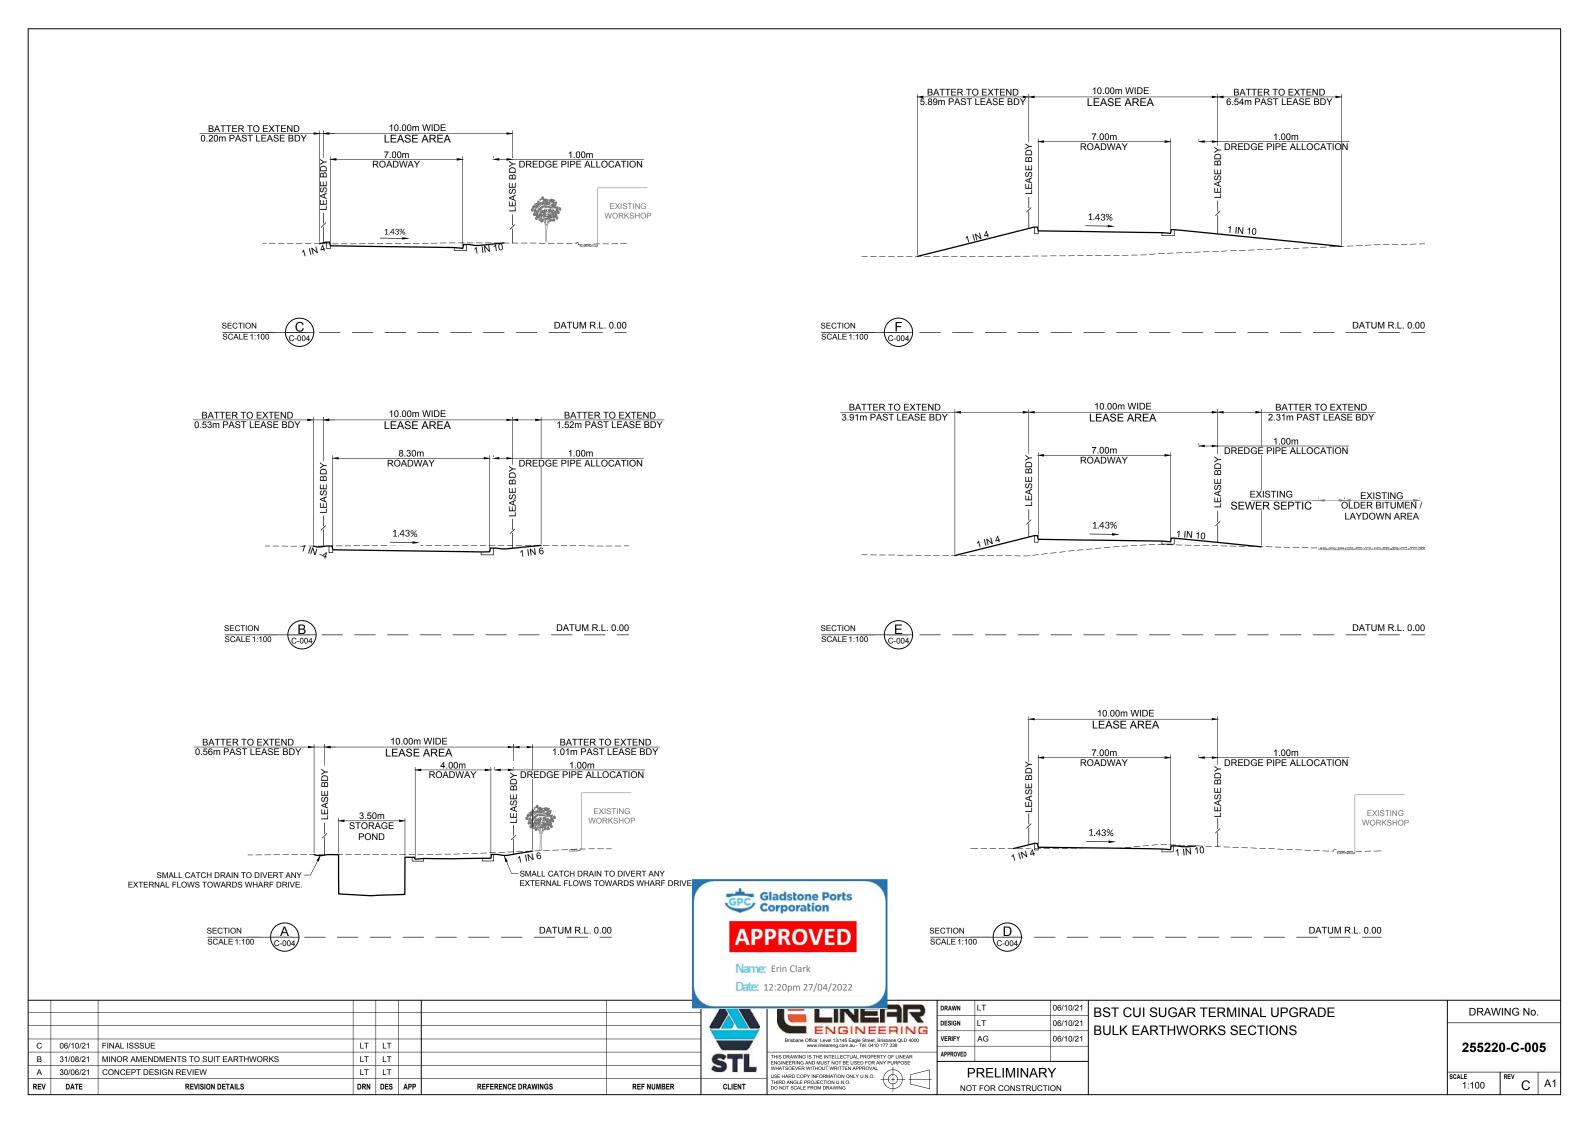
Name: Erin Clark


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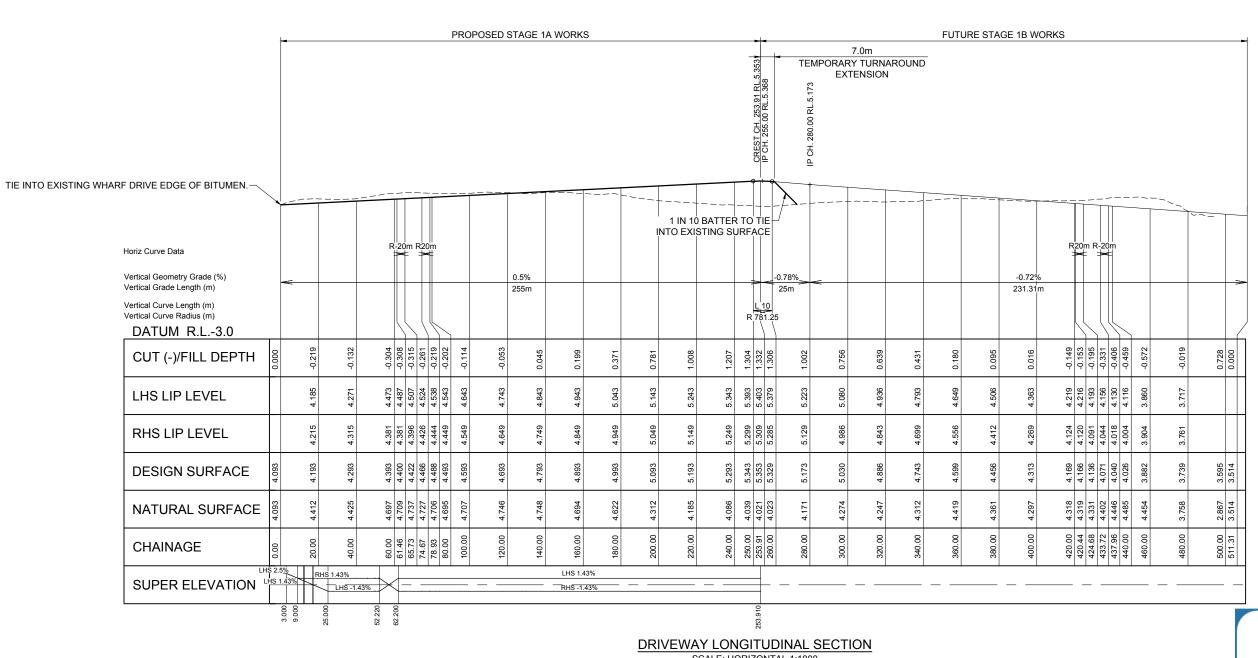










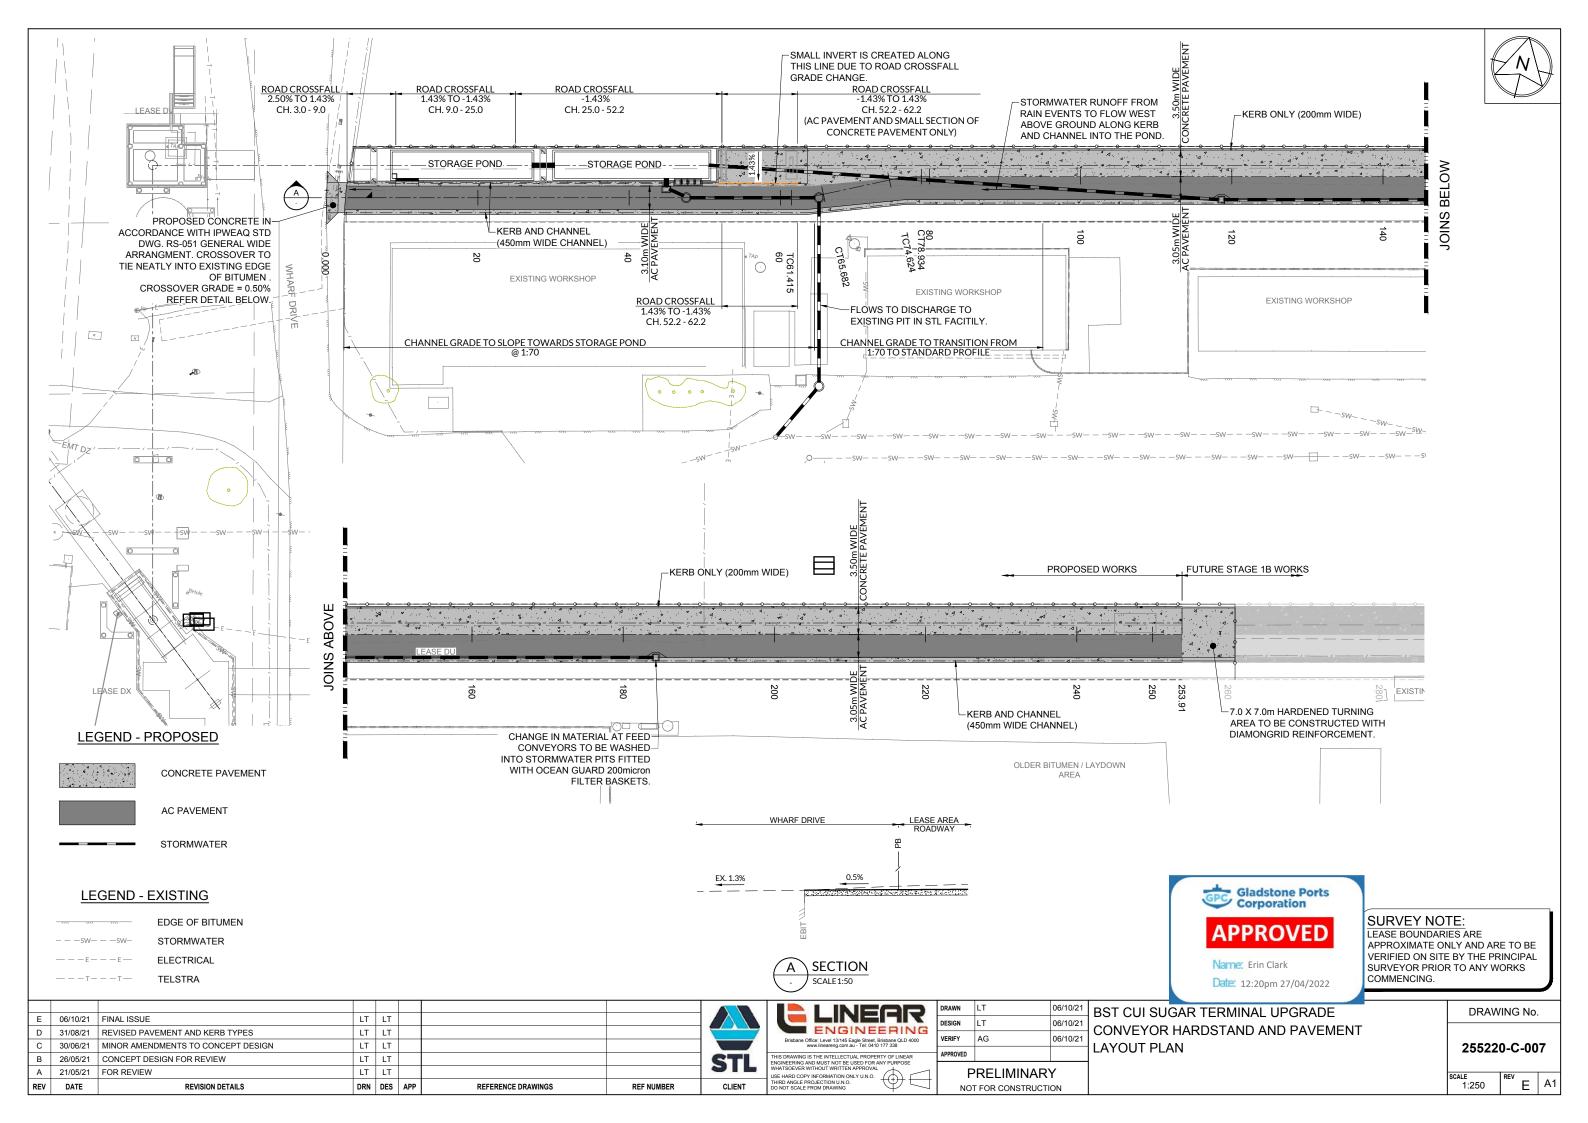

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В	31/08/21	REVISED LIP LEVELS	LT	LT		
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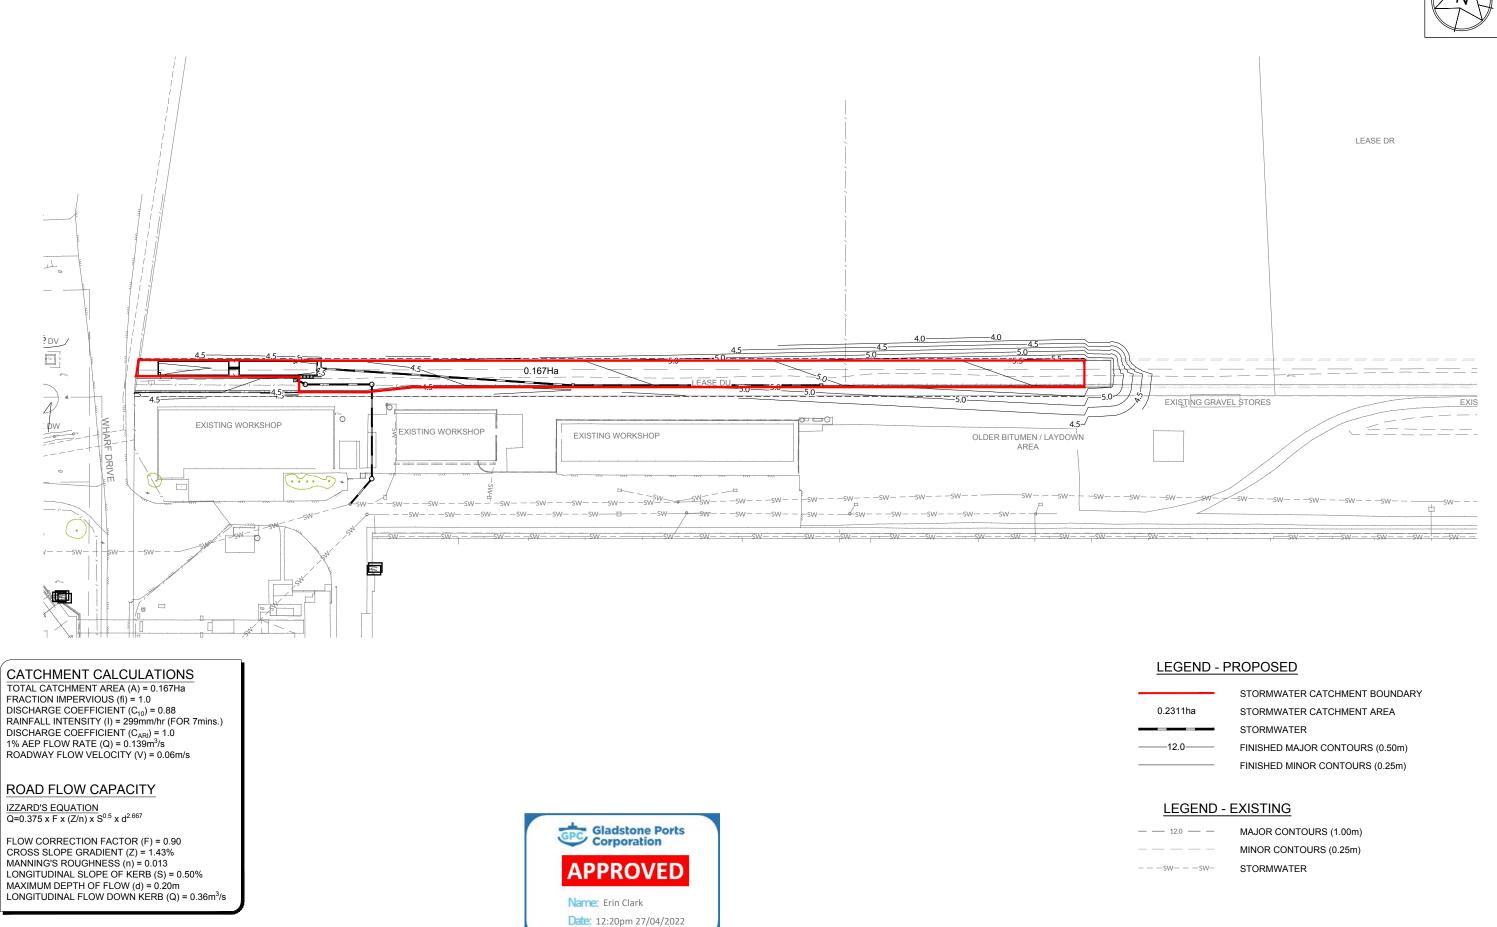
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BST CUI SUGAR TERMINAL UPGRADE CONVEYOR HARDSTAND AND PAVEMENT LONGITUDINAL SECTION

DRAWING No.
255220-C-008

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06/10/21 FINAL ISSUE

DATE

08/08/21 REVISED CATCHMENT FOR DISCUSSION

26/05/21 CONCEPT DESIGN FOR REVIEW

30/06/21 MINOR AMENDMENTS TO CONCEPT DESIGN

REVISION DETAILS

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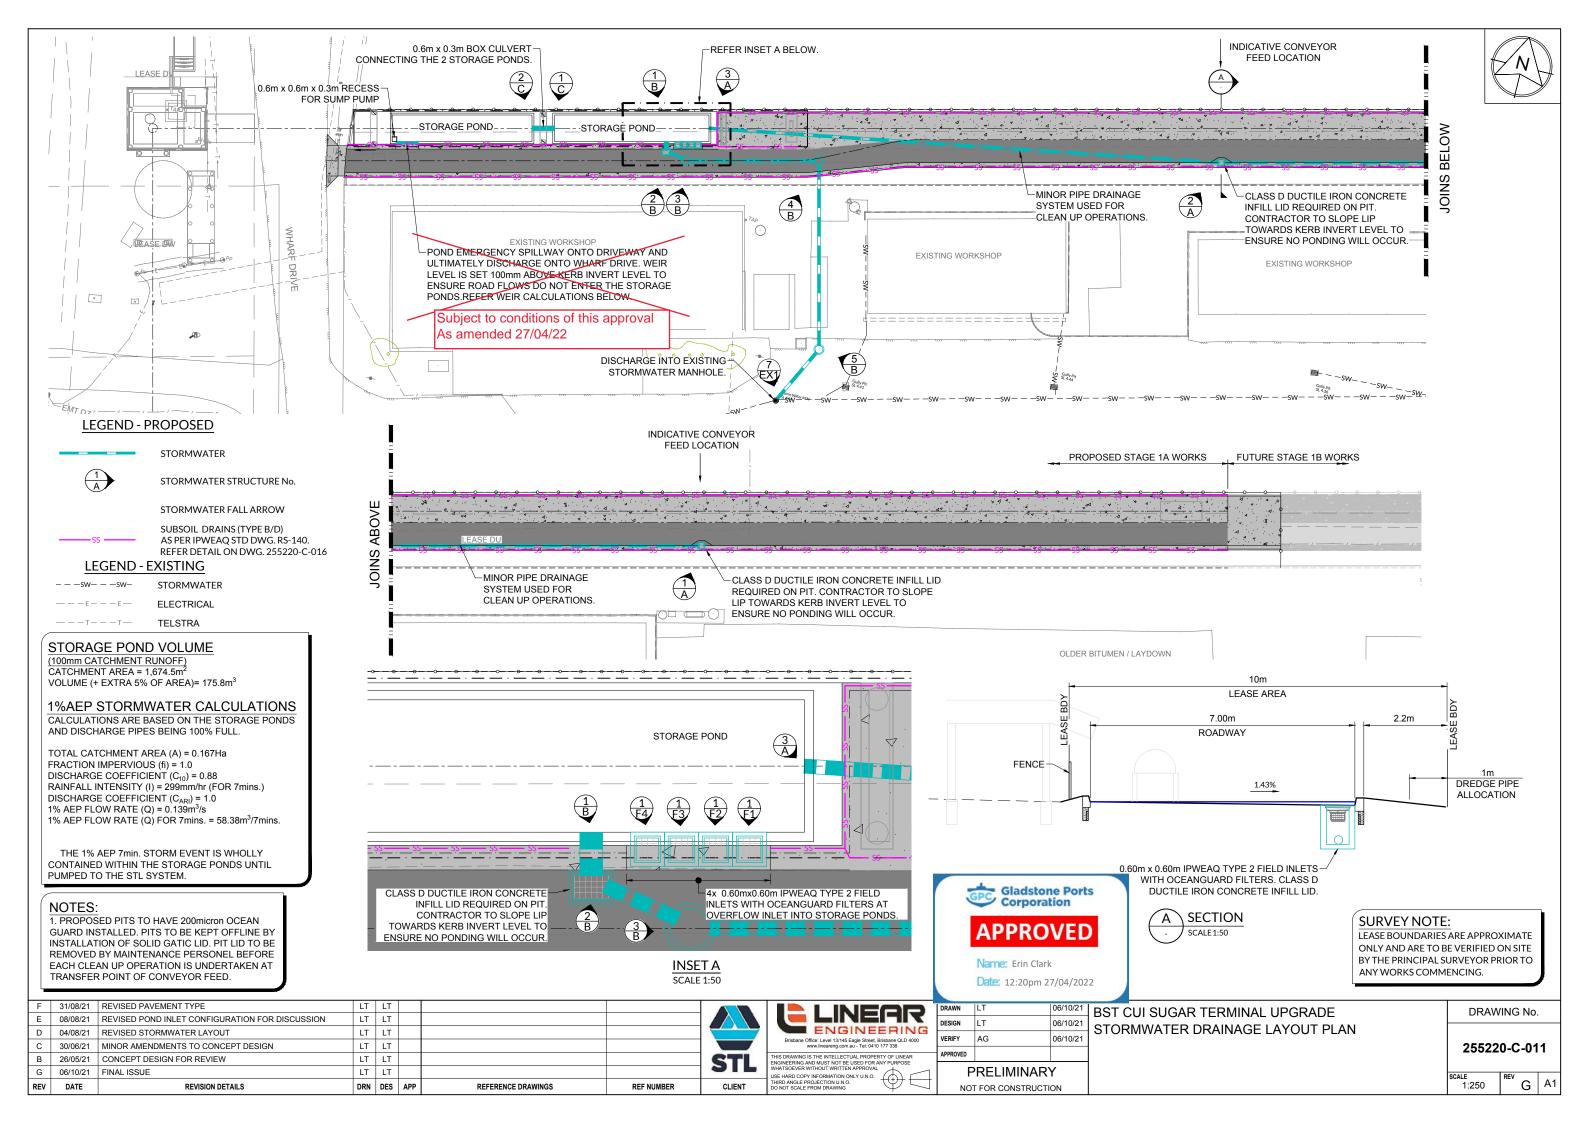
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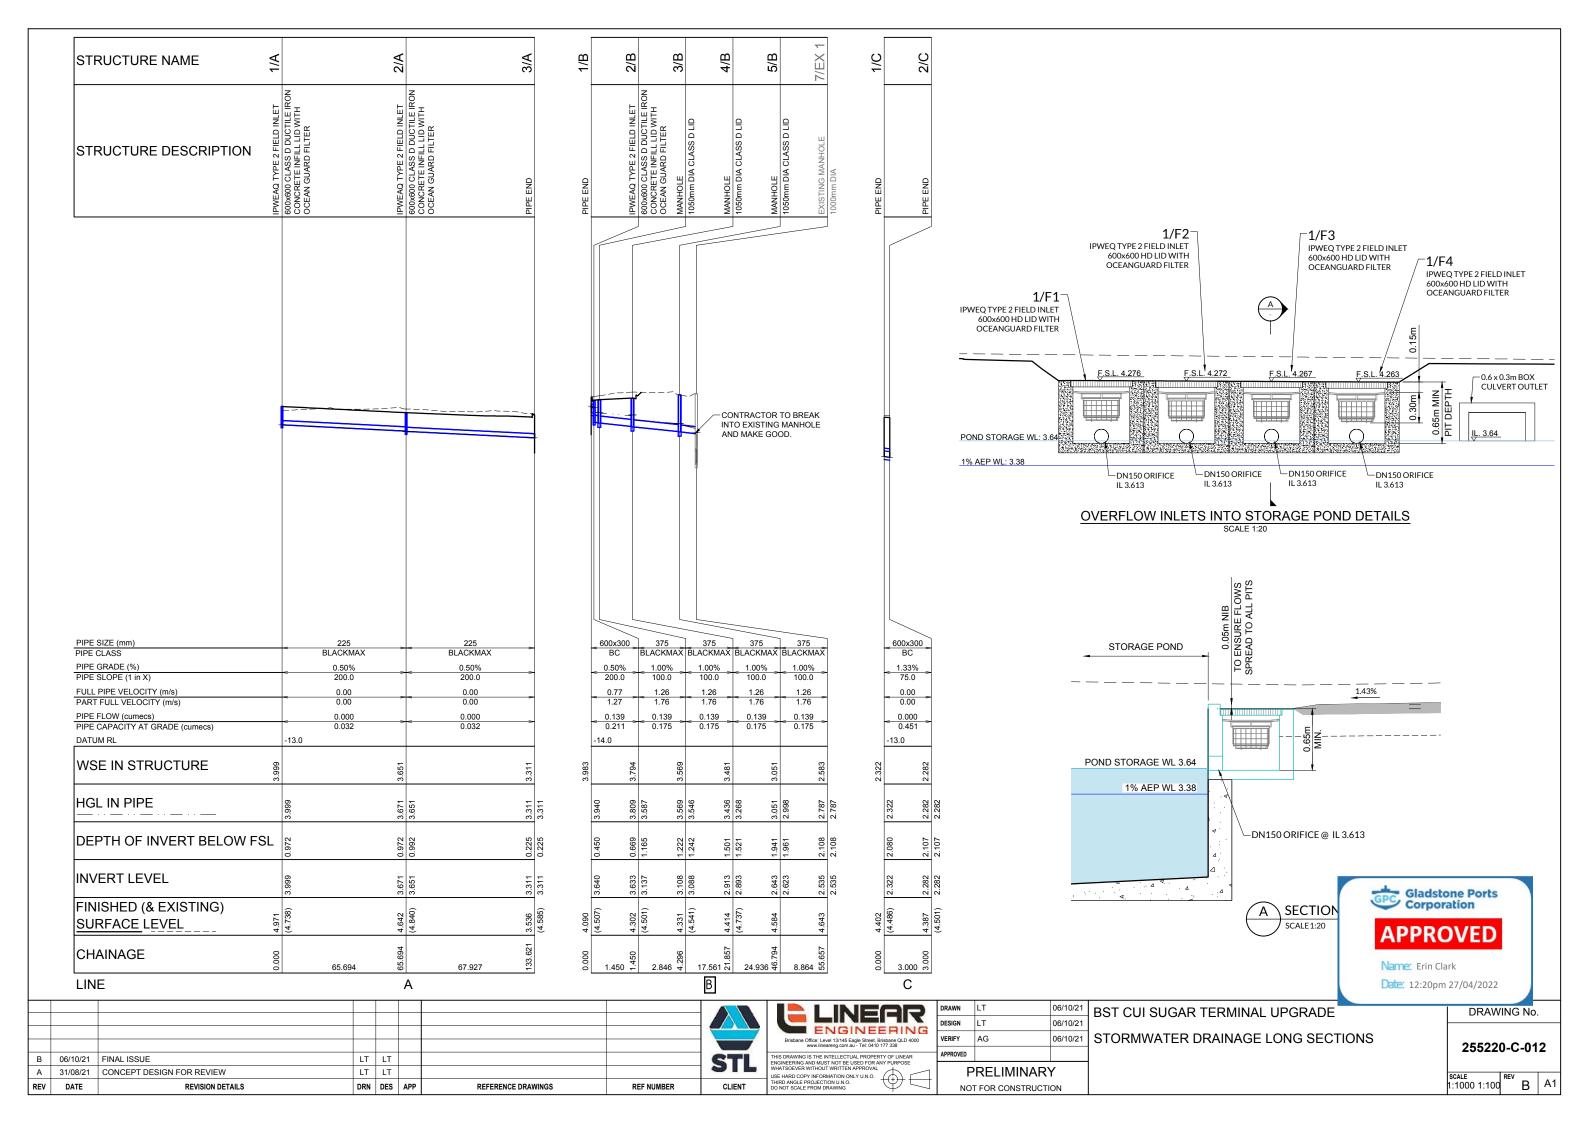
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BST CUI SUGAR TERMINAL UPGRADE

STORMWATER CATCHMENT PLAN





10% AEP STORM EVENT

	LC	OCATION	TIM	1E	SU	JB-CAT RUN	TCHMI NOFF	ENT			INI	ET DE	SIGN					I	DRAIN	DESIG	N							ŀ	HEADLO	OSSES					P.	ART FU	ILL		DES	SIGN LEV	/ELS		
			tc	I	С	Α	CA	Q					Qg	Qb	to	I	CA	(Др	L	S			Vf=Q/A			STRUC RATI		V2/2g	Ku	hu	Kw	hw Sf	hf	dn	Vn	Vn						
STRUCTURE NUMBER	DOWNSTREAM STRUCTURE	SUB-CATCHMENTS CONTRIBUTING	SUB-CATCHMENT TIME OF CONCENTRATION	RAINFALL INTENSITY	CO-EFFICIENT OF RUNOFF	SUB-CATCHMENT AREA	EQUIVALENT AREA	SUB-CATCHMENT	DISCHARGE FLOW IN K&C (INC. BYPASS)	FLOW WIDTH	FLOW DEPTH	ROAD GRADE AT INLET	HALF KOAD CAPACITY FLOW INTO INLET	BYPASS FLOW	BYPASS STRUCTURE NUMBER CRITICAL TIME OF	RAINFALL INTENSITY	TOTAL (C×A)	- Ш	E FLOW	REACH LENGTH	PIPE GRADE	PIPE/BOX DIMENSIONS	CLASS	FULL PIPE VELOCITY	TIME OF FLOW IN REACH	CHARTS USED	Qg/Qo Du/Do	S/Do	VELOCITY HEAD	UPSTREAM HEADLOSS CO-EFFICIENT	UPSTREAM HEADLOSS	W.S.E. CO-EFFICIENT	CHANGE IN W.S.E.	II NOIL	NORMAL DEPTH	NORMAL DEPTH VELOCITY (MINOR STORM)	NORMAL DEPTH VELOCITY (1 YEAR STORM) UPSTREAM OBVERT LEVEL	DOWNSTREAM OBVERT LEVEL	UPSTREAM H.G.L.	DOWNSTREAM H.G.L.	W.S.E.	SURFACE OR GRATE LEVEL	STRUCTURE NUMBER
			min	mm/h		ha	ha	l/s	I/s	m	m	% I	/s I/s	l/s	mi	mm/h	ha	l/s l	/s	m	%	mm		m/s	min				m		m		m %	m	m	m/s	m/s m	m	m	m	m	m	
1/A	2/A		0.00	0		0.000	0.000	0	0		0.	50	0	0	2/A 1.00	311	0.000	0	65	.694 0.	.500 2	225	ВМ	0.00	1.37	32			0.000	0.00	0.000		0.000 0.50	0.328	0.000	0.00	0 4.224	3.896	3.999	3.671	3.999	4.971	1/A
2/A	3/A		0.00	0		0.000	0.000	0	0		0.	50	0	0	1/F1 2.37	262	0.000	0	67	.927 0.	.500 2	225	вм	0.00	1.41	32 33 34			0.000	0.00	0.000		0.000 0.50	0.340	0.000	0.00	0 3.876	3.536	3.651	3.311	3.651	4.642	2/A
3/A																																									3.311	3.536	3/A
1/B	2/B		0.00	0		0.000	0.000	0	0		0.	50	0	0	1.00	311	0.000 1	39 13	39 1.4	150 0.	.500	600x300	вс	0.77	0.02	Outlet Control		1.14	0.030	1.40	0.043		0.043 9.03	0.073	0.182	1.27	1.28 3.940	3.933	3.940	3.809	3.983	4.090	1/B
2/B	3/B		0.00	0		0.000	0.000	0	0		0.	50	0	0	LOST 1.02	310	0.000 1	39 13	39 2.8	346 1.	.000	375	ВМ	1.26	0.03	46 47	0.00 1.00	1.75	0.081	2.06	0.167	2.56	0.207 0.63	0.018	0.252	1.76	1.77 3.512	3.483	3.587	3.569	3.794	4.302	2/B
3/B	4/B														1.05	309	0.000 1	39 13	39 17	.561 1.	.000	375	ВМ	1.26	0.18	34	0.00 1.00	1.28	0.081	0.27	0.022	(0.022 0.63	0.110	0.252	1.76	1.77 3.463	3.288	3.546	3.436	3.569	4.331	3/B
4/B	5/B		·												1.23	301	0.000 1	39 13	39 24	.936 1.	.000	375	вм	1.26	0.26	46 47	0.00 1.00	1.57	0.081	2.08	0.168	2.63	0.213 0.87	0.217	0.252	1.76	1.77 3.268	3.018	3.268	3.051	3.481	4.414	4/B
5/B	7/EX 1														1.50	290	0.000 1	39 13	8.8	364 1.	.000	375	ВМ	1.26	0.09	34 37	0.00 1.00	1.14	0.081	0.65	0.053	(0.053 2.39	0.134	0.252	1.76	1.77 2.998	2.910	2.998	2.787	3.051	4.584	5/B
7/EX 1																																									2.583	4.643	7/EX 1
1/C	2/C		0.00	0		0.000	0.000	0	0				0	0	1.00	311	0.000	0	3.0	000 1.	.333	500x300	ВС	0.00	0.02				0.000	2.00	0.000		0.000 1.33	0.040	0.000	0.00	0 2.622	2.582	2.322	2.282	2.322	2.622	1/C
2/C																																									2.282	2.582	2/C

1% AEP STORM EVENT

L	OCATION		TIME			CATCH		Т	ı	NLET	DESIGN						DRA	IN DESI	GN							HEA	ADLOS	SSES					PART F	ULL			DESIG	N LEVELS			DESI	GN LEVELS
		tc	ı	C	, (CA	Q		Qg	Ql	b	tc	- 1	CA		Qp	L	S			Vf=Q/	A		:	STRUCTURE RATIOS	V2/2	g Ku	ı hu	Kw	hw	Sf	hf	dn	Vn								
STRUCTURE NUMBER DOWNSTREAM STRUCTURE	SUB-CATCHMENTS CONTRIBUTING	SUB-CATCHMENT TIME OF CONCENTRATION	RAINFALL INTENSITY	CO-EFFICIENT OF RUNOFF		EQUIVALENT AREA		FLOW IN R&C (INC. BYPASS)	ROAD GRADE AT INLET	BYPASS FLOW	BYPASS STRUCTURE NUMBER	CRITICAL TIME OF CONCENTRATION	RAINFALL INTENSITY	TOTAL (C×A)	SUM ADDITIONAL PIPE FLOW	PIPE FLOW	REACH LENGTH	PIPE GRADE	PIPE/BOX DIMENSIONS	CLASS	FULL PIPE VELOCITY	TIME OF FLOW IN REACH	CHARTS USED	Qg/Qo	od/nd	S/Do VELOCITY HEAD	UPSTREAM HEADLOSS	CO-EFFICIENT UPSTREAM HEADLOSS	W.S.E. CO-EFFICIENT	CHANGE IN W.S.E.	PIPE FRICTION SLOPE	PIPE FRICTION HEADLOSS (L × Sf)	NORMAL DEPTH	NORMAL DEPTH VELOCITY	UPSTREAM OBVERT LEVEL	DOWNSTREAM OBVERT LEVEL	UPSTREAM H.G.L.	DOWNSTREAM H.G.L.	W.S.E.	SURFACE OR GRATE LEVEL	MAJOR SURFACE FLOW CAPACITY	MAJOR SURFACE FLOW DEPTH × VELOCITY PRODUCT
		min	mm/h	h	a	ha	l/s	l/s	% I/s	I/s	s	min	mm/h		l/s	I/s	m	%	mı	m	m/s	min				m		m		m	%	m	m	m/s	m	m	m	m	m	m	l/s	I/s m ² /s
1/A 2/A		0.00	0	0.00	0.0	000 0	0	0	.50 0	0	2/A	1.00	444	0.000	0	0	65.694	0.500	225	ВМ	0.00	1.37	32			0.000	0.00	0.000		0.000	0.50	0.328	0.000	0.00 4	4.224	3.896	3.999	3.671	3.999	4.971		0
2/A 3/A		0.00	0	0.00	0.0	000 0	0	0	.50 0	0	1/F1	2.37	381	0.000	0	0	67.927	0.500	225	ВМ	0.00	1.41	32 33 34			0.000	0.00	0.000		0.000	0.50	0.340	0.000	0.00	3.876	3.536	3.651	3.311	3.651	4.642		0
3/A																																							3.311	3.536		
1/B 2/B		0.00	0	0.00	0.0	000 0	0	0	.50 0	0		1.00	444	0.000	139	139	1.450	0.500	600x	300 BC	0.77	0.02	Outlet Control		1.1	0.030	1.40	0.043		0.043	9.03	0.073	0.182	1.27 3	3.940	3.933	3.940	3.809	3.983	4.090		0
2/B 3/B		0.00	0	0.00	0.0	000 0	0	0	.50 0	0	LOST	1.02	443	0.000	139	139	2.846	1.000	375	ВМ	1.26	0.03	46 47	0.00	1.00 1.7	75 0.081	2.06	0.167	2.56	0.207	0.63	0.018	0.252	1.76	3.512	3.483	3.587	3.569	3.794	4.302		0
3/B 4/B												1.05	441	0.000	139	139	17.561	1.000	375	вм	1.26	0.18	34	0.00	1.00 1.2	28 0.081	0.27	7 0.022		0.022	0.63	0.110	0.252	1.76 3	3.463	3.288	3.546	3.436	3.569	4.331		
4/B 5/B												1.23	431	0.000	139	139	24.936	1.000	375	вм	1.26	0.26	46 47	0.00	1.00 1.5	0.081	2.08	0.168	2.63	0.213	0.87	0.217	0.252	1.76 3	3.268	3.018	3.268	3.051	3.481	4.414		
5/B 7/EX 1												1.50	417	0.000	139	139	8.864	1.000	375	вм	1.26	0.09	34 37	0.00	1.00 1.1	14 0.081	0.65	0.053		0.053	2.39	0.134	0.252	1.76 2	2.998	2.910	2.998	2.787	3.051	4.584		
7/EX 1																																							2.583	4.643		
1/C 2/C		0.00	0	0.00	0.0	000 0	0)	0	0		1.00	444	0.000	0	0	3.000	1.333	600x	300 BC	0.00	0.02				0.000	2.00	0.000		0.000	1.33	0.040	0.000	0.00 2	2.622	2.582	2.322	2.282	2.322	2.622		0
2/C																																							2.282	2.582		



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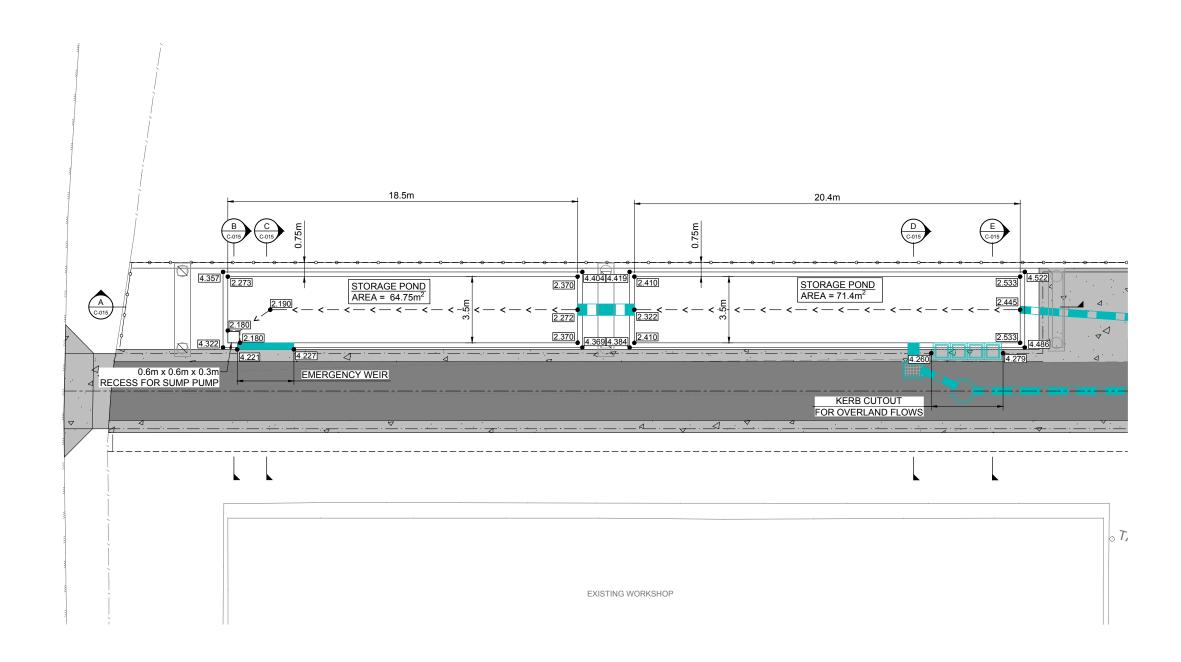
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0/21	BST CULSUGAR TERMINAL UPGRADE
0/21	BST CUI SUGAR TERMINAL UPGRADE STORMWATER DRAINAGE CALCULATION TABLES
0/21	STORIVINATER DRAINAGE CALCULATION TABLES

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LEGEND - PROPOSED

_____STORMWATER

— < — < — STORAGE POND LOW FLOW


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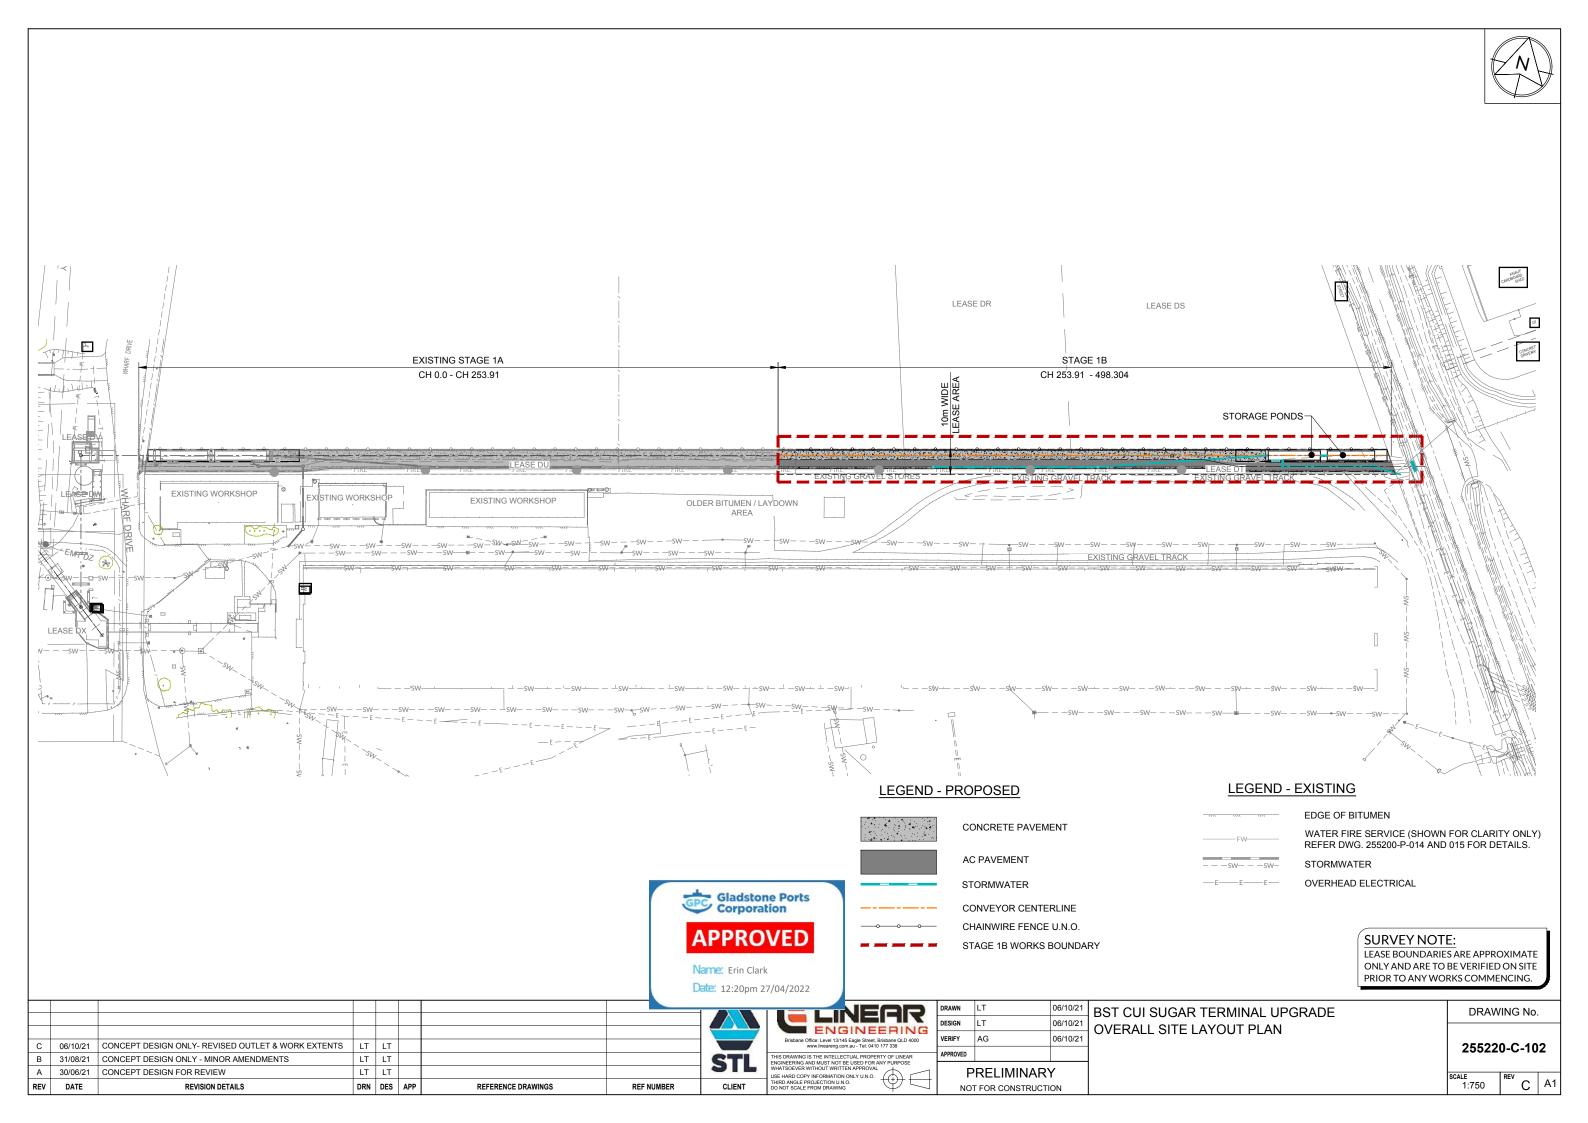
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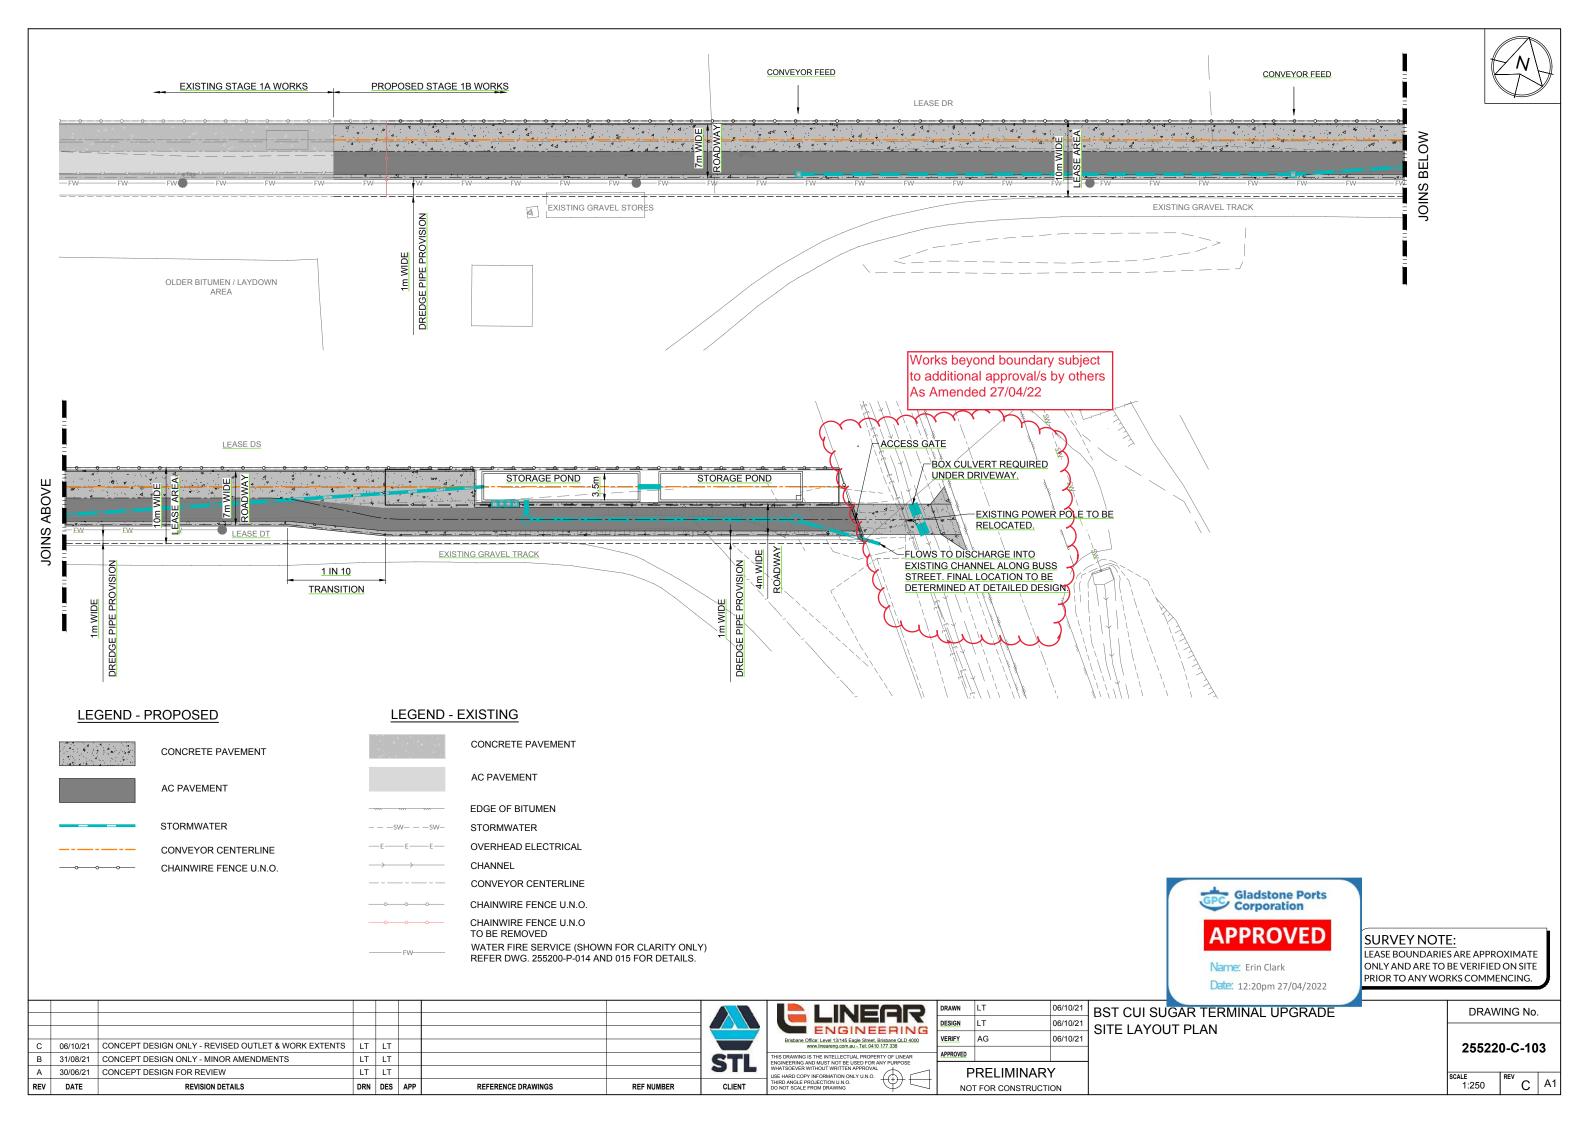
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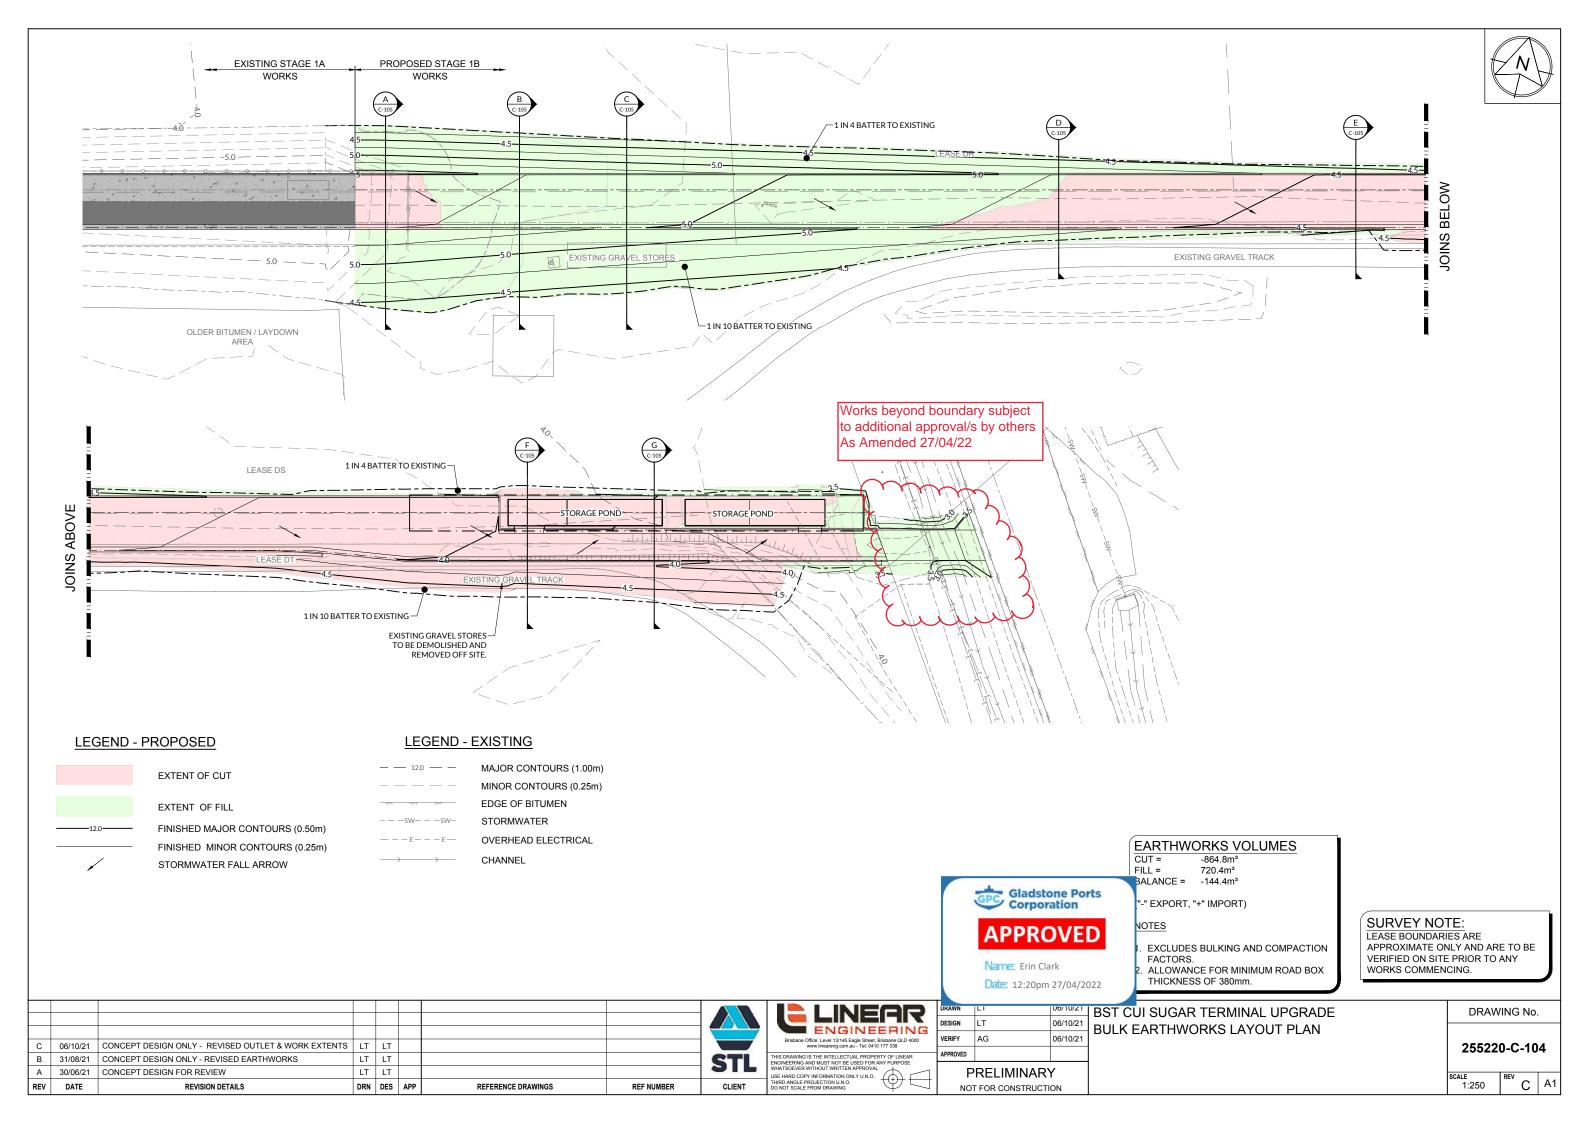



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									DRAWN	LT	06/10/21	BST CUI SUGAR TERMINAL UPGRADE	DRAWING No.
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D	06/10/21	FINAL ISSUE	Lī	LT				ENGINEERING				STORMWATER POND LAYOUT PLAN	
С	31/08/21	REVISED STORMWATER AND PAVEMENT TYPE	L7	LT				Brisbane Office: Level 13/145 Eagle Street, Brisbane QLD 4000 www.lineareng.com.au - Tel: 0410 177 338	VERIFY	AG	06/10/21		255220-C-014
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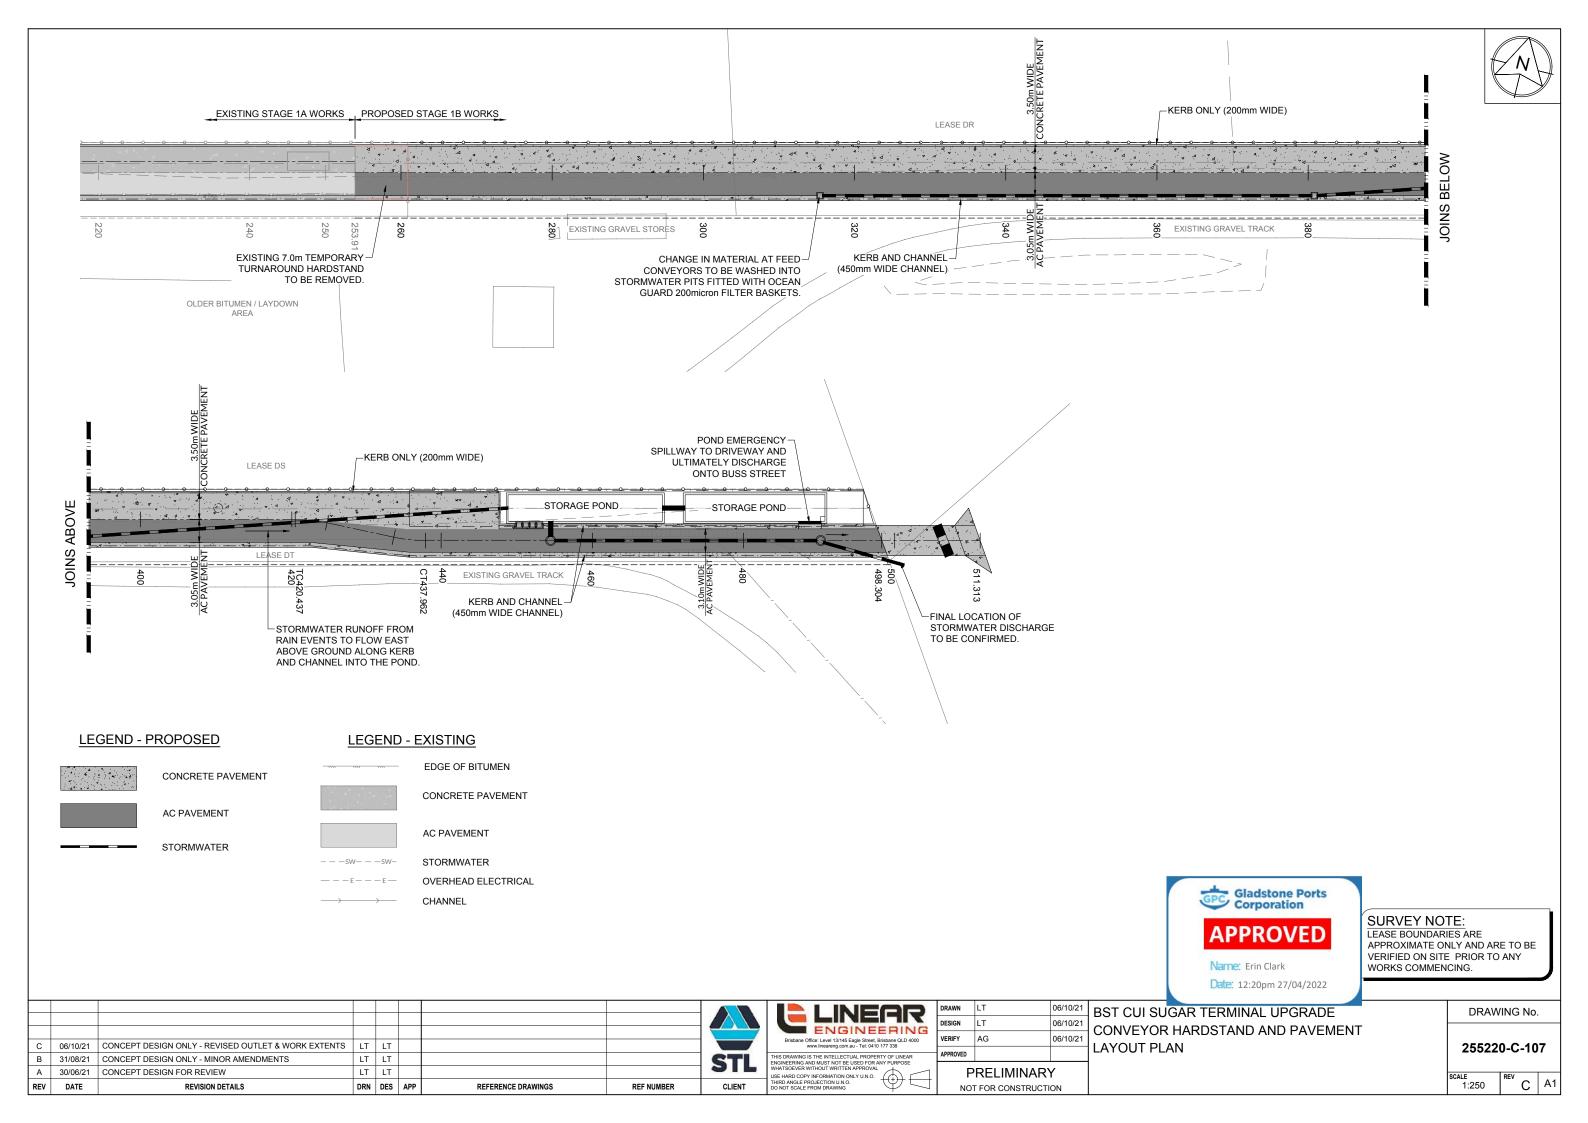









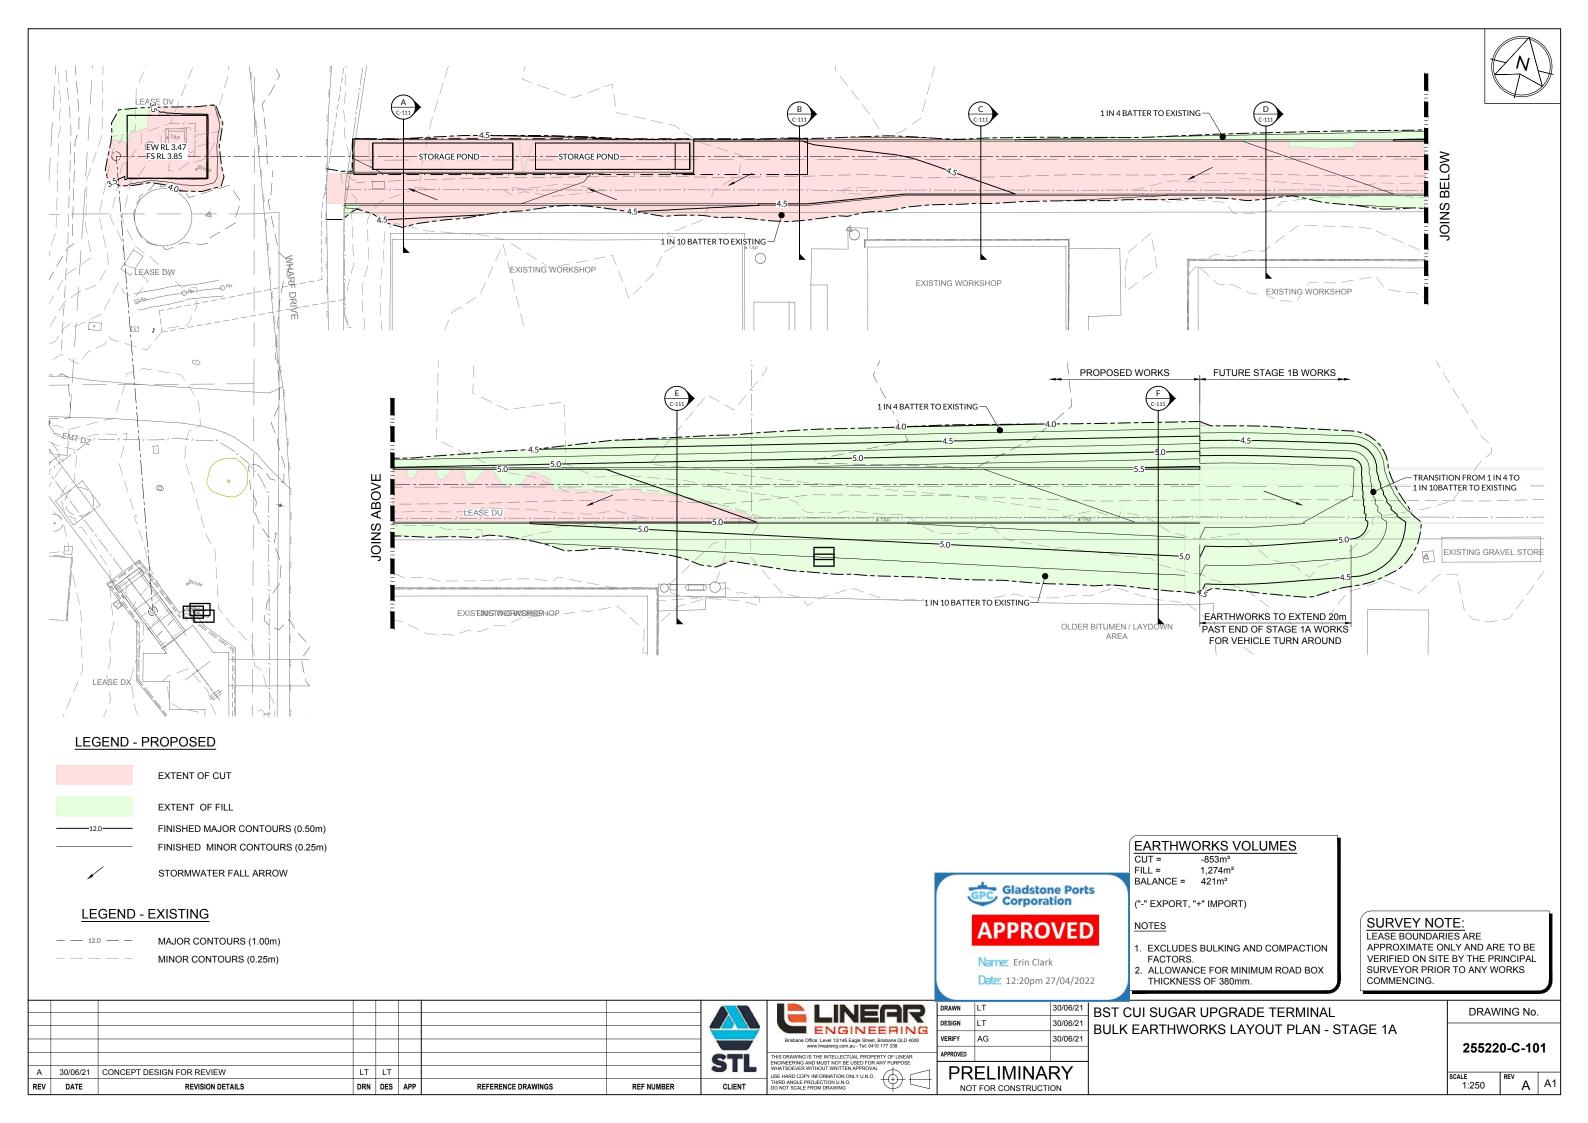

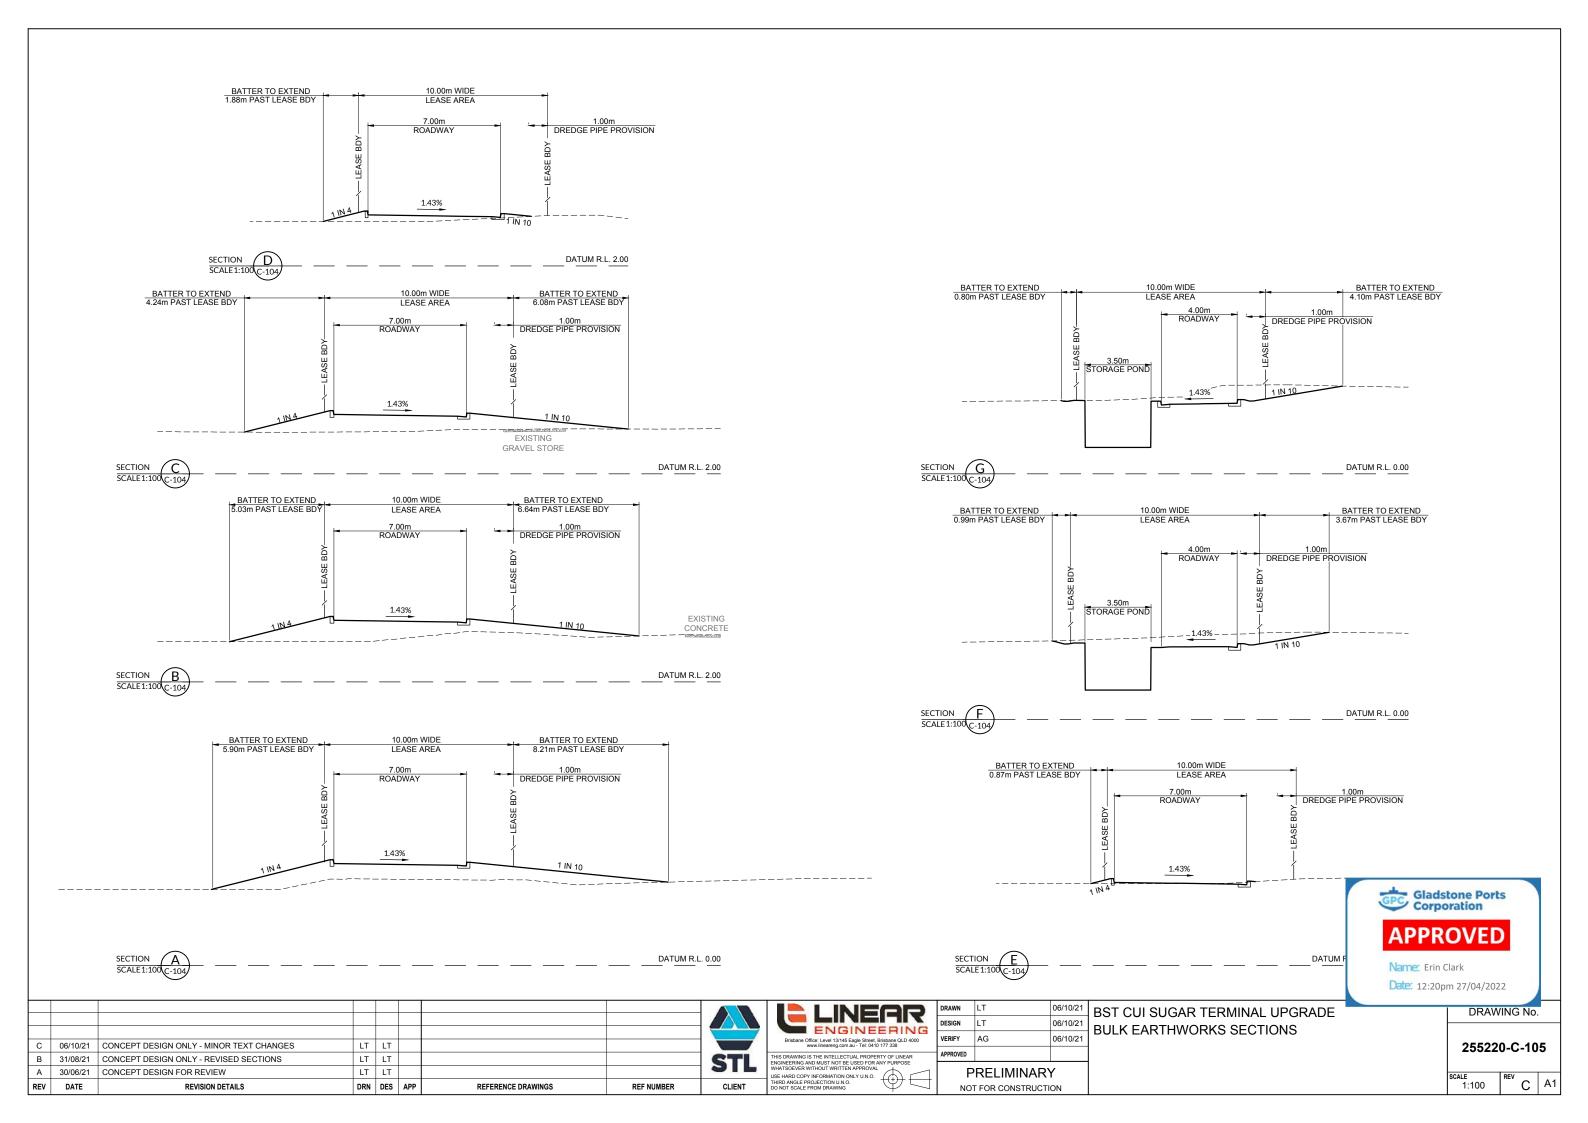

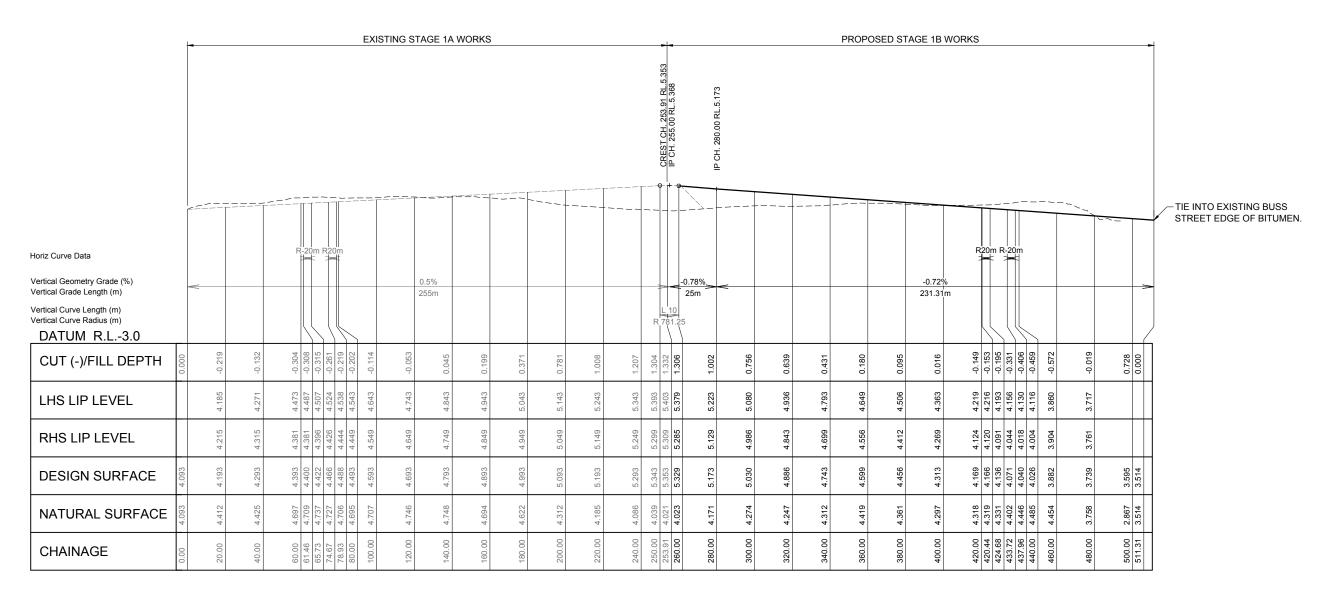

DRIVEWAY LONGITUDINAL SECTION

SCALE: HORIZONTAL 1:1000 VERTICAL 1:100



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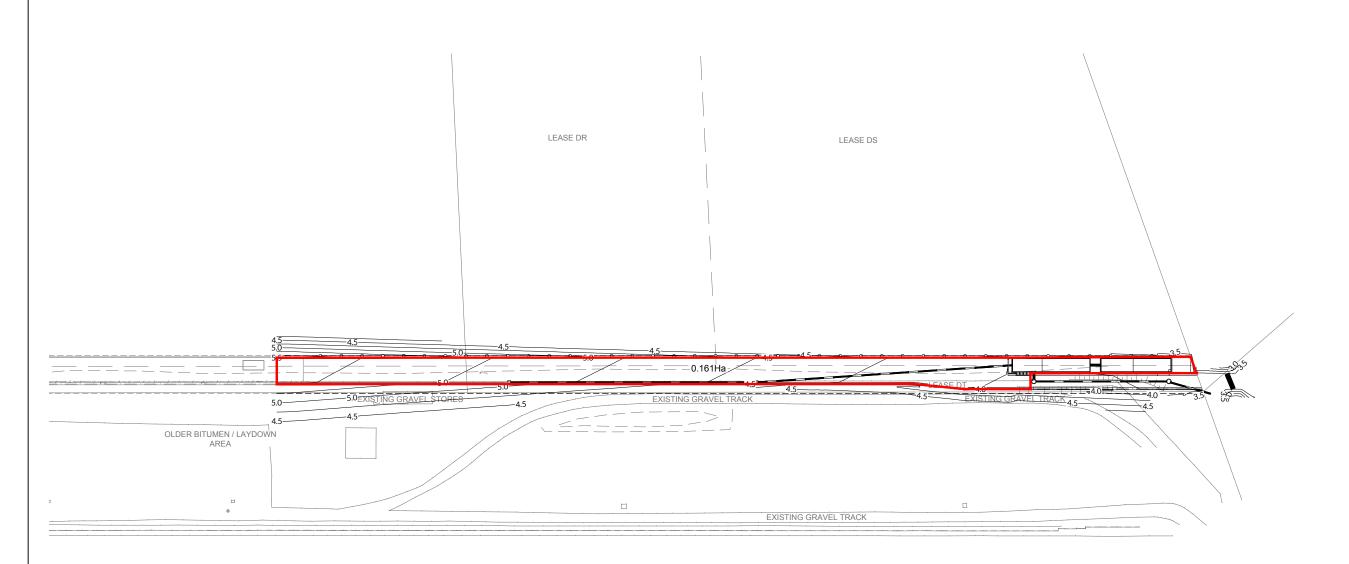
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BST CUI SUGAR TERMINAL UPGRADE CONVEYOR HARDSTAND AND PAVEMENT 1 LONGITUDINAL SECTION

DRAWING No. 255220-C-108

SCALE 1:1000 1:100 REV C A1





CATCHMENT CALCULATIONS

TOTAL CATCHMENT AREA (A) = 0.161Ha FRACTION IMPERVIOUS (fi) = 1.0 DISCHARGE COEFFICIENT (C_{10}) = 0.88 RAINFALL INTENSITY (I) = 299mm/hr (FOR 7mins.) DISCHARGE COEFFICIENT (C_{ARI}) = 1.0 1% AEP FLOW RATE (Q) = 0.147m³/s ROADWAY FLOW VELOCITY (V) = 0.06m/s

ROAD FLOW CAPACITY

IZZARD'S EQUATION Q=0.375 x F x (Z/n) x S^{0.5} x d^{2.667}

FLOW CORRECTION FACTOR (F) = 0.90 CROSS SLOPE GRADIENT (Z) = 1.43% MANNING'S ROUGHNESS (n) = 0.013 LONGITUDINAL SLOPE OF KERB (S) = 0.50% MAXIMUM DEPTH OF FLOW (d) = 0.20m LONGITUDINAL FLOW DOWN KERB (Q) = $0.36\text{m}^3/\text{s}$

LEGEND - PROPOSED

0.2311ha STORMWATER CATCHMENT NUMBER AND AREA STORMWATER

——12.0—— FINISHED MAJOR CONTOURS (0.50m)

FINISHED MINOR CONTOURS (0.25m)

LEGEND - EXISTING



Name: Erin Clark

Date: 12:20pm 27/04/2022

— 12.0 — — MAJOR CONTOURS (1.00m)

— — — MINOR CONTOURS (0.50m)

REV	DATE	REVISION DETAILS	DRN	DES	APP	REFERENCE DRAWINGS	REF NUMBER	CLIENT
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В	08/08/21	REVISED CATCHMENT FOR DISCUSSION	LT	LT				STI
С	06/10/21	CONCEPT DESIGN ONLY - REVISED OUTLET & WORK EXTENTS	LT	LT				


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NOT FOR CONSTRUCTION

BST CUI SUGAR TERMINAL UPGRADE
STORMWATER CATCHMENT PLAN

DRAWING No.								
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C 06/10/21 CONCEPT DESIGN ONLY - REVISED OUTLET & WORK EXTENTS

REVISION DETAILS

B 31/08/21 CONCEPT DESIGN ONLY - REVISED STORMWATER LAYOUT

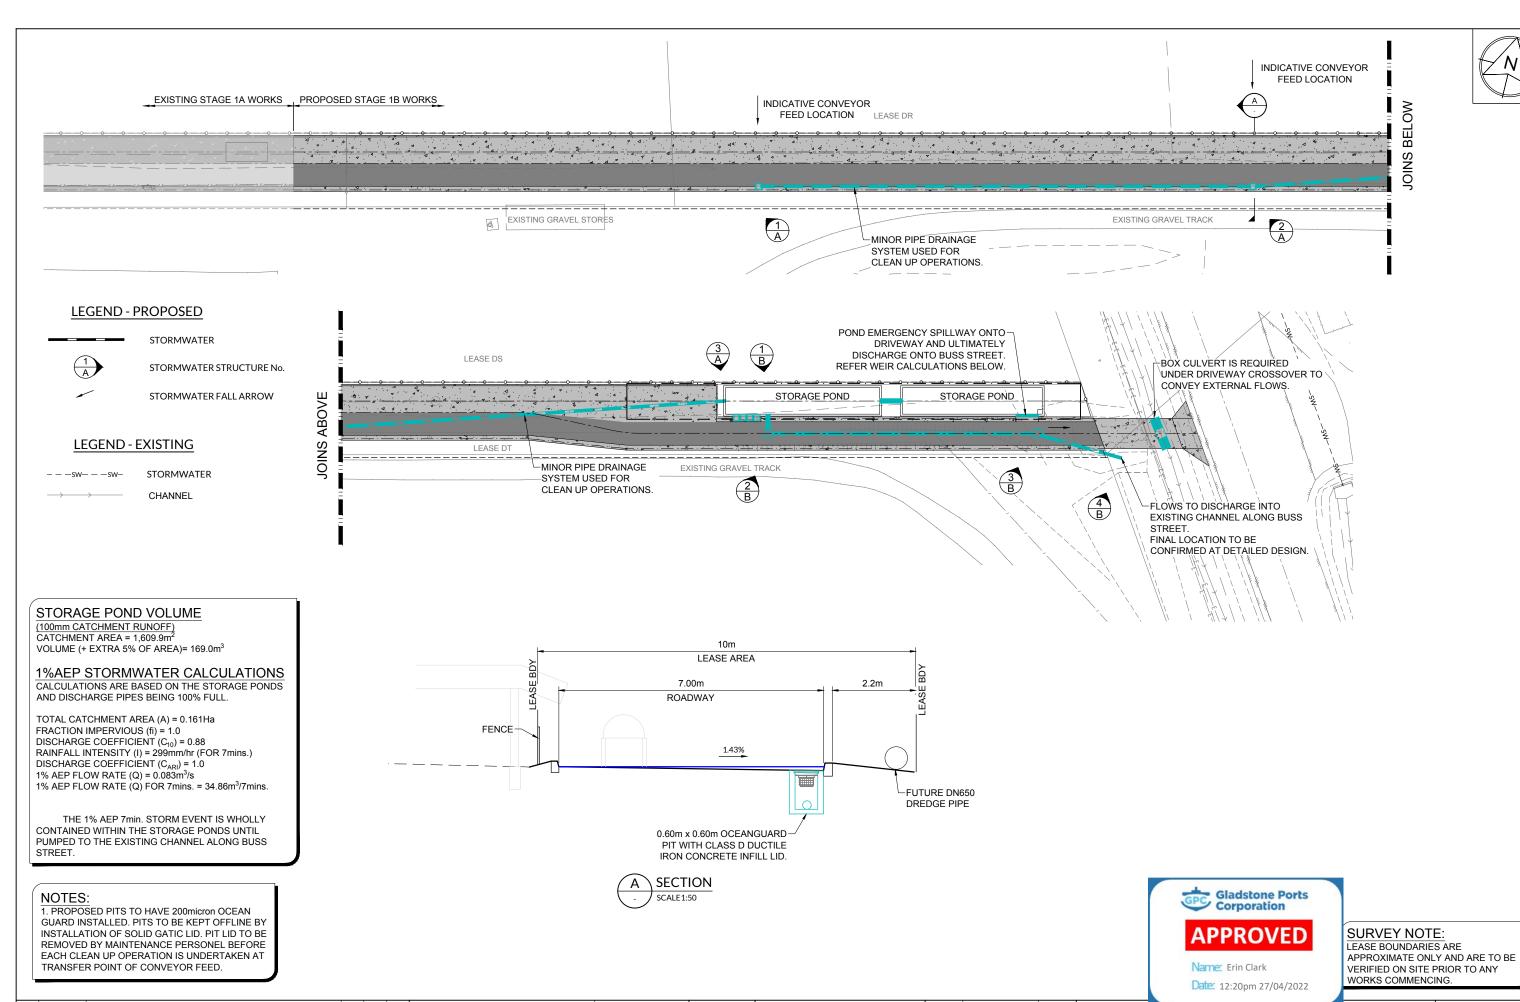30/06/21 CONCEPT DESIGN FOR REVIEW

DATE

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REF NUMBER

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DRAWING No.

255220-C-111

SCALE 1:250 REV C A1

BST CUI SUGAR TERMINAL UPGRADE

STORMWATER DRAINAGE LAYOUT PLAN

DESIGN LT

VERIFY

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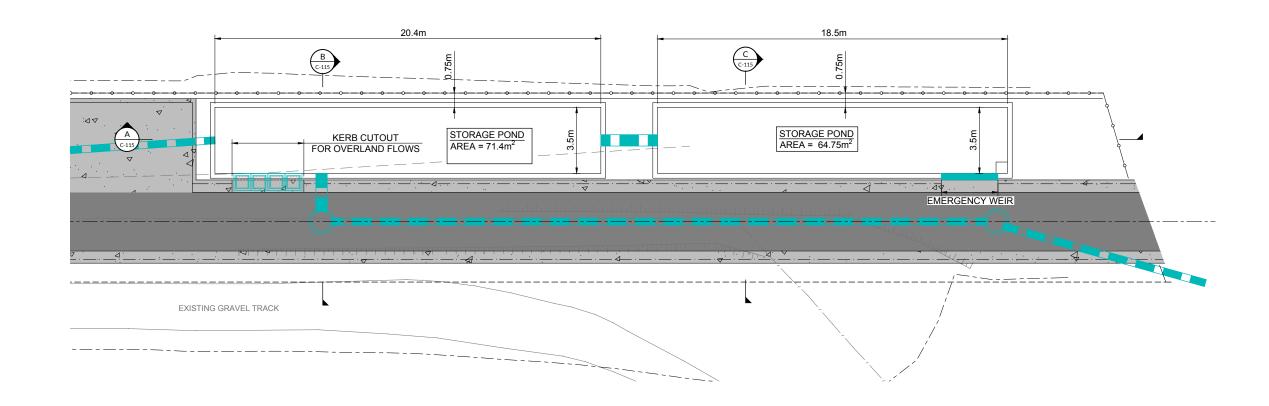
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LEGEND - PROPOSED

STORMWATER

AC PAVEMENT

CONCRETE PAVEMENT





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С	06/10/21	CONCEPT DESIGN ONLY - REVISED OUTLET & WORK EXTENTS	LT	LT					www.lineareng.com.au - Tel: 0410 177 338		7.0	00/10/21	
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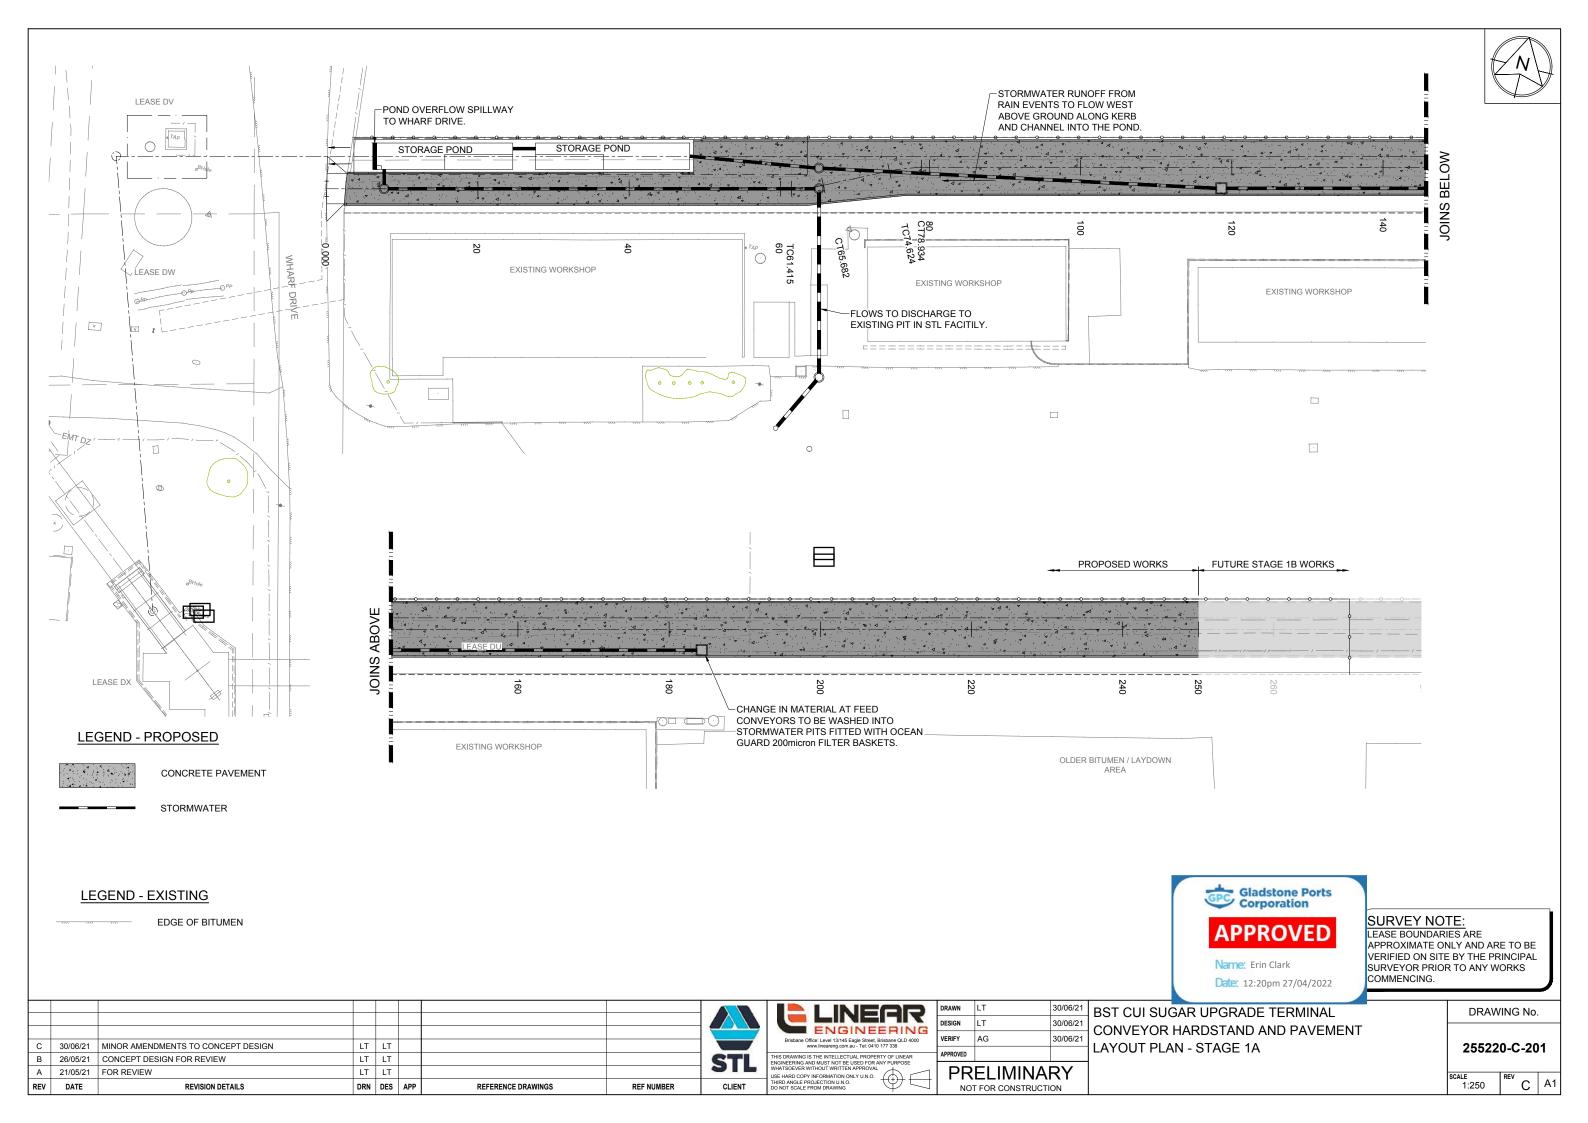
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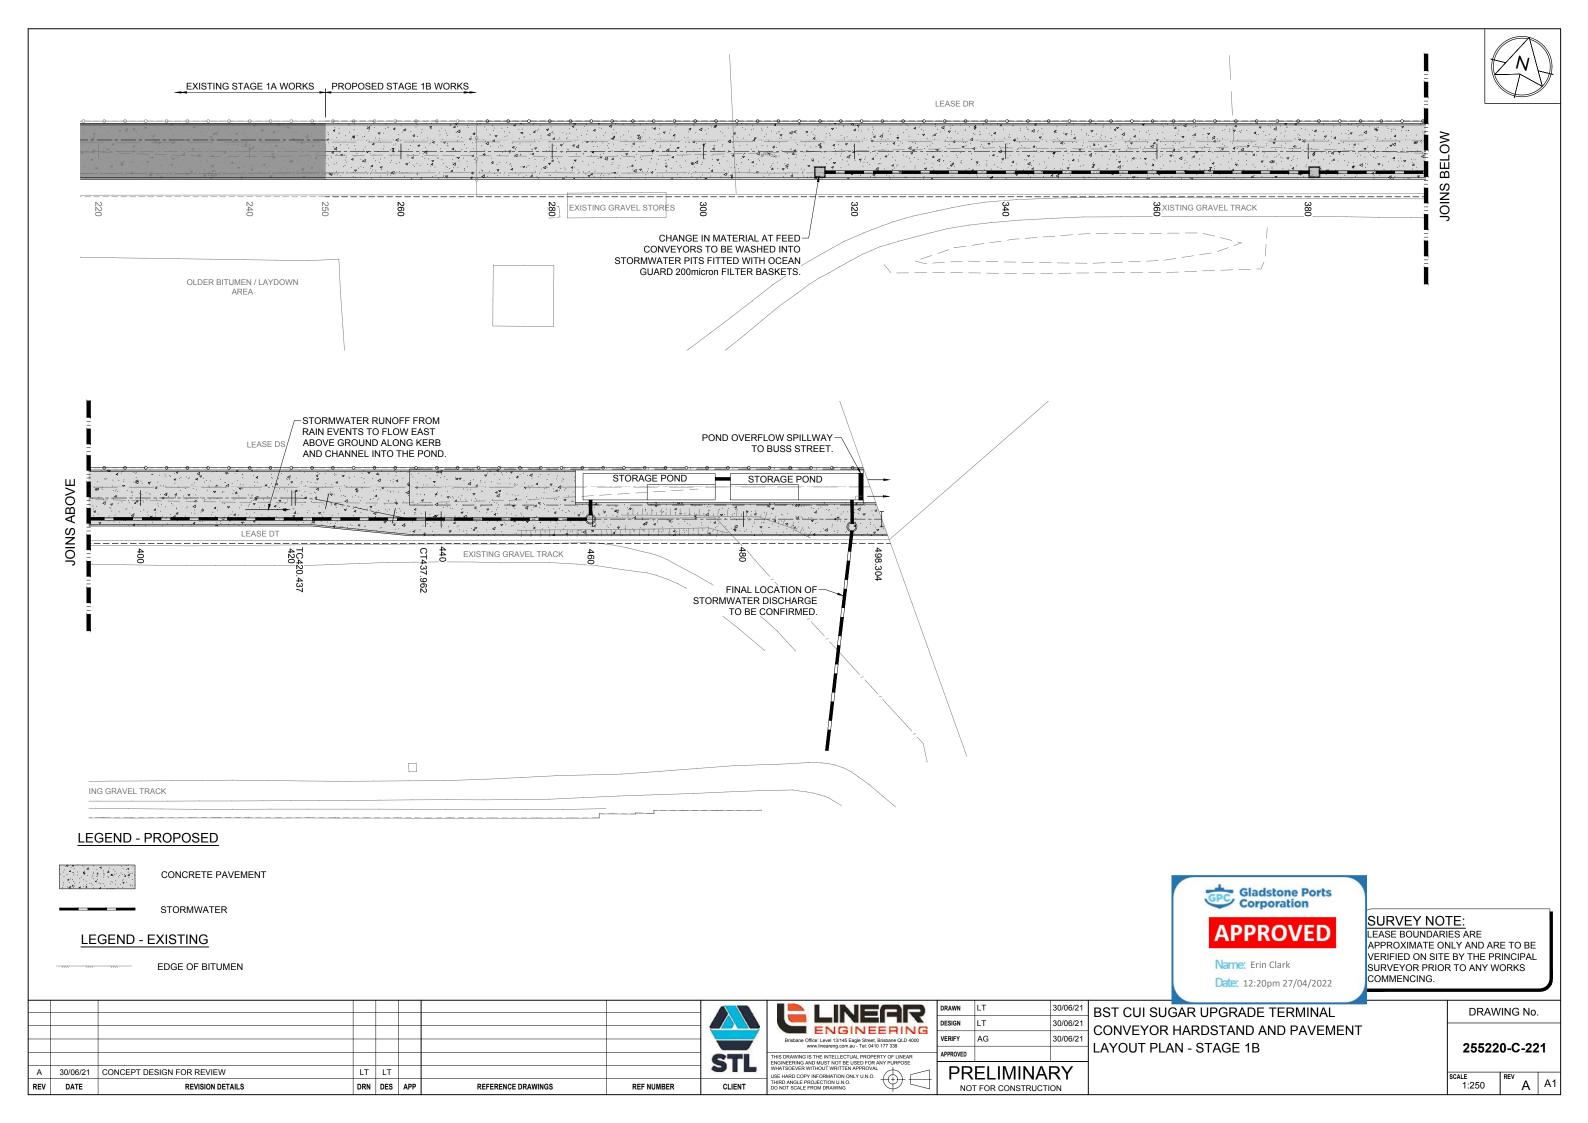
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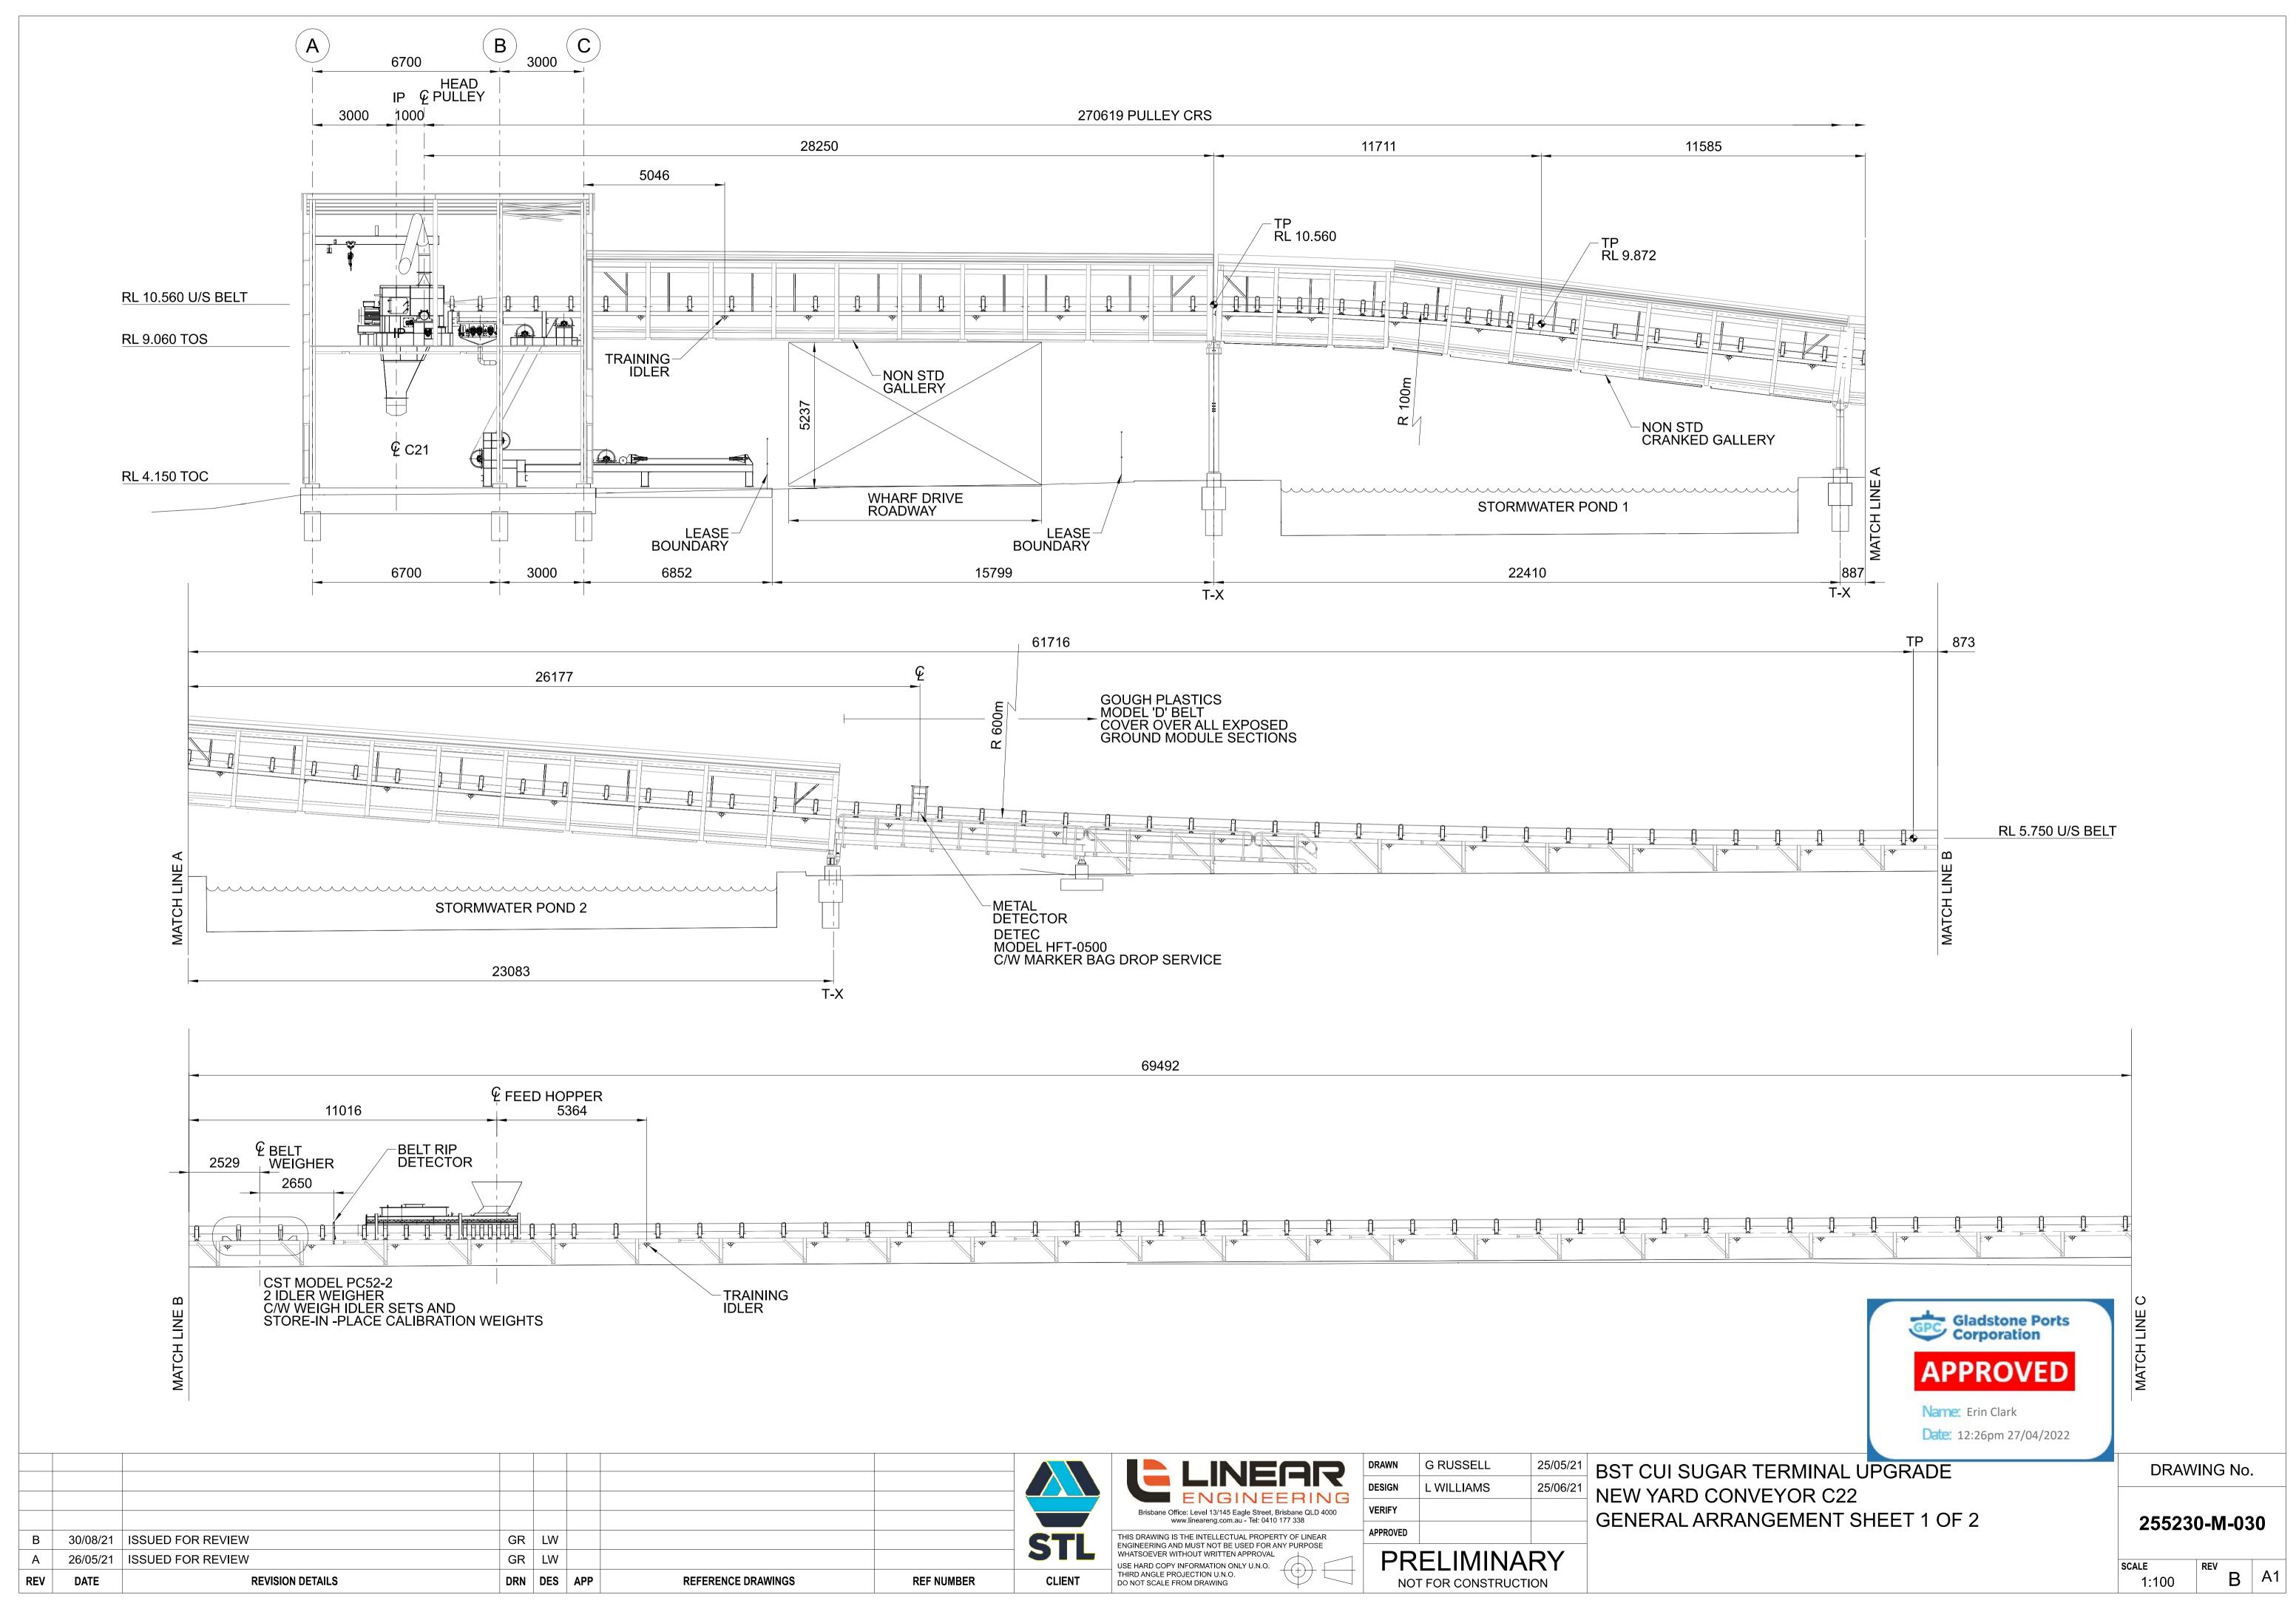
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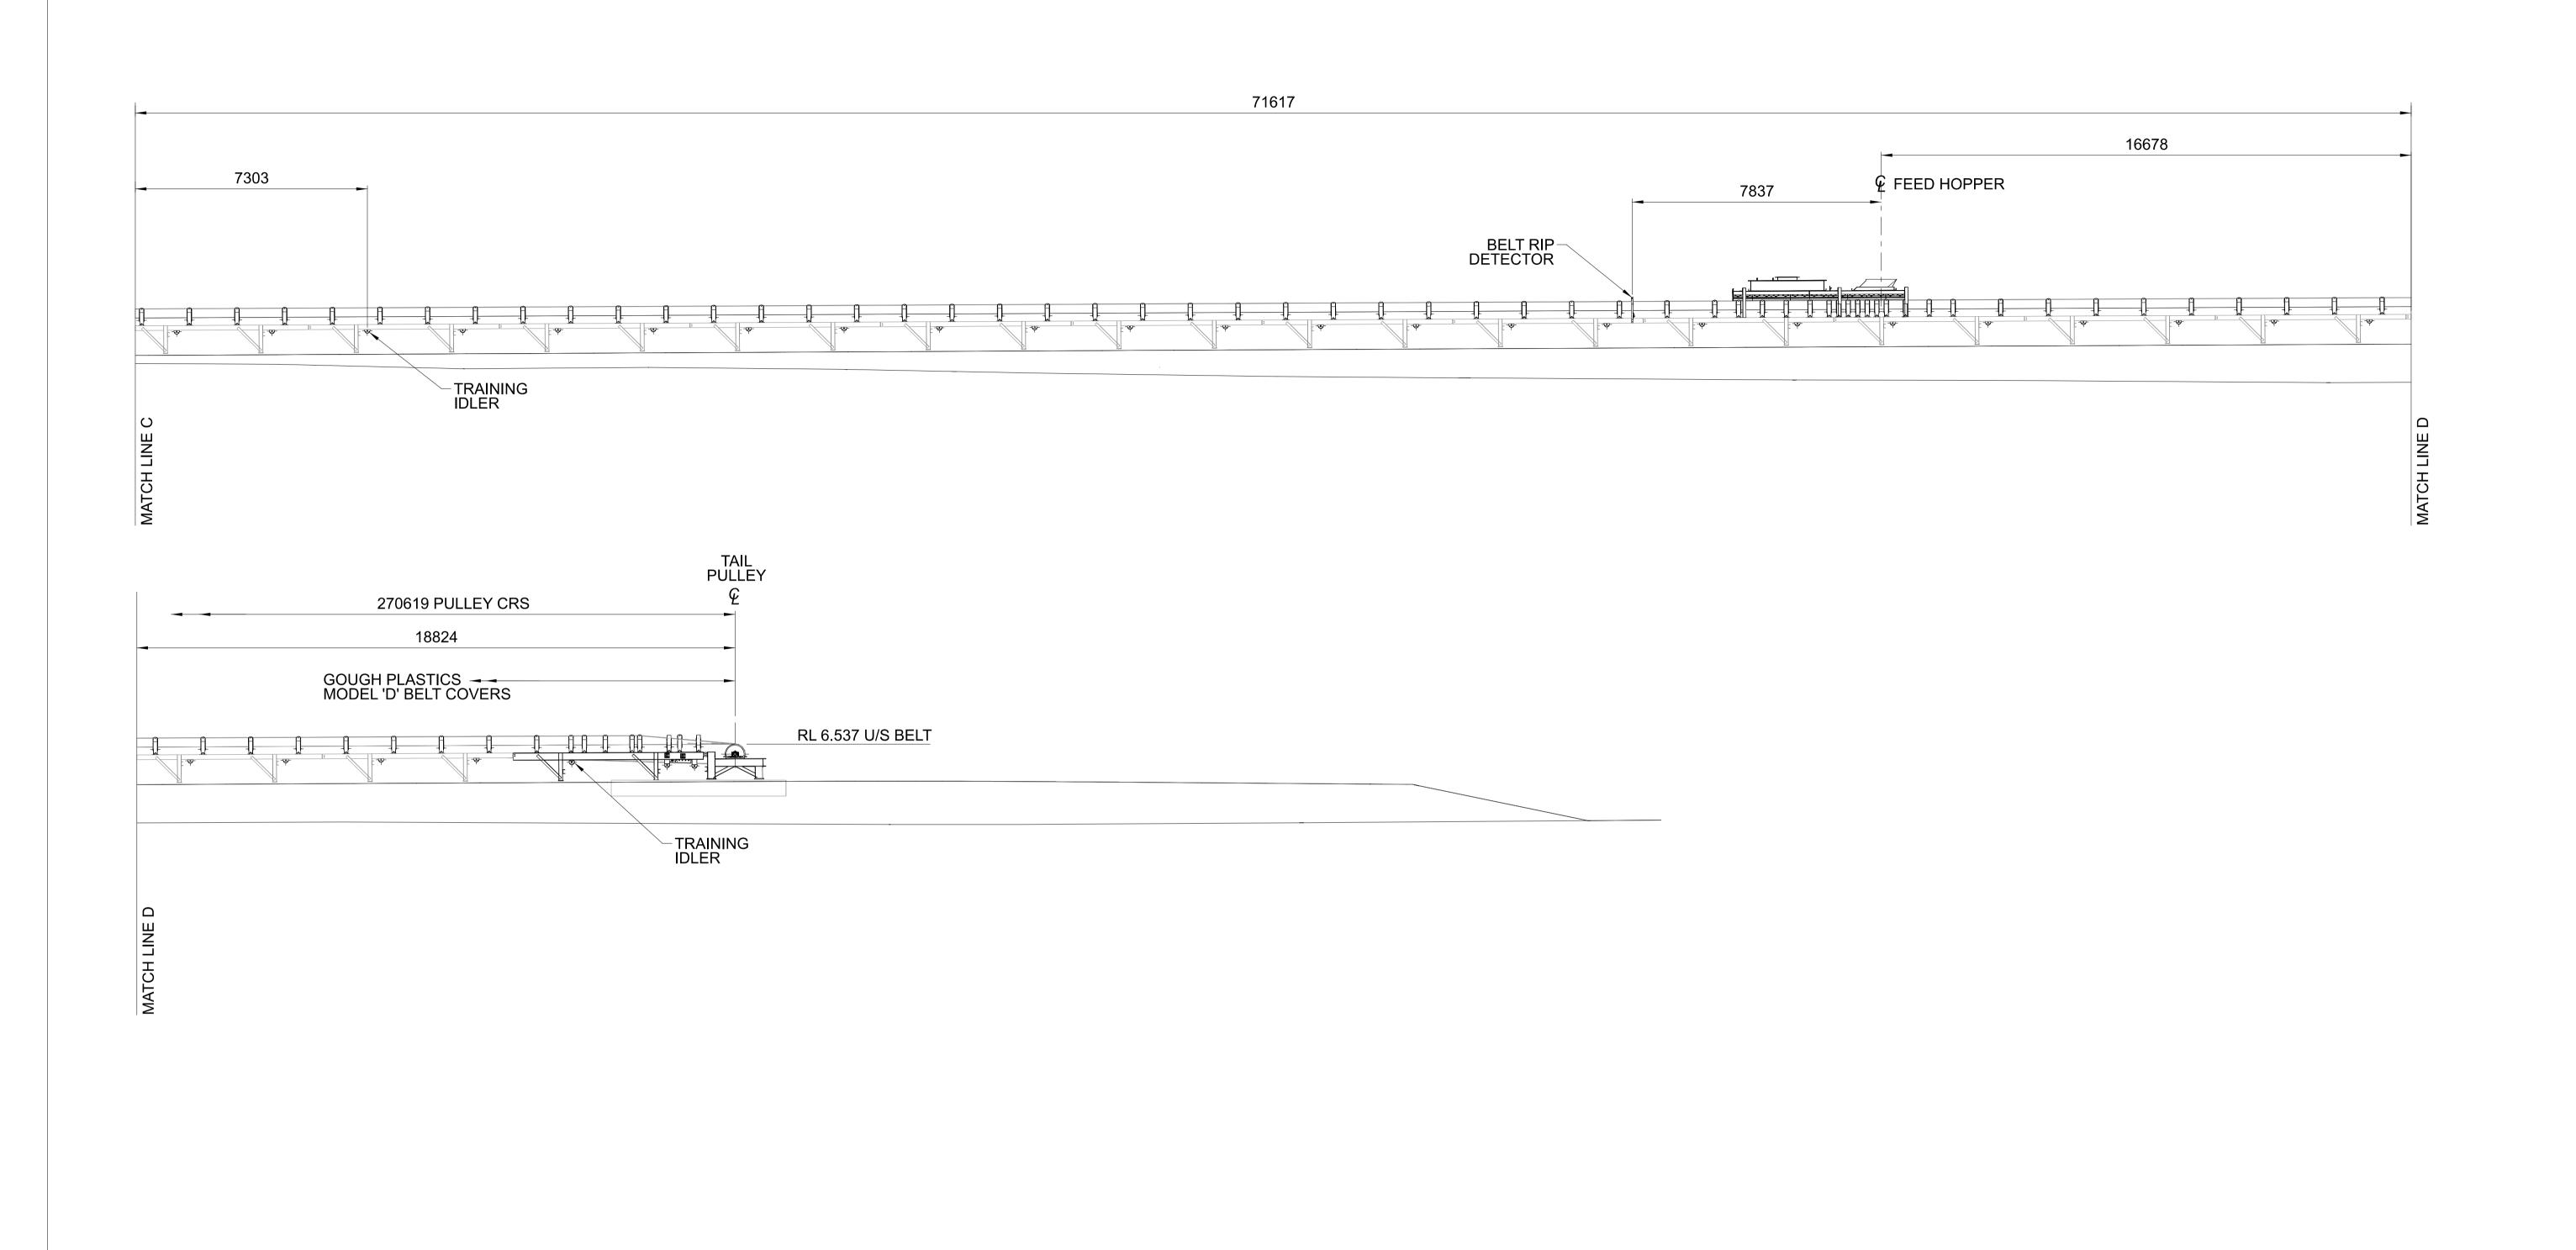








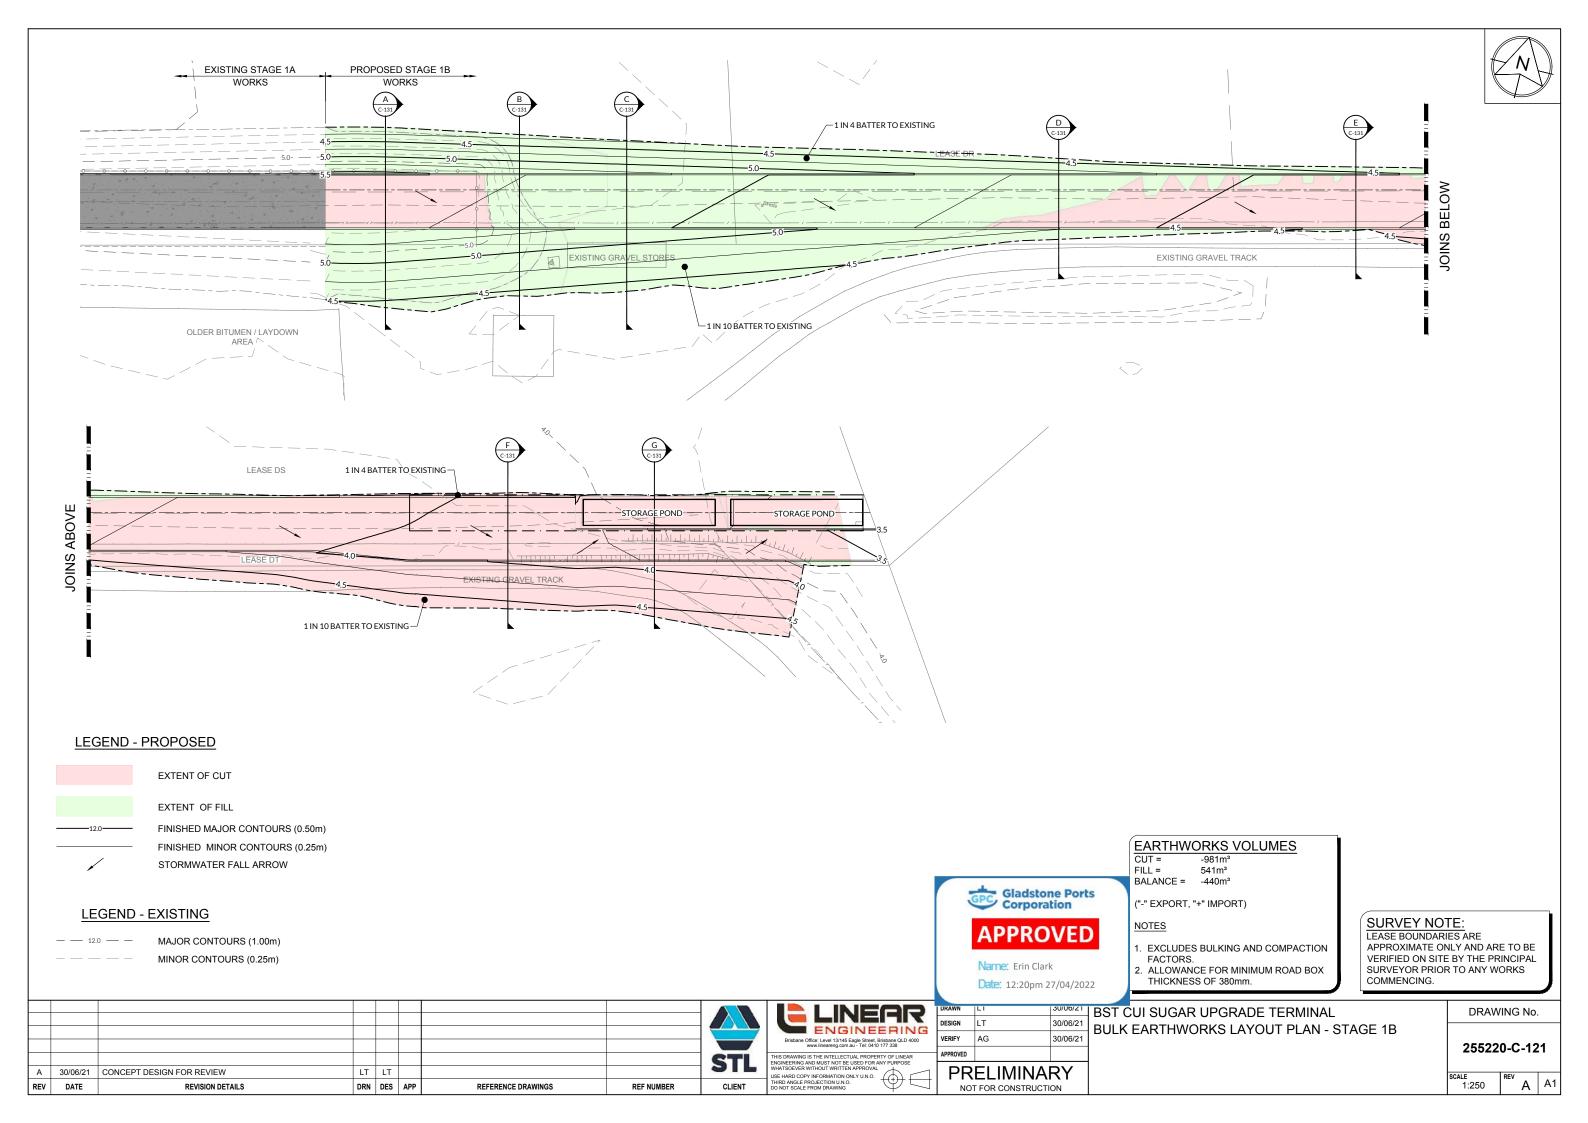

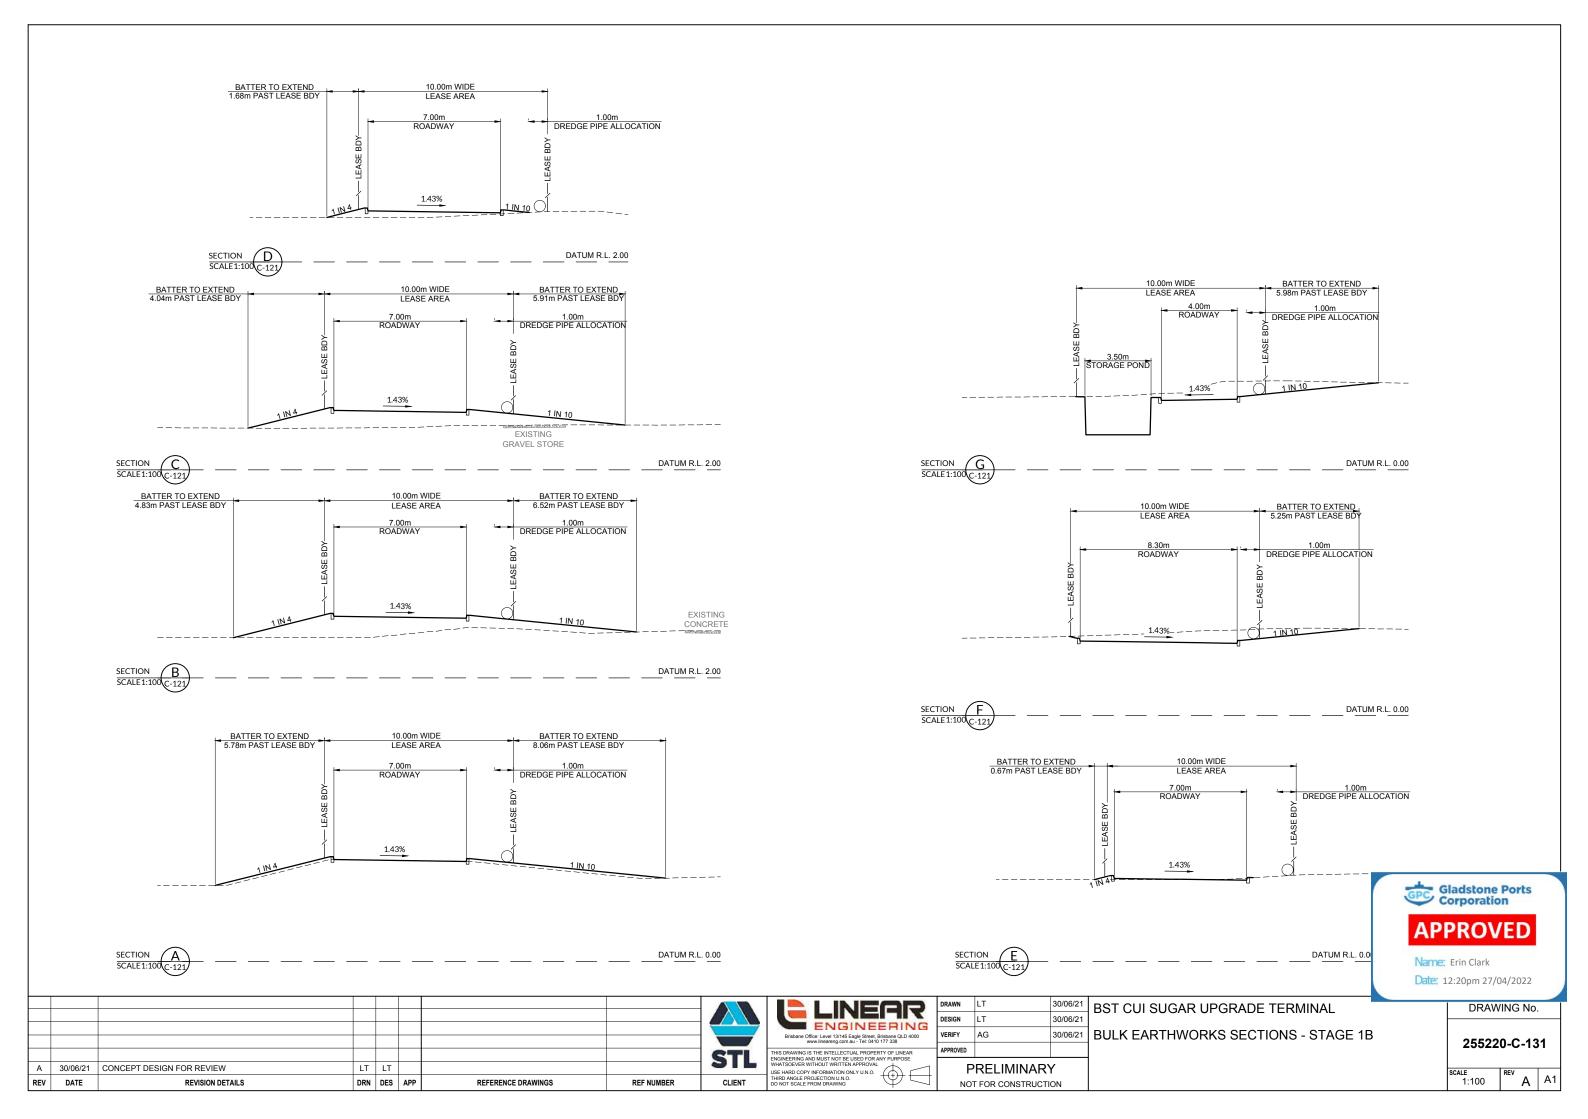



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THIRD ANGLE PROJECTION U.N.O.
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000	VERIFY		
IG	DESIGN	L WILLIAMS	25/06/21
5	DRAWN	G RUSSELL	25/05/21


NOT FOR CONSTRUCTION

BST CUI SUGAR TERMINAL UPGRADE
NEW YARD CONVEYOR C22
GENERAL ARRANGEMENT SHEET 2 OF 2

DRAWING No.
255230-M-031

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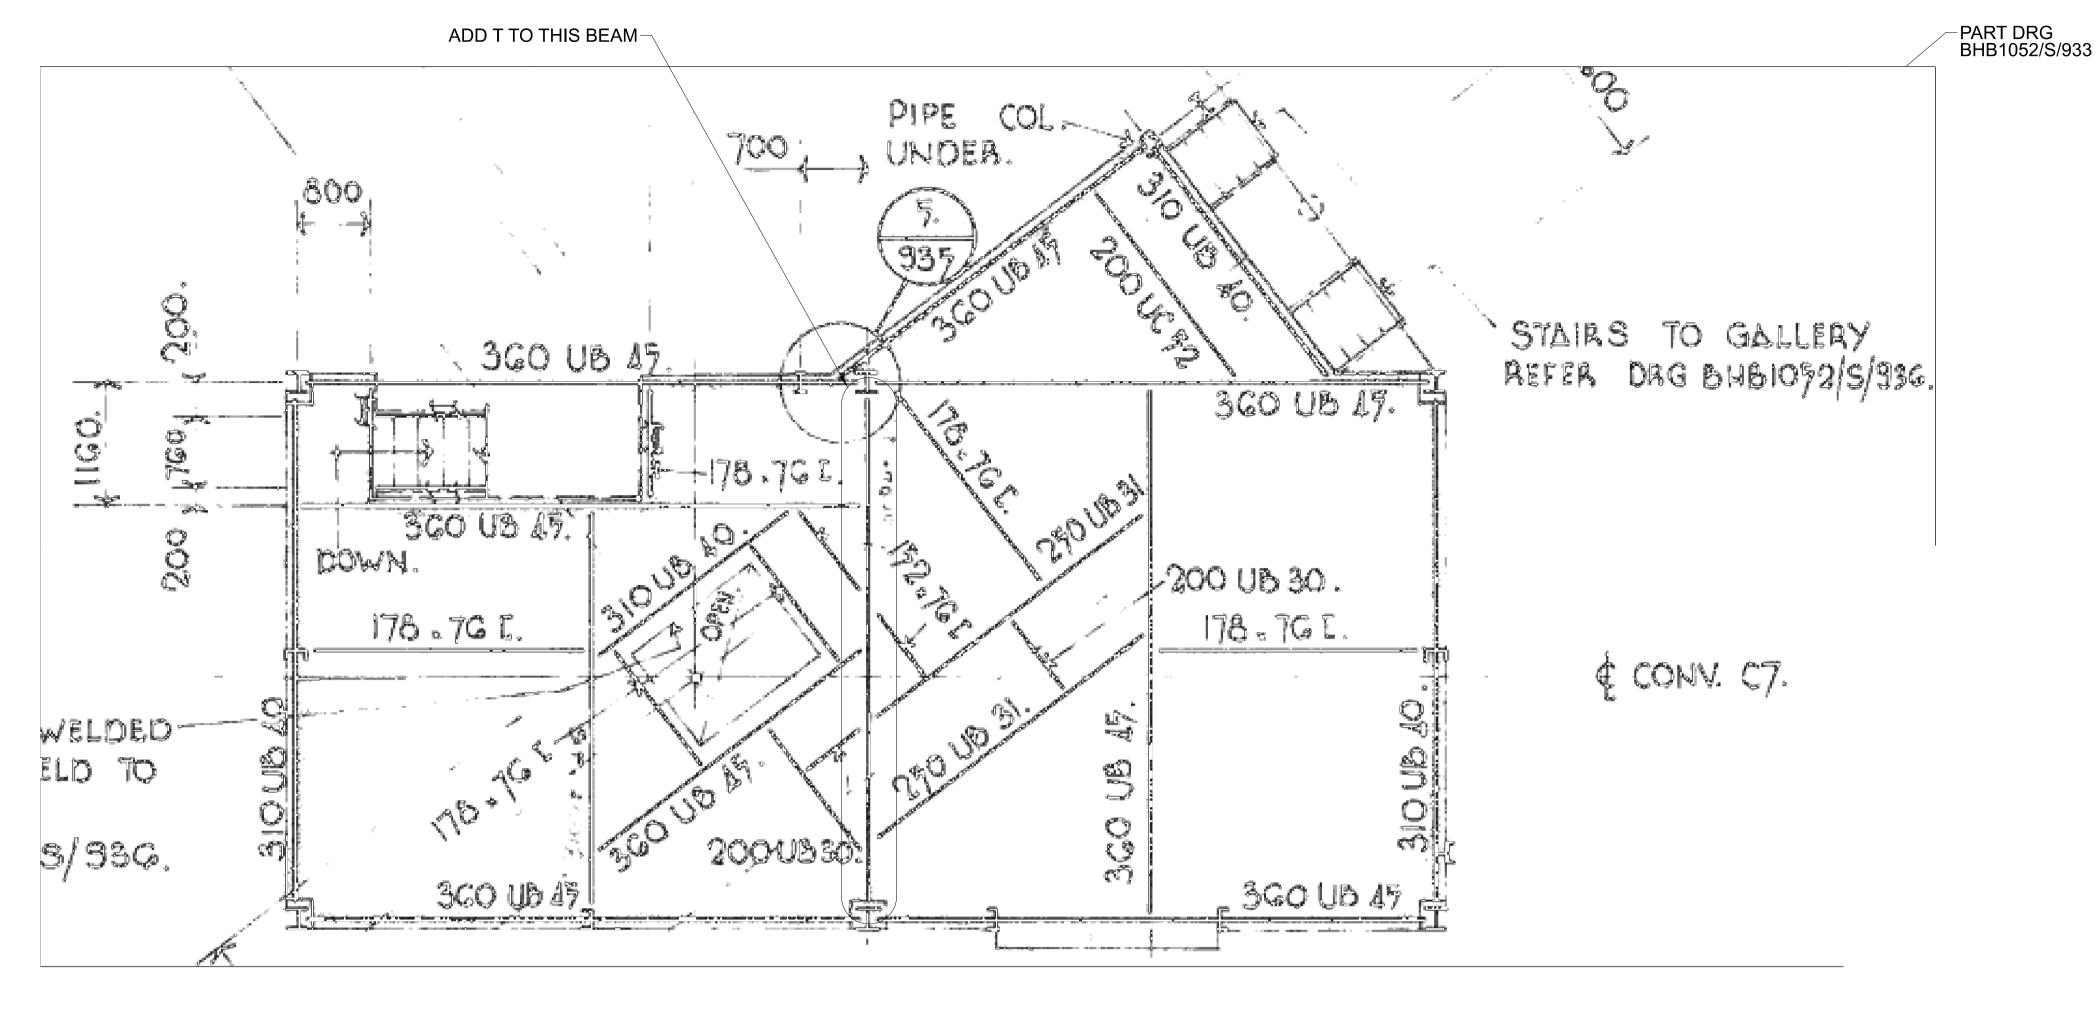
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BST CUI SUGAR TERMINAL UPGRADE
NEW CROSS CONVEYOR C21
GENERAL ARRANGEMENT

DRAWING No.

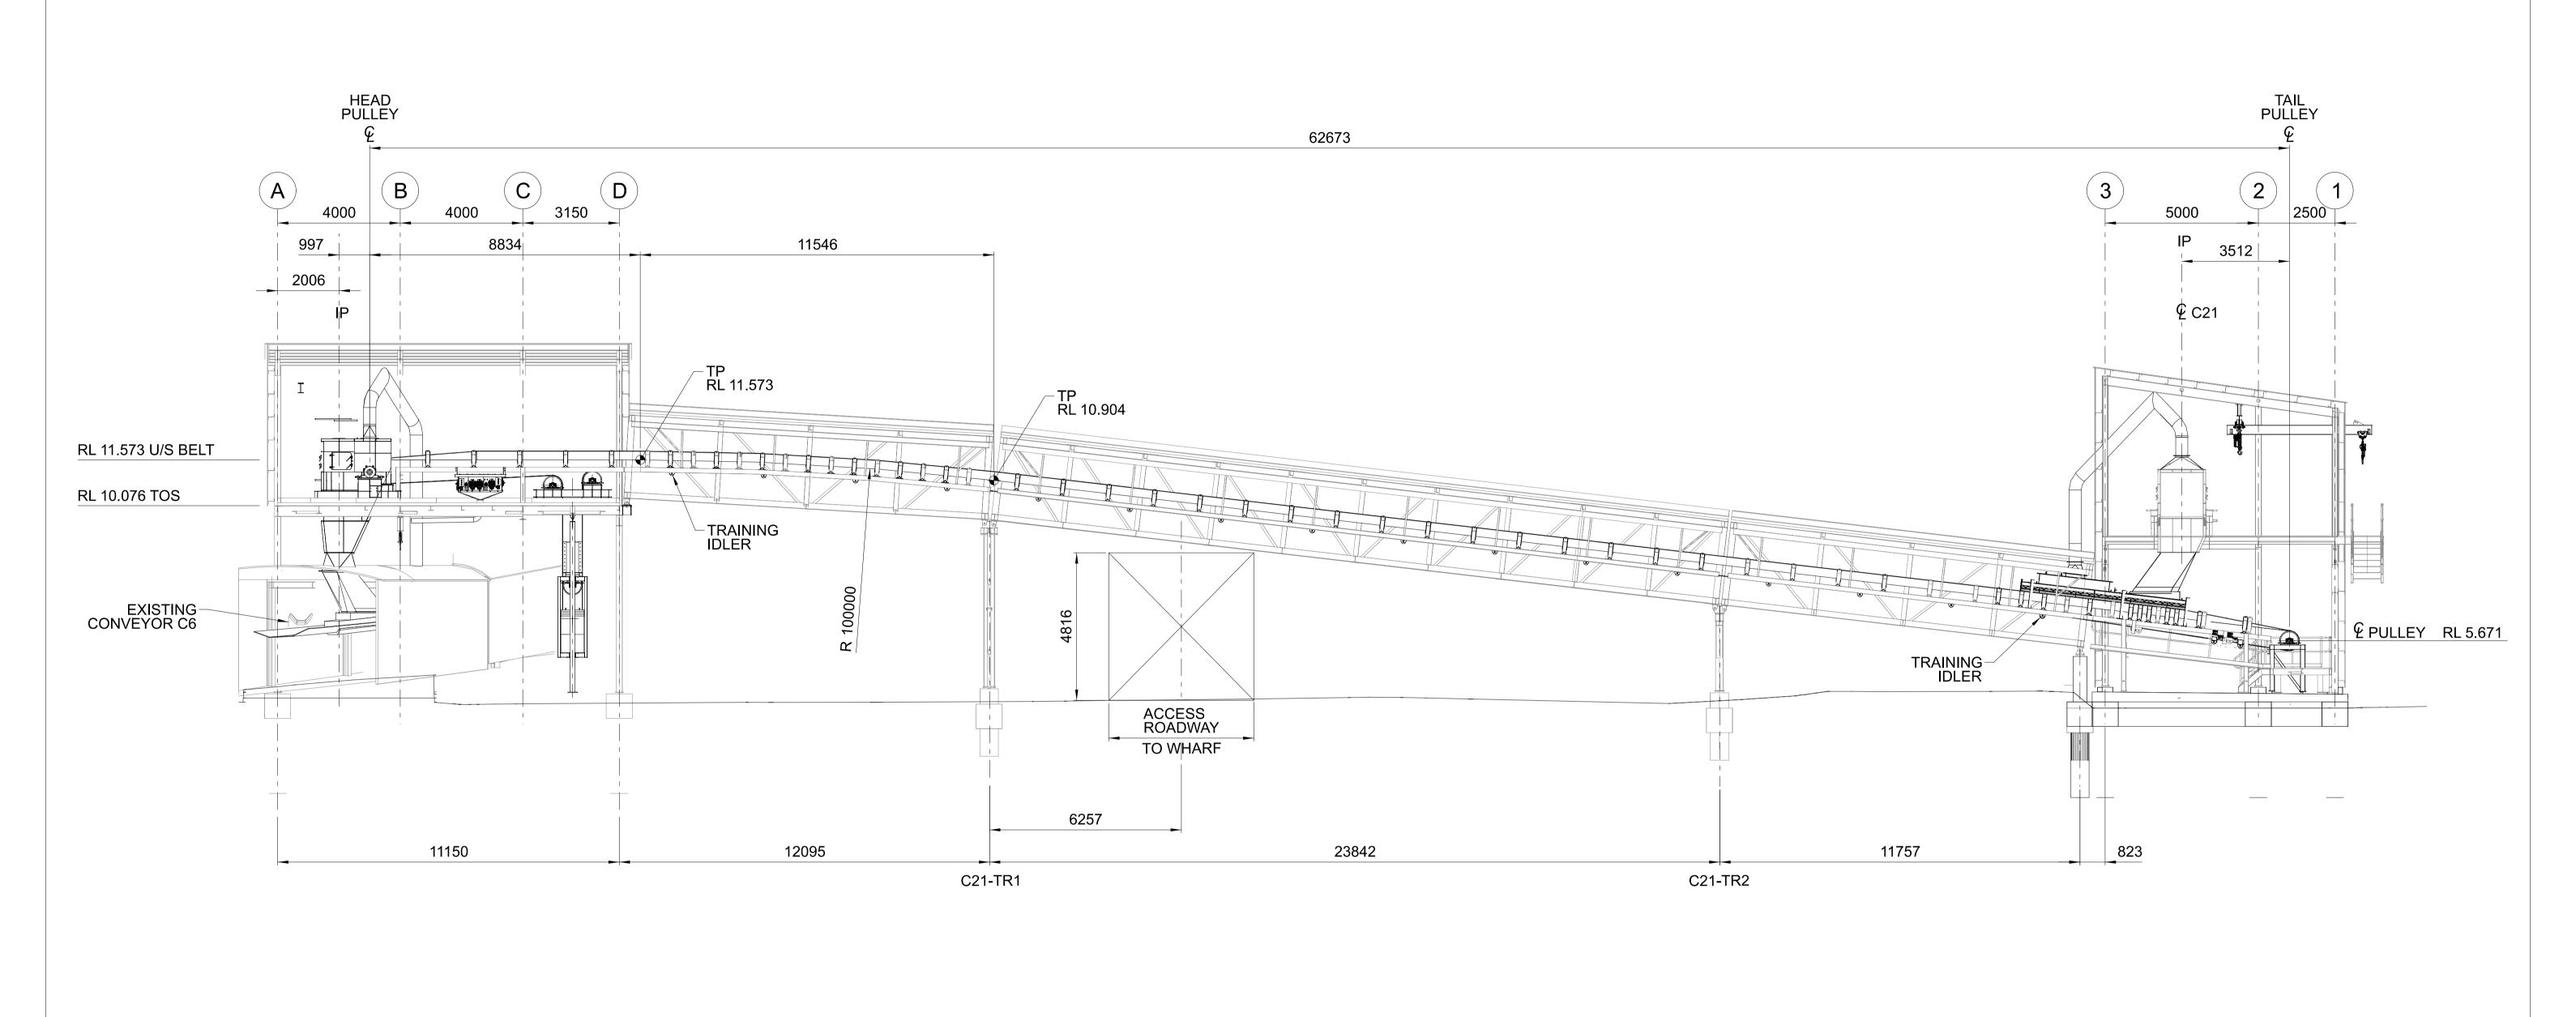
255240-M-050

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NOTES:

1. FOR STANDARD NOTES REFER GRG 255000- STD-001

2. ALL EQUIPMENT DIMENSIONS SHALL BE CONFIRMED WITH CERTIFIED VENDOR INFORMATION

3. ALL BOLTS SHALL BE HD GALVANISED GR.8.8/S UNO

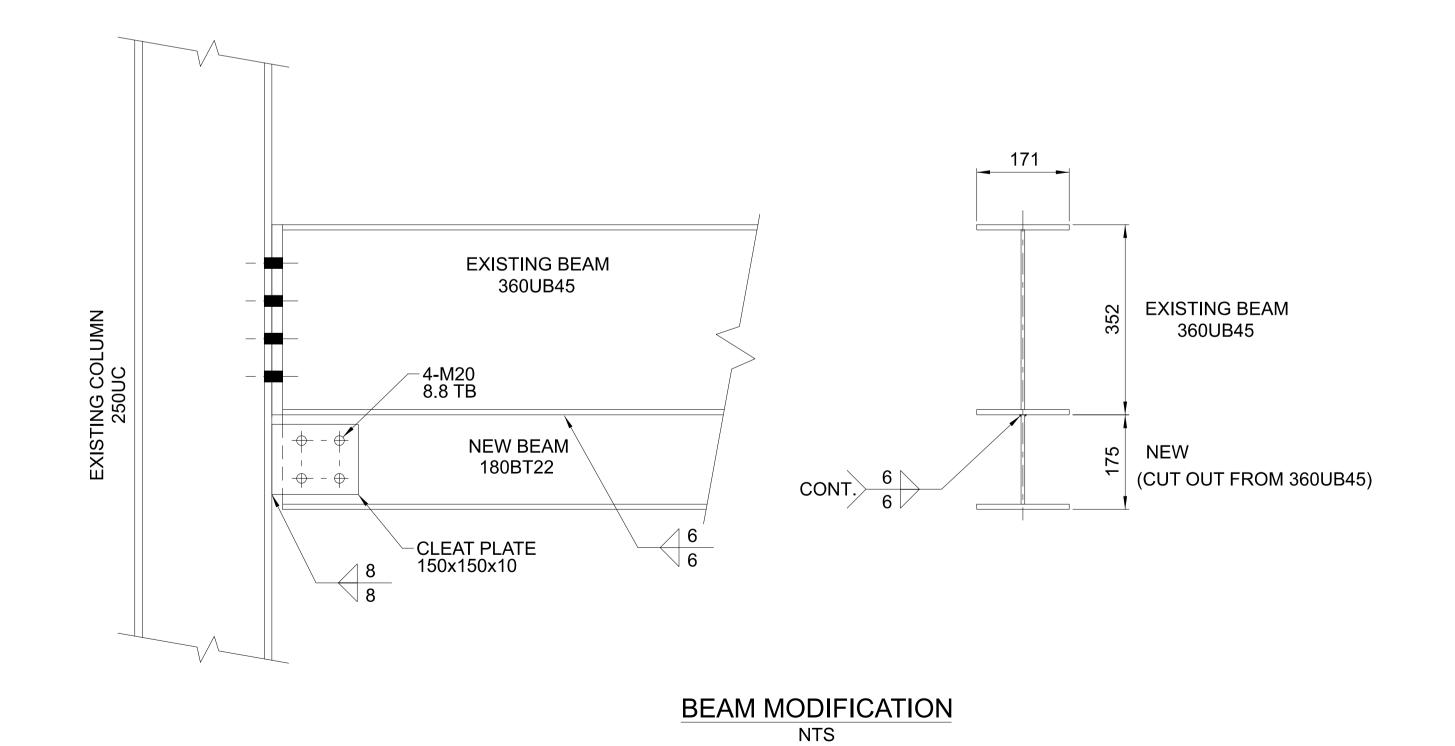

Date: 12:26pm 27/04/2022

PORT OF BUNDABERG COMMON USER INFRASTRUCTURE CONVEYOR C6 TO C7 TRANSFER STRENGTHENING WORKS

DRAWING No. 255250-M-071 NTS

			_				
0	15.10.21	ISSUED FOR CONSTRUCTION G.R.	L.W.	G.H.			
REV	DATE	REVISION DETAILS DRN	DES	APP	REFERENCE DRAWINGS	REF NUMBER	






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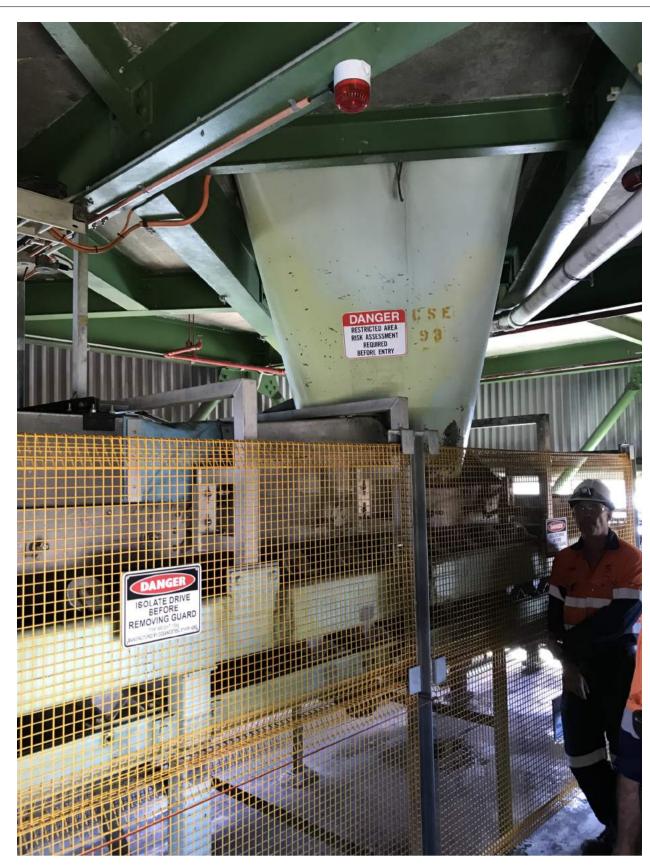
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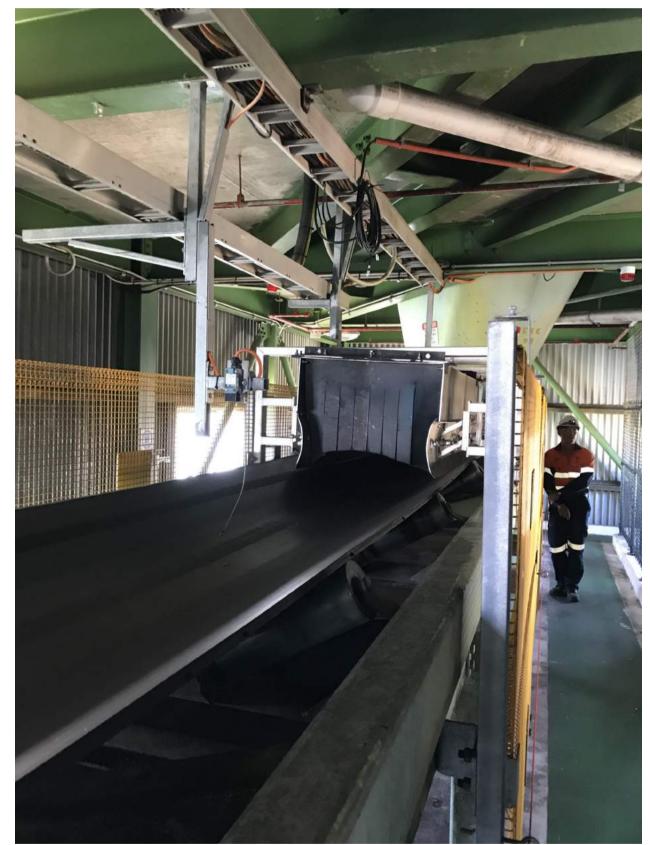
15.10.21 VERIFY L.WILLIAMS APPROVED G.HARGREAVES 15.10.21 FOR CONSTRUCTION

G.RUSSELL

R.STEELE





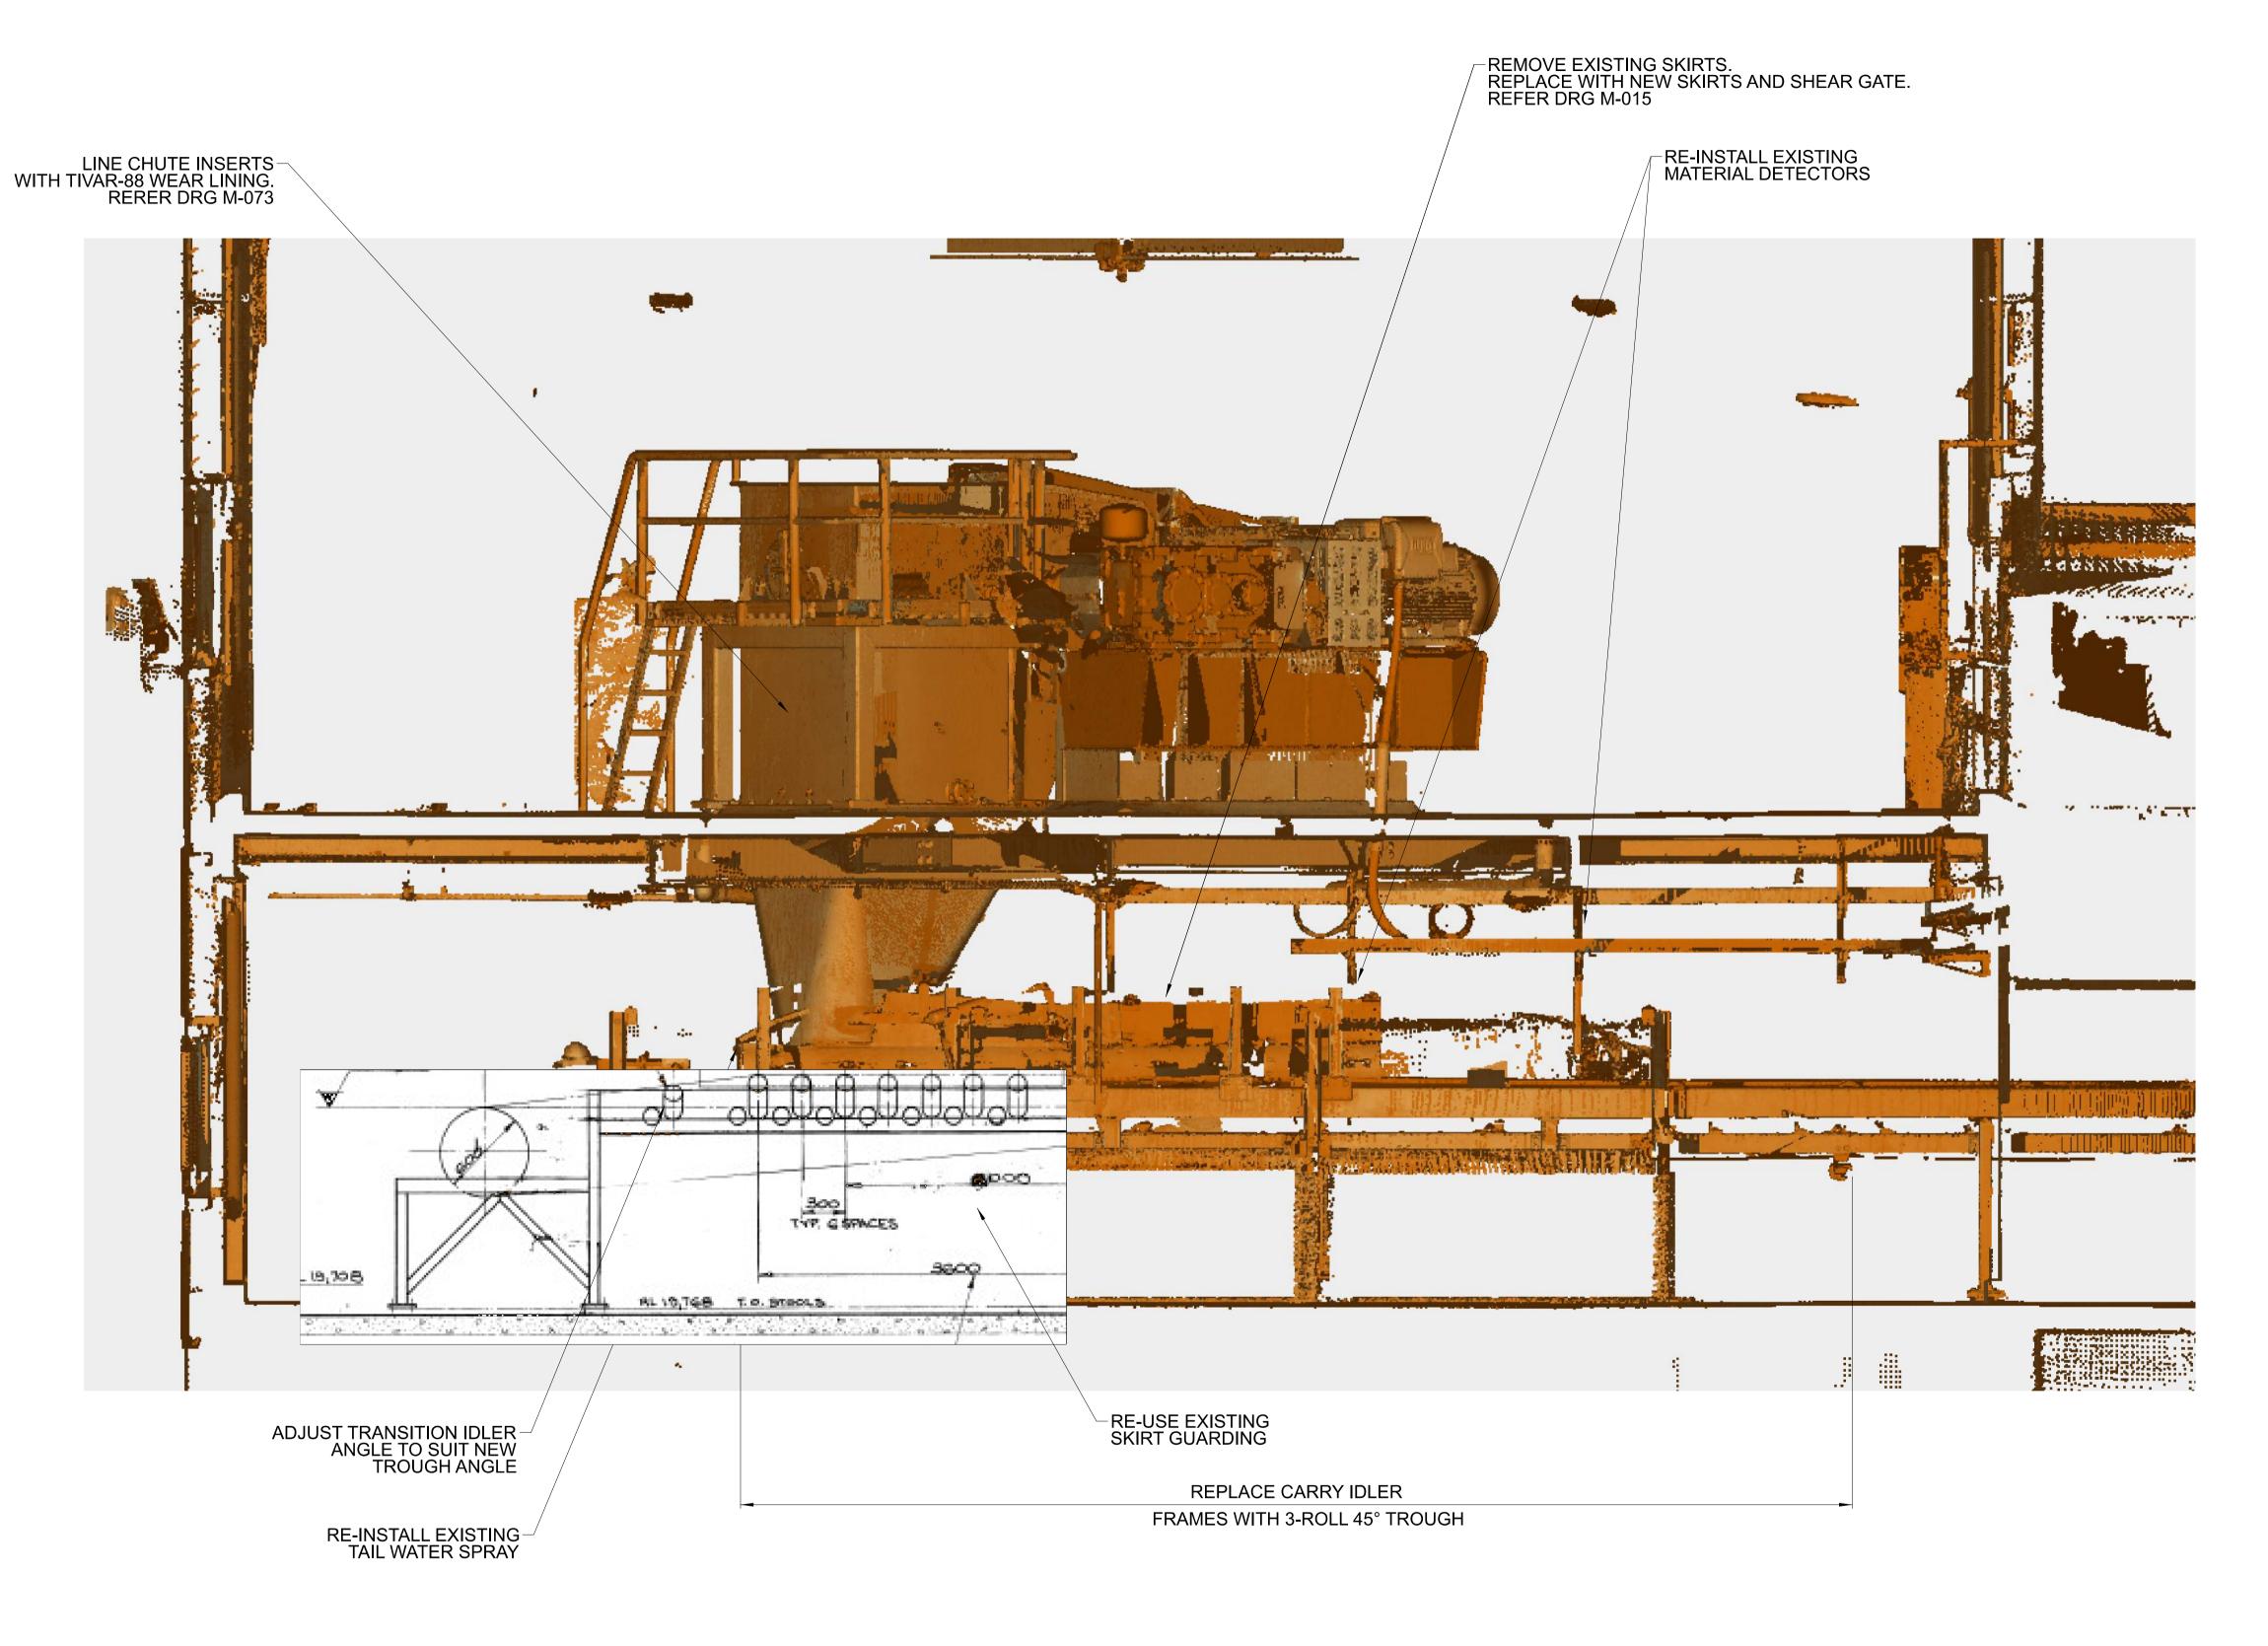

EXISTING C7 TAIL END

Gladstone Ports
Corporation

APPROVED

Name: Erin Clark
Date: 12:26pm 27/04/2022

	STL
REF NUMBER	CLIENT

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THIRD ANGLE PROJECTION U.N.O.
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4000	VERIFY	G.HARGREAVES	15.10.21
VIC.	DESIGN	L.WILLIAMS	15.10.21
9	DRAWN	G.RUSSELL	15.10.21

PORT OF BUNDABERG COMMON USER INFRASTRUCTURE
CONVEYOR C7
TAIL END SKIRT MODIFICATIONS

DRAWING No.
255250-M-072

scale REV 0 A1

15.10.21

DATE

REV


ISSUED FOR CONSTRUCTION

REVISION DETAILS

G.R. L.W. G.H.

DRN DES APP

REFERENCE DRAWINGS

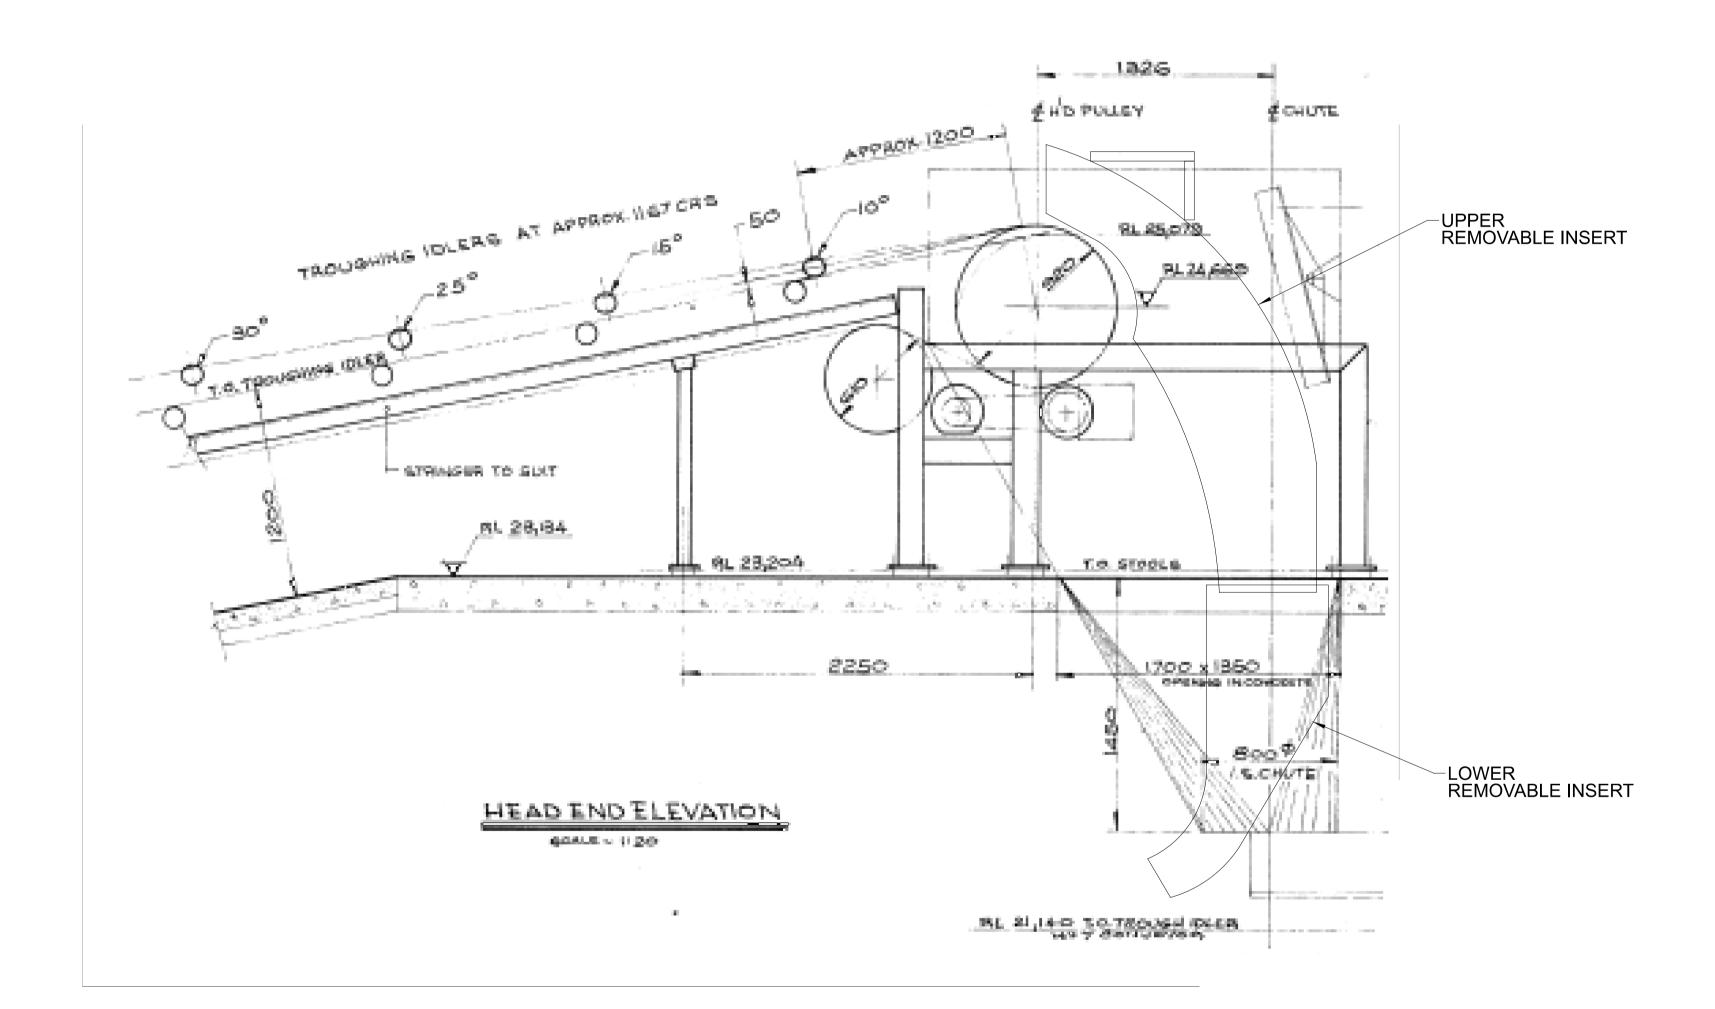









CHUTE INSERT MODIFICATIONS

SCOPE:

REMOVE INSERTS TO WORKSHOP
 DETAIL MEASURE AND PRODUCE DRAWINGS
 LINE INSIDE WITH 15mm TIVAR-88 "BLACK" UHMW-PE USING THROUGH BOLT ATTACHMENT
 RETURN TO SITE AND RE-INSTALL

GPC Gladstone Ports Corporation APPROVED Name: Erin Clark Date: 12:26pm 27/04/2022

PORT OF BUNDABERG COMMON USER INFRASTRUCT	UR
CONVEYOR C6/C7 TRANSFER	

DRAWING No. 255250-M-073 NTS

REV	DATE	REVISION DETAILS	DRN DES	APP	REFERENCE DRAWINGS	REF NUMBER
0	15.10.21	ISSUED FOR CONSTRUCTION	G.R. L.W.	G.H.		





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THIRD ANGLE PROJECTION U.N.O.
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15.10.21 VERIFY M.FRENDO APPROVED G.HARGREAVES 15.10.21


G.RUSSELL

L.WILLIAMS


FOR CONSTRUCTION

15.10.21


15.10.21

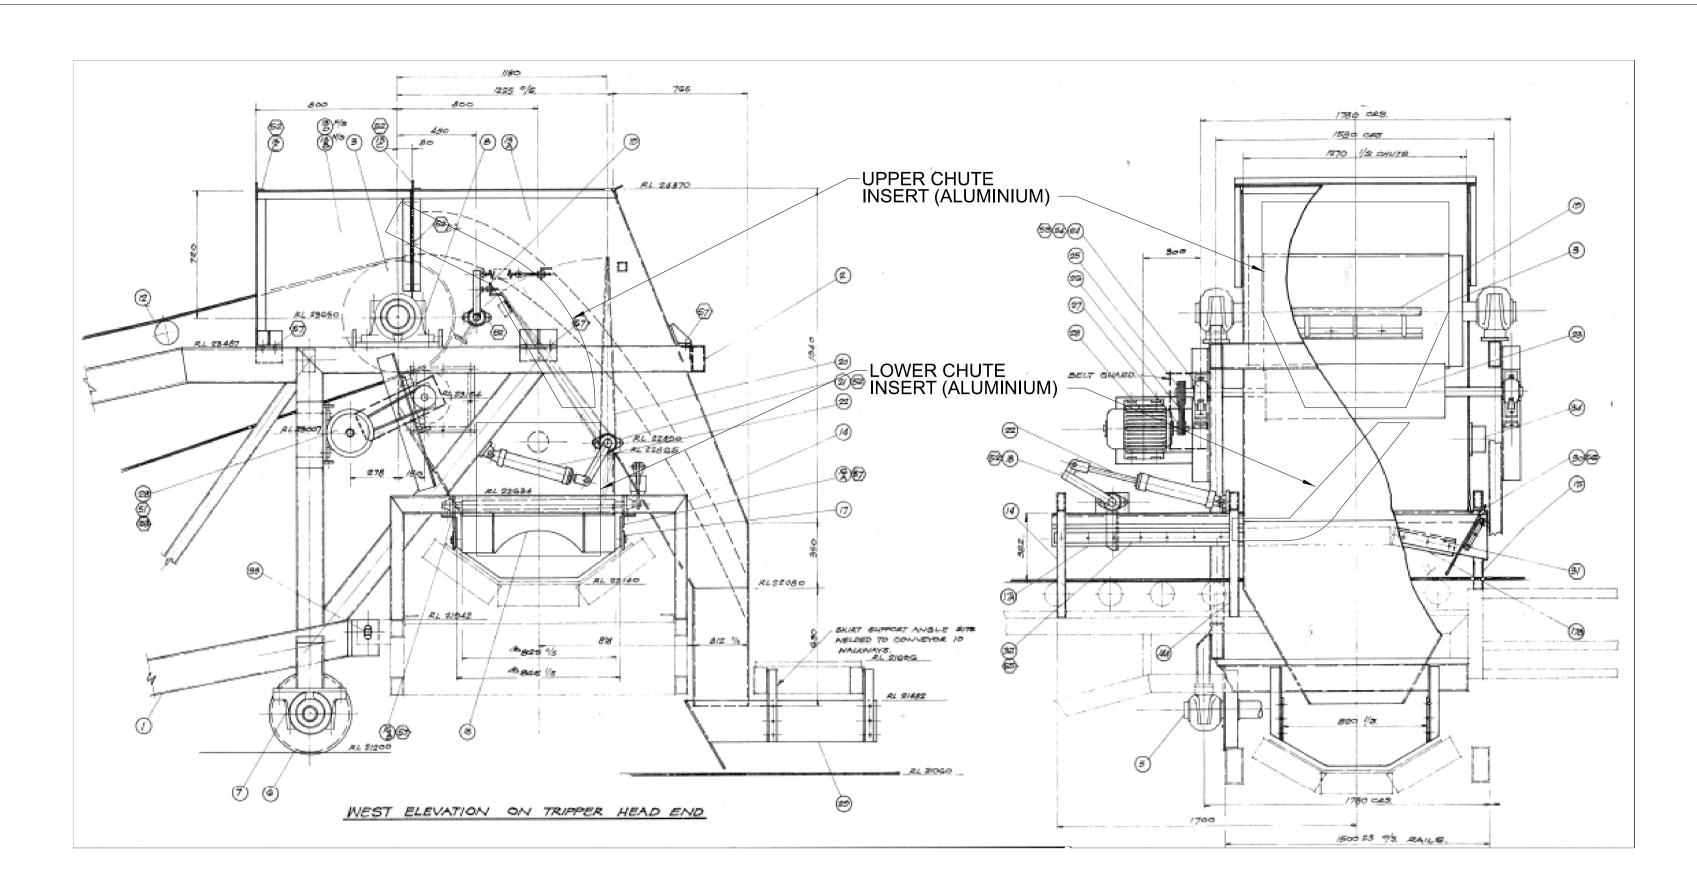

C7/C10 (TRIPPER) TRANSFER

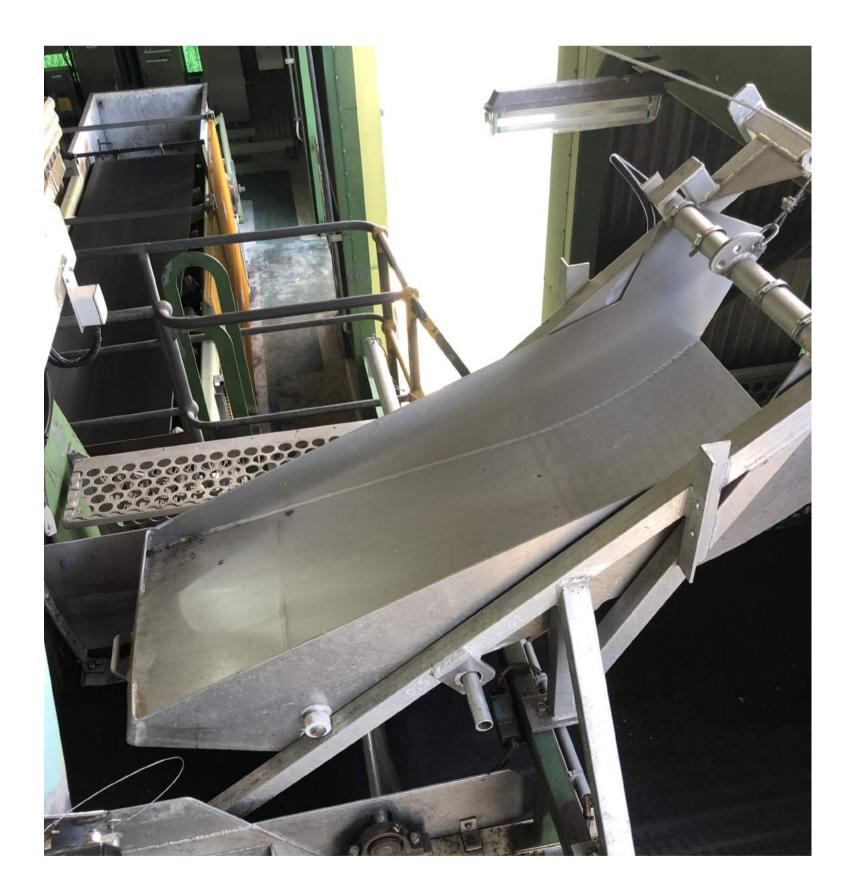

LOWER CHUTE INSERT

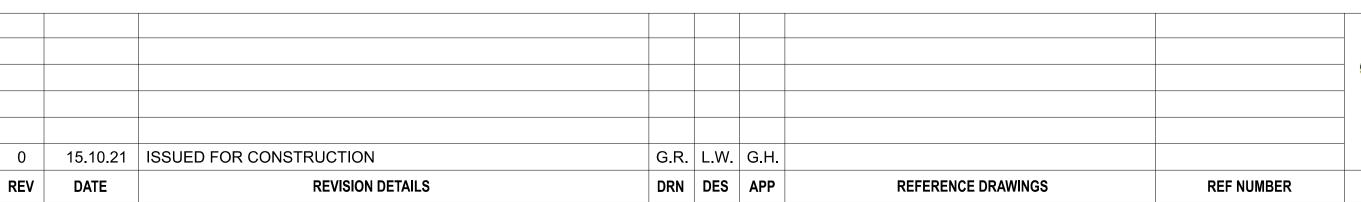





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DO NOT SCALE FROM DRAWING





UPPER CHUTE INSERT

SCOPE:

- REMOVE INSERTS TO WORKSHOP
 DETAIL MEASURE AND PRODUCE DRAWINGS
 LINE INSIDE WITH 15mm TIVAR-88 "BLACK" UHMW-PE USING THROUGH BOLT ATTACHMENT
 RETURN TO SITE AND RE-INSTALL




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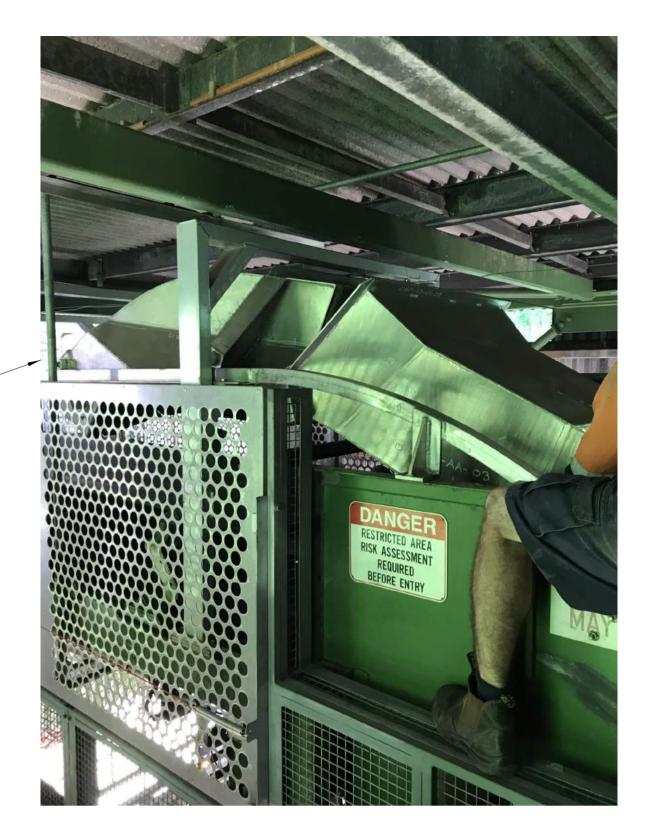
PORT OF BUNDABERG COMMON USER INFRASTRUCTURE CONVEYOR C7/C10 TRANSFER **CHUTE INSERT MODIFICATIONS**

DRAWING No. 255250-M-075

NTS

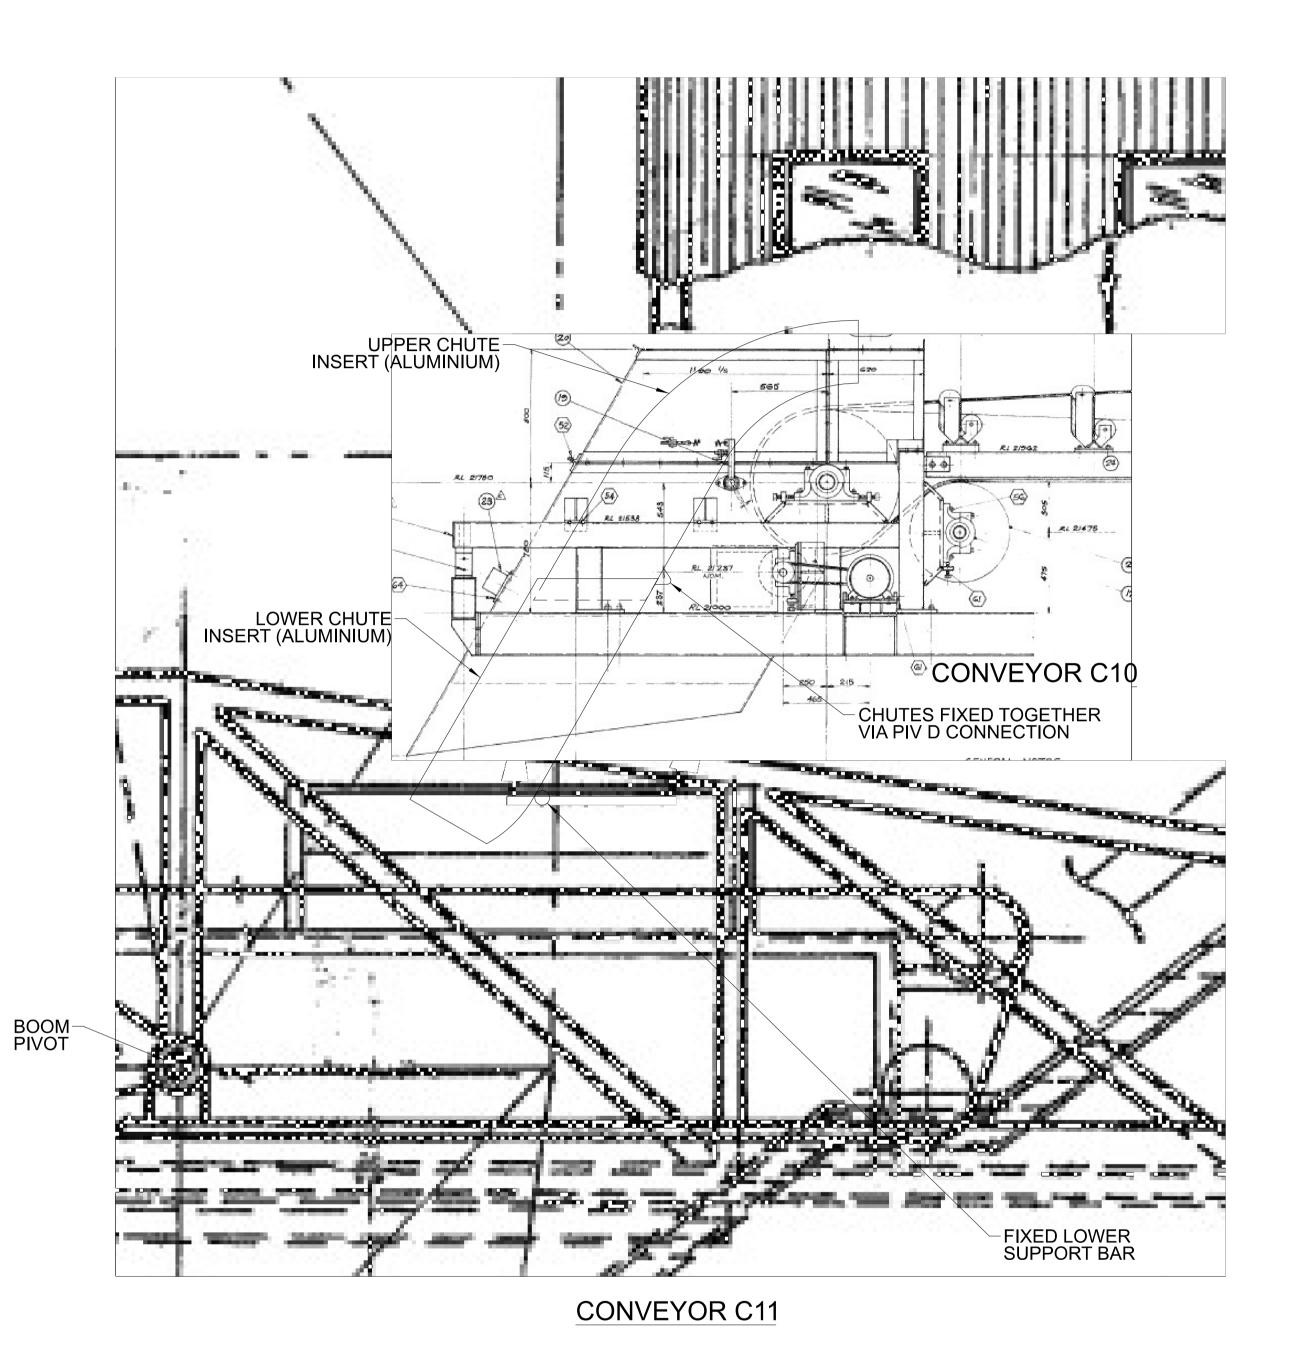

WINCH ATTACHMENT CROSS-BEAM TO BE BOLTED TO STEEL SHIPLOADER STRUCTURE FRAME









PROVIDE 2x NEW 750Kg-PULL MANUAL WINCHES AND ROPES



SCOPE:

- REMOVE INSERTS TO WORKSHOP
 DETAIL MEASURE AND PRODUCE DRAWINGS
 LINE INSIDE WITH 15mm TIVAR-88 "BLACK" UHMW-PE USING THROUGH BOLT ATTACHMENT
 RETURN TO SITE AND RE-INSTALL



REV	DATE	REVISION DETAILS	DRN	DES	APP	REFERENCE DRAWINGS	REF NUMBER
0	15.10.21	ISSUED FOR CONSTRUCTION	G.R.	L.W.	G.H.		






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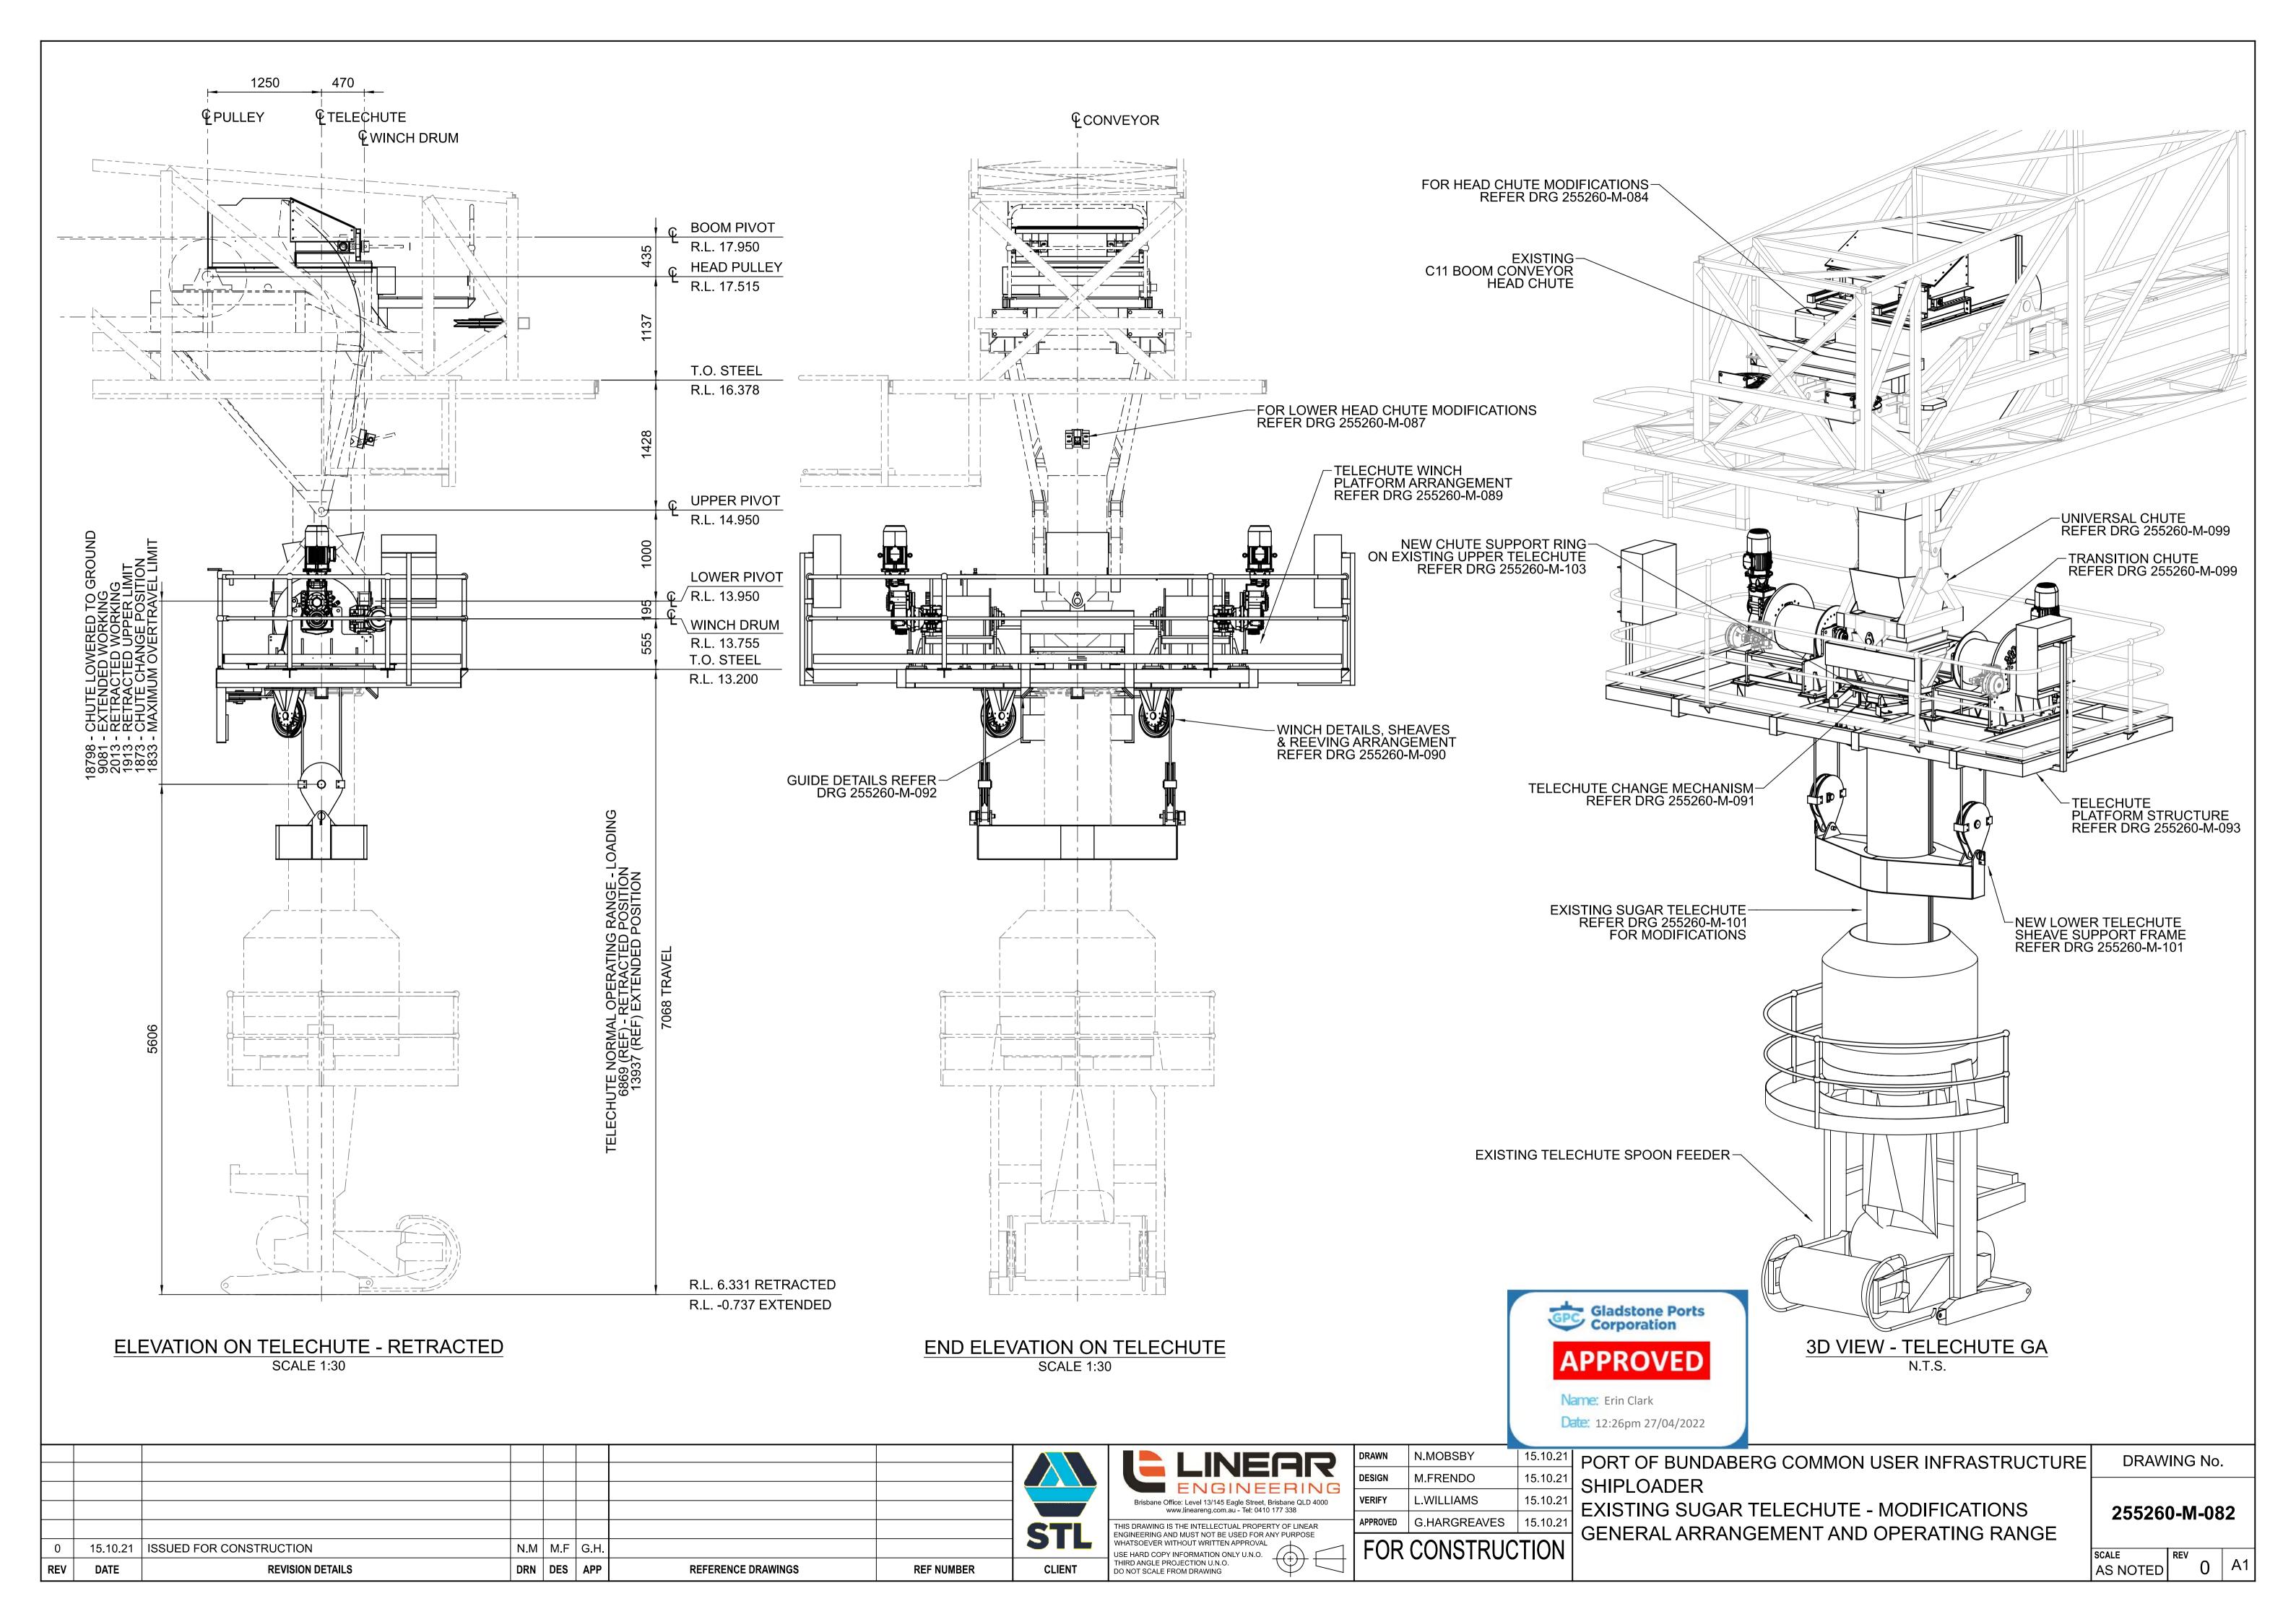
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VG	DESIGN	L.WILLIAMS	15.10.21
3	DRAWN	G.RUSSELL	15.10.21


PORT OF BUNDABERG COMMON USER INFRASTRUCTURE CONVEYOR C10/C11 TRANSFER CHUTE INSERT MODIFICATIONS


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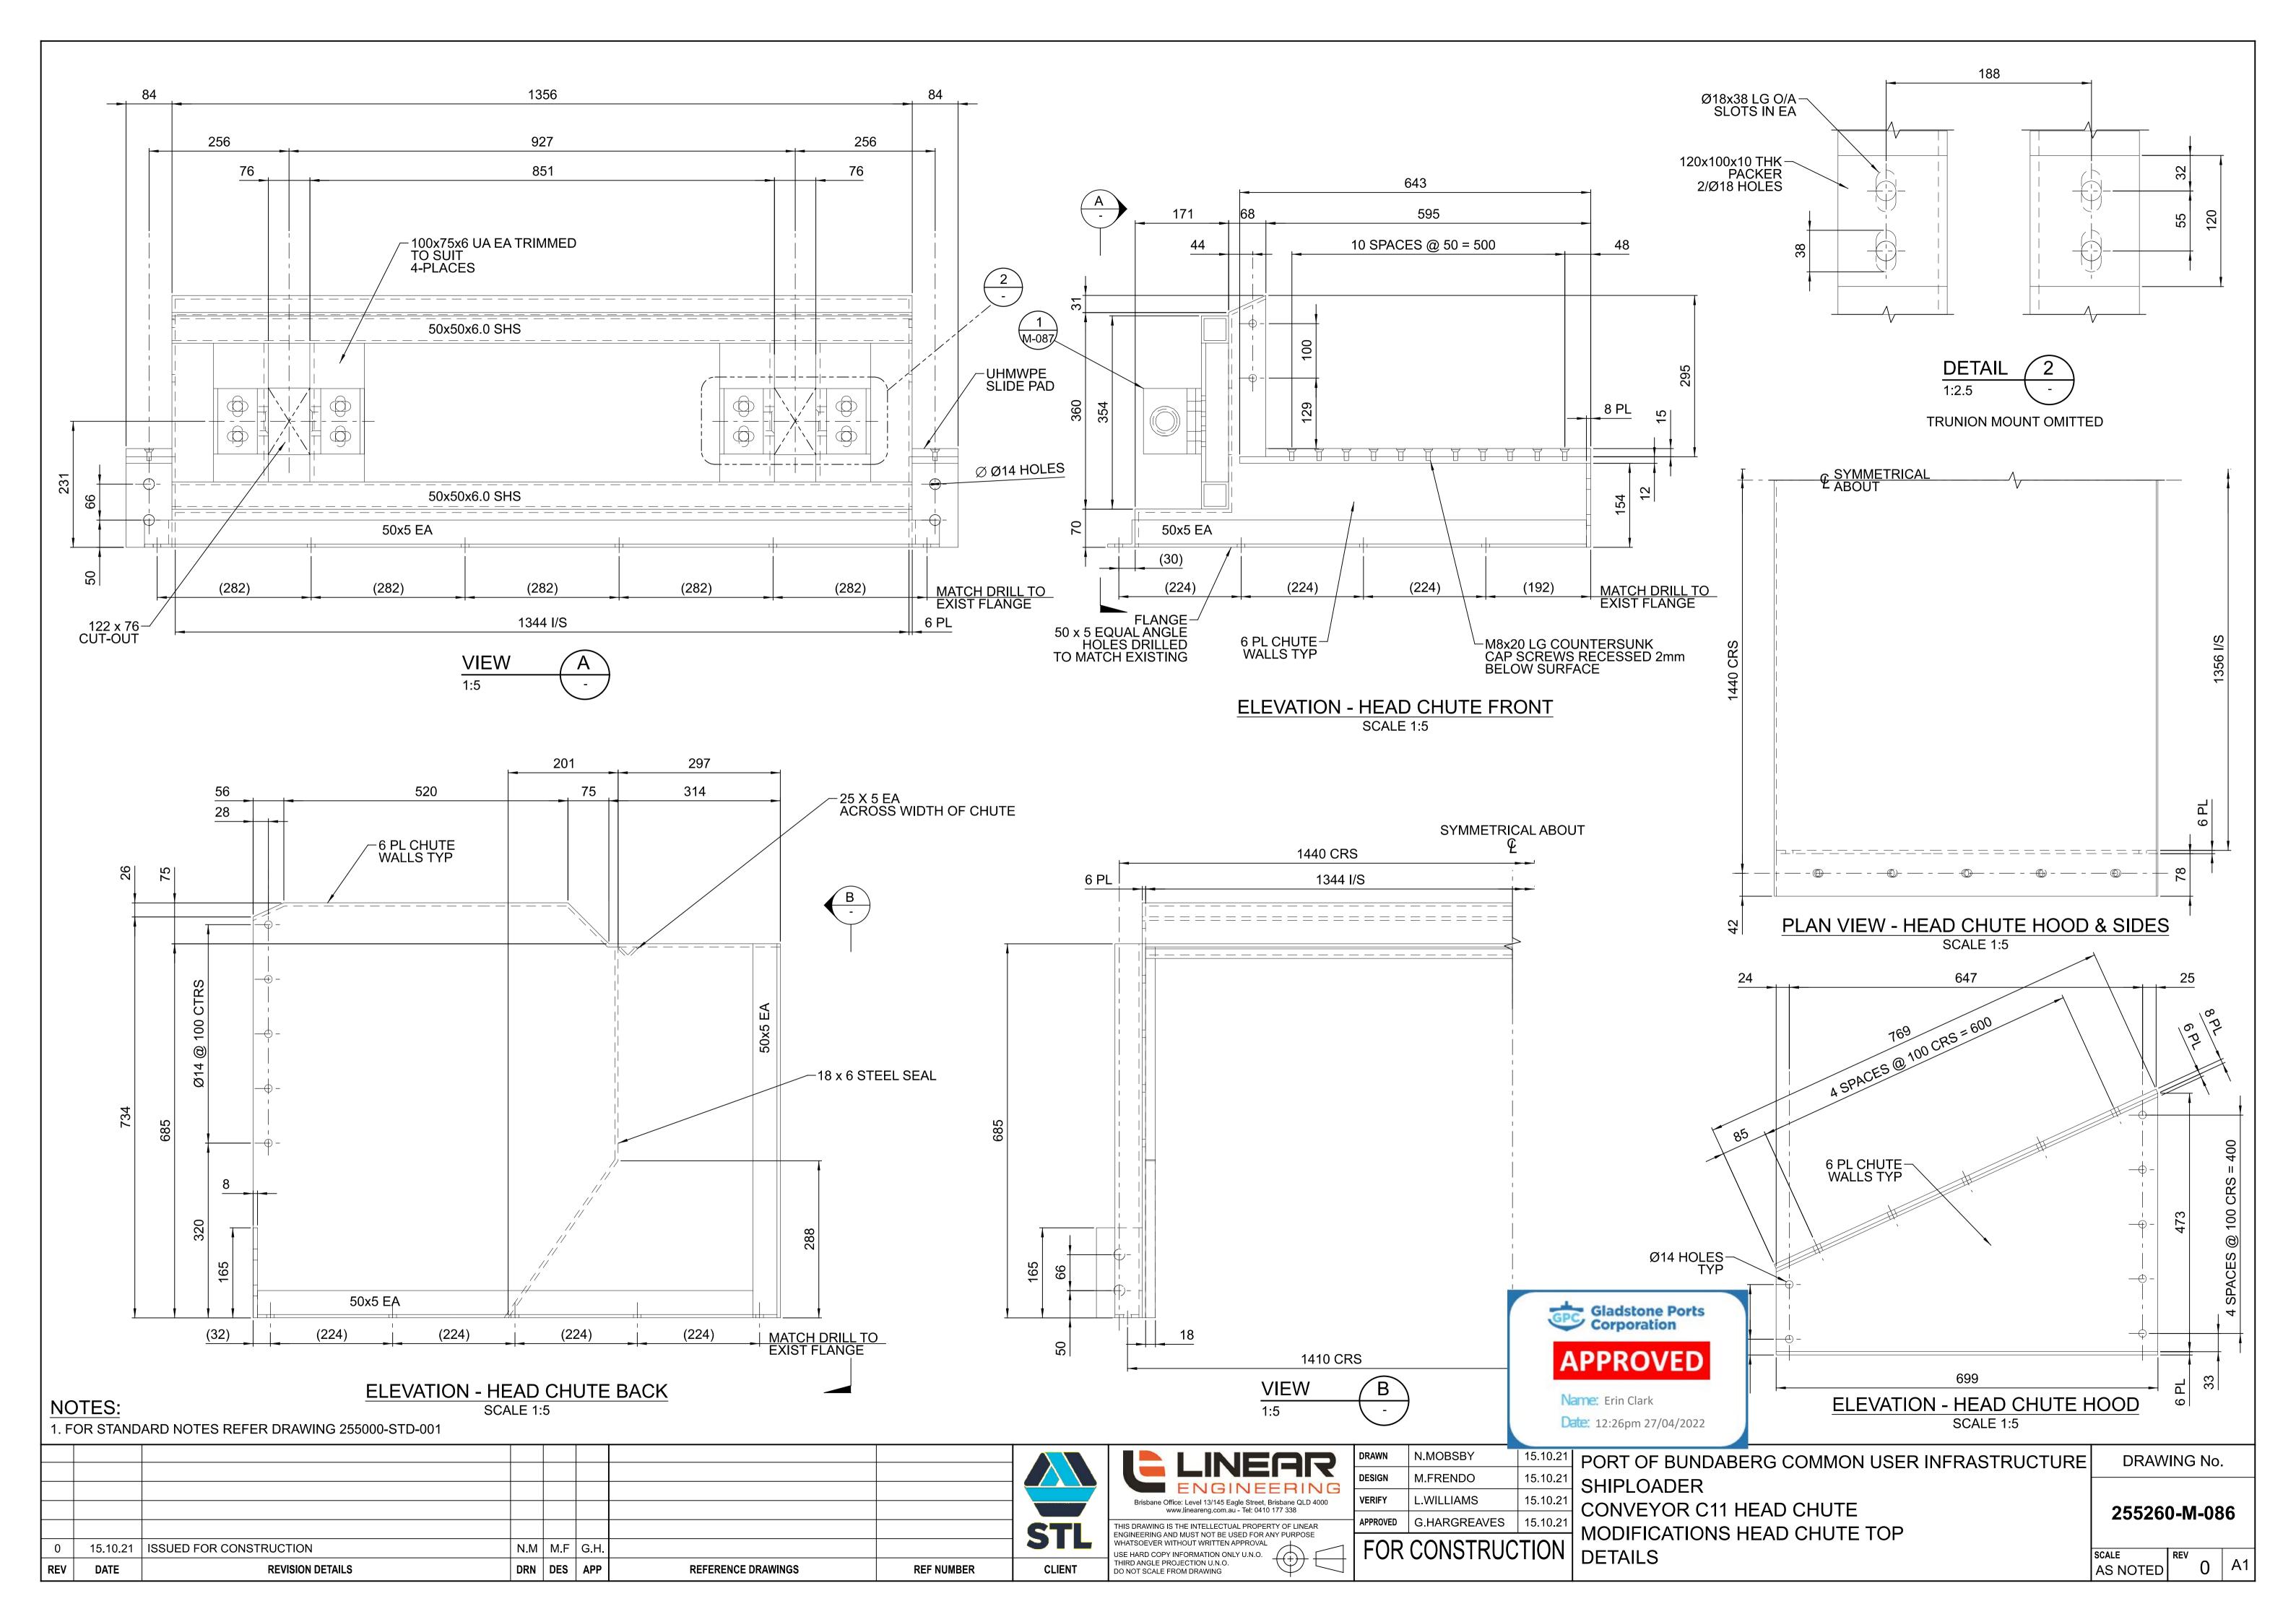
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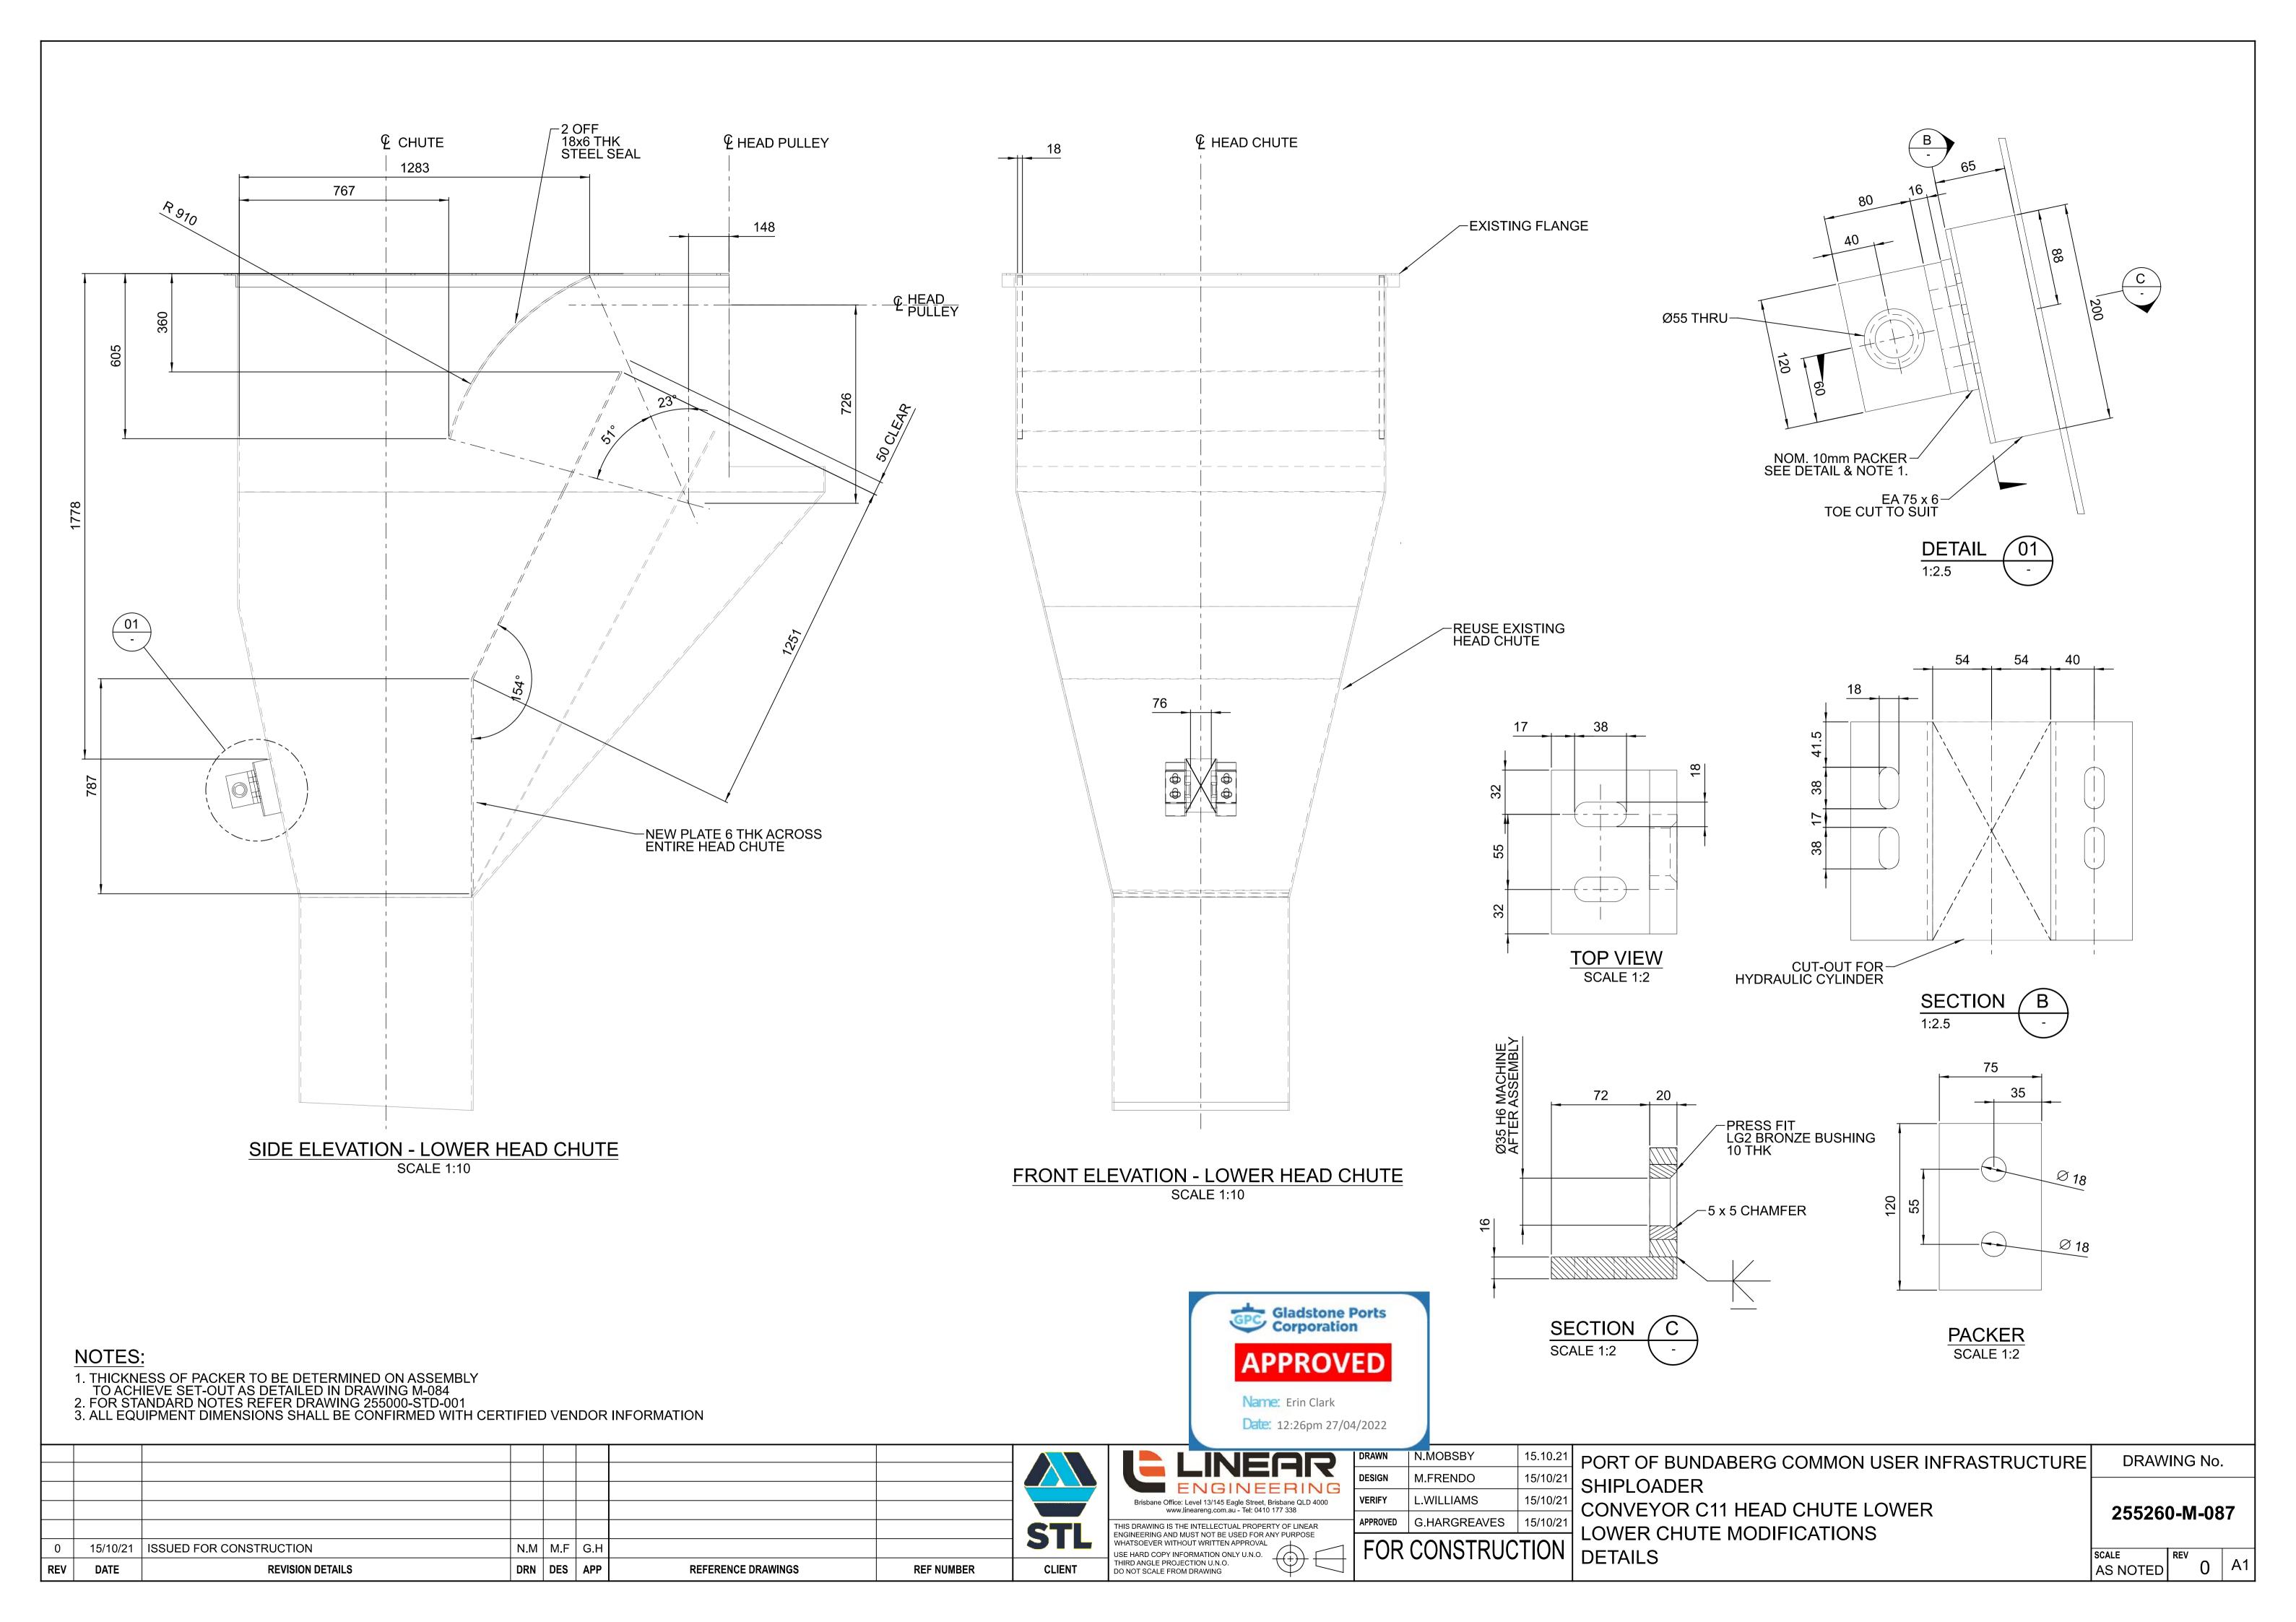








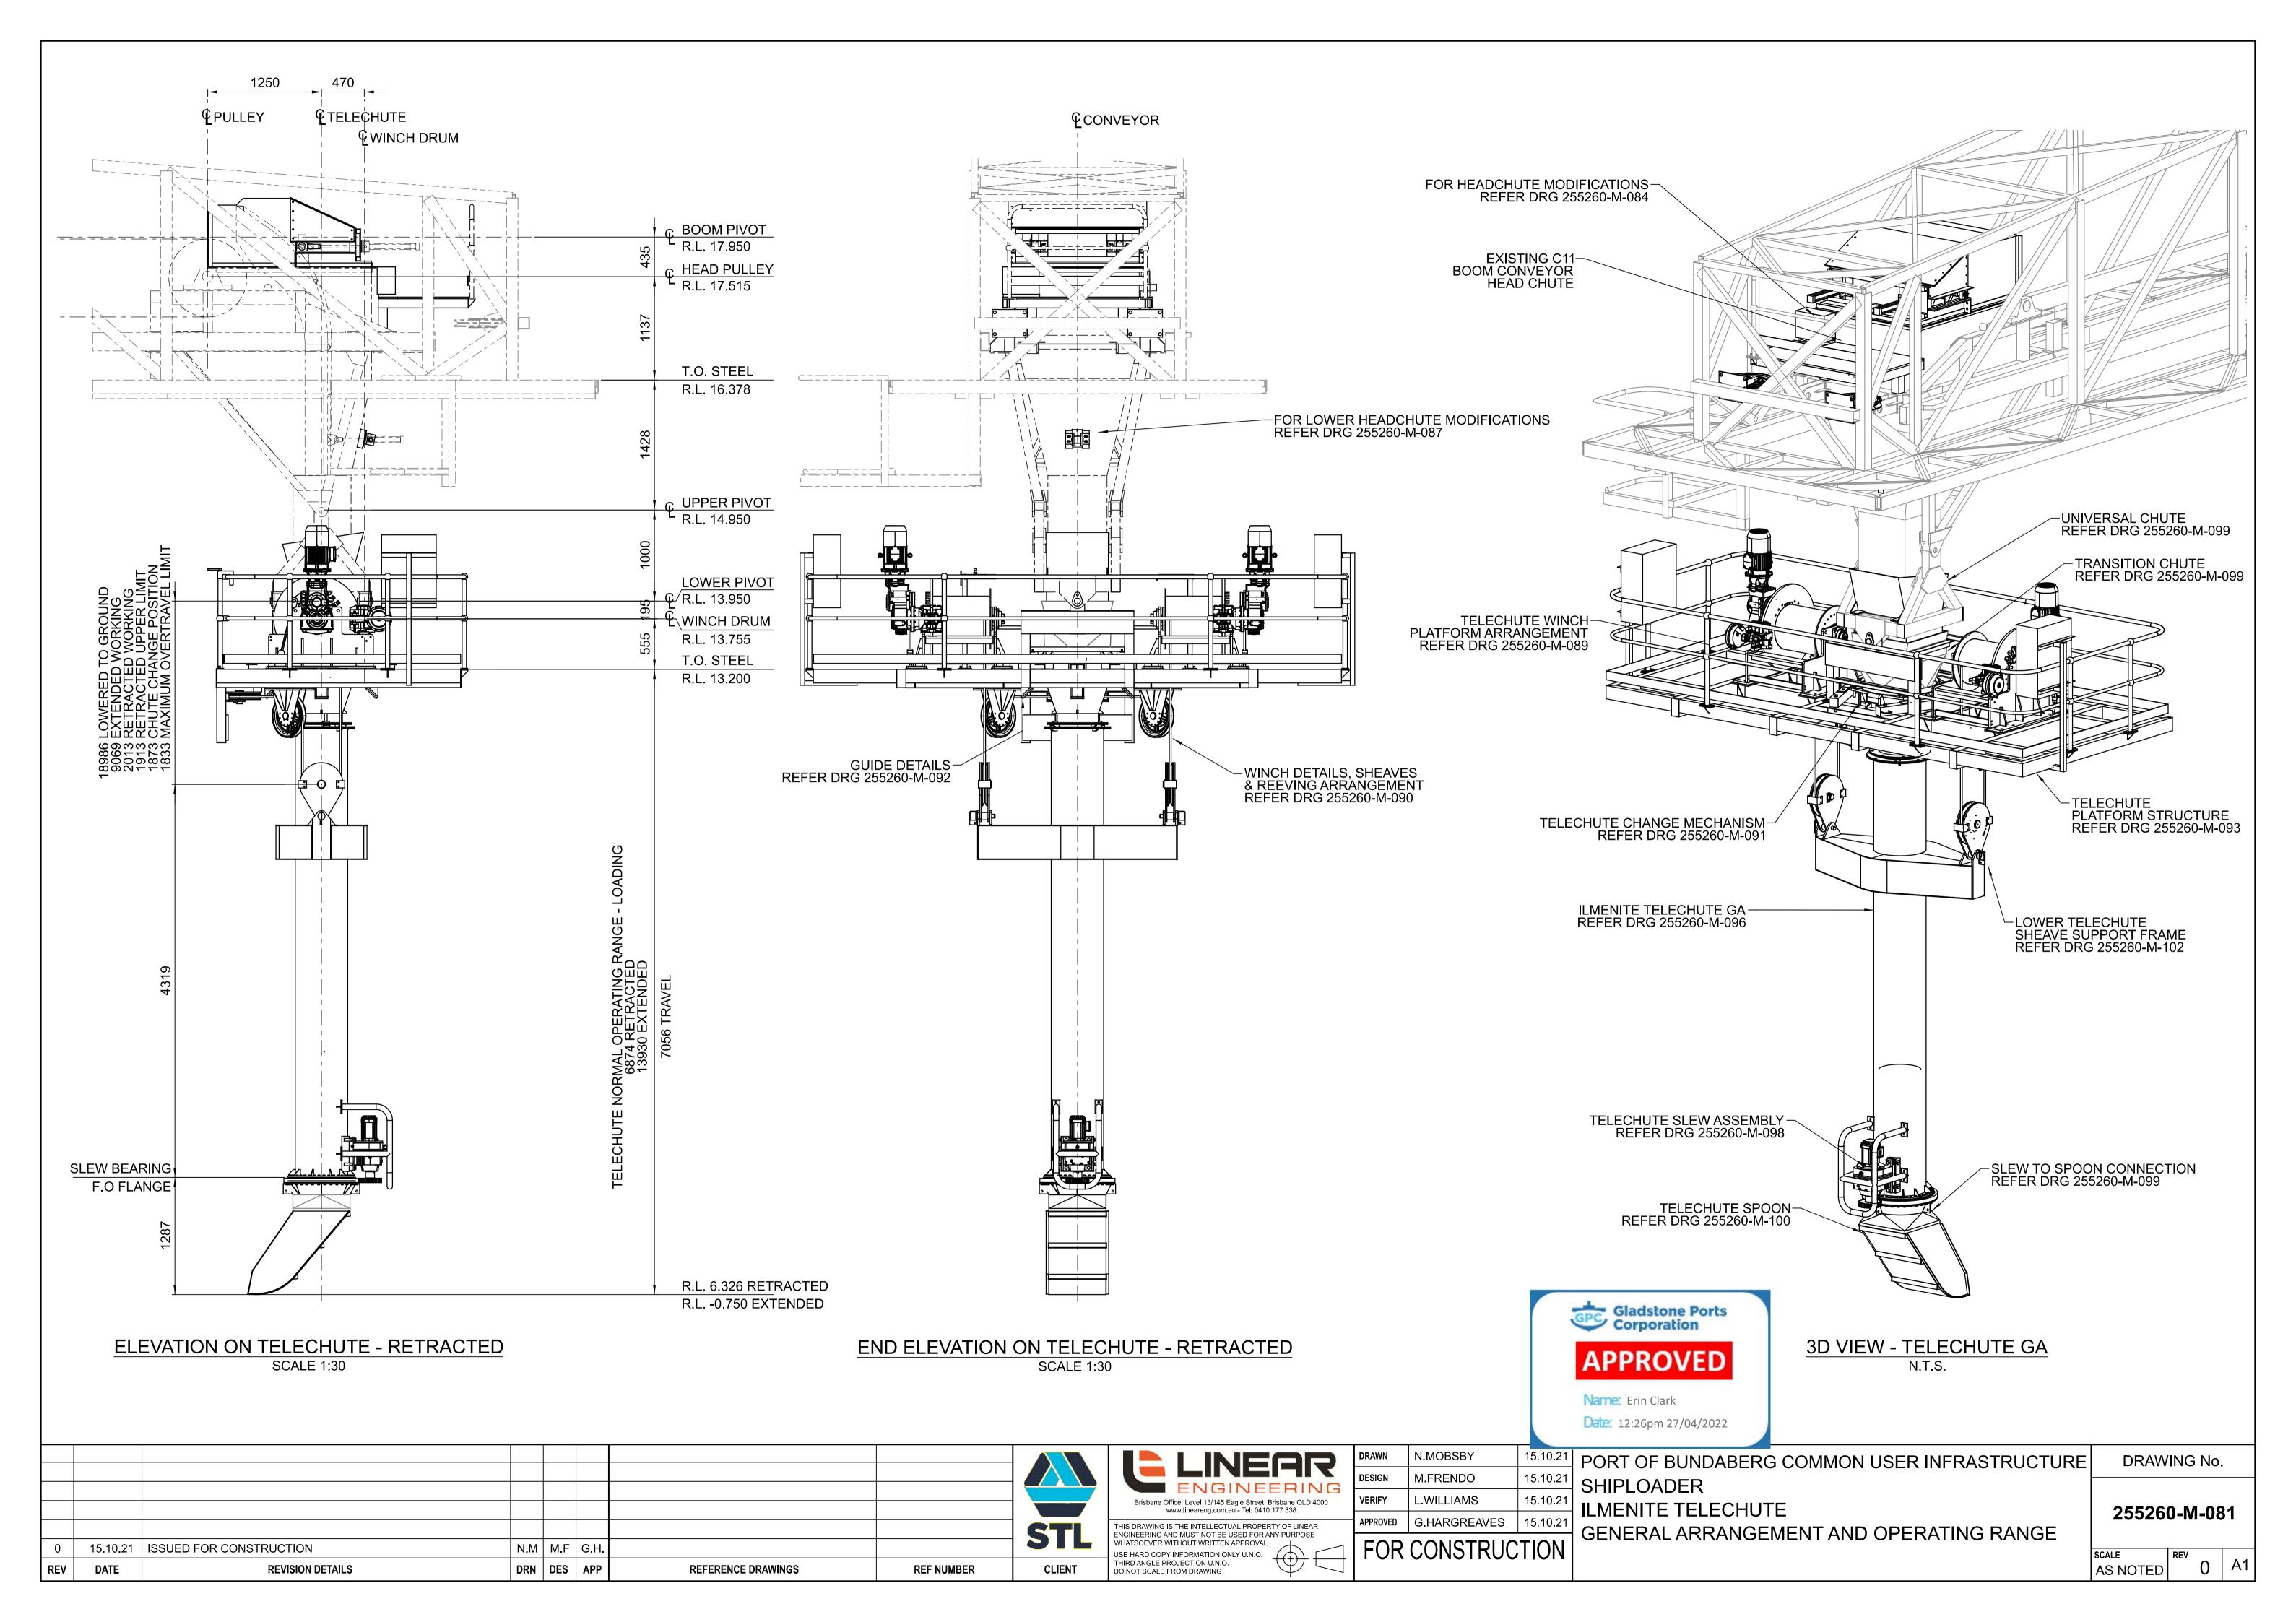


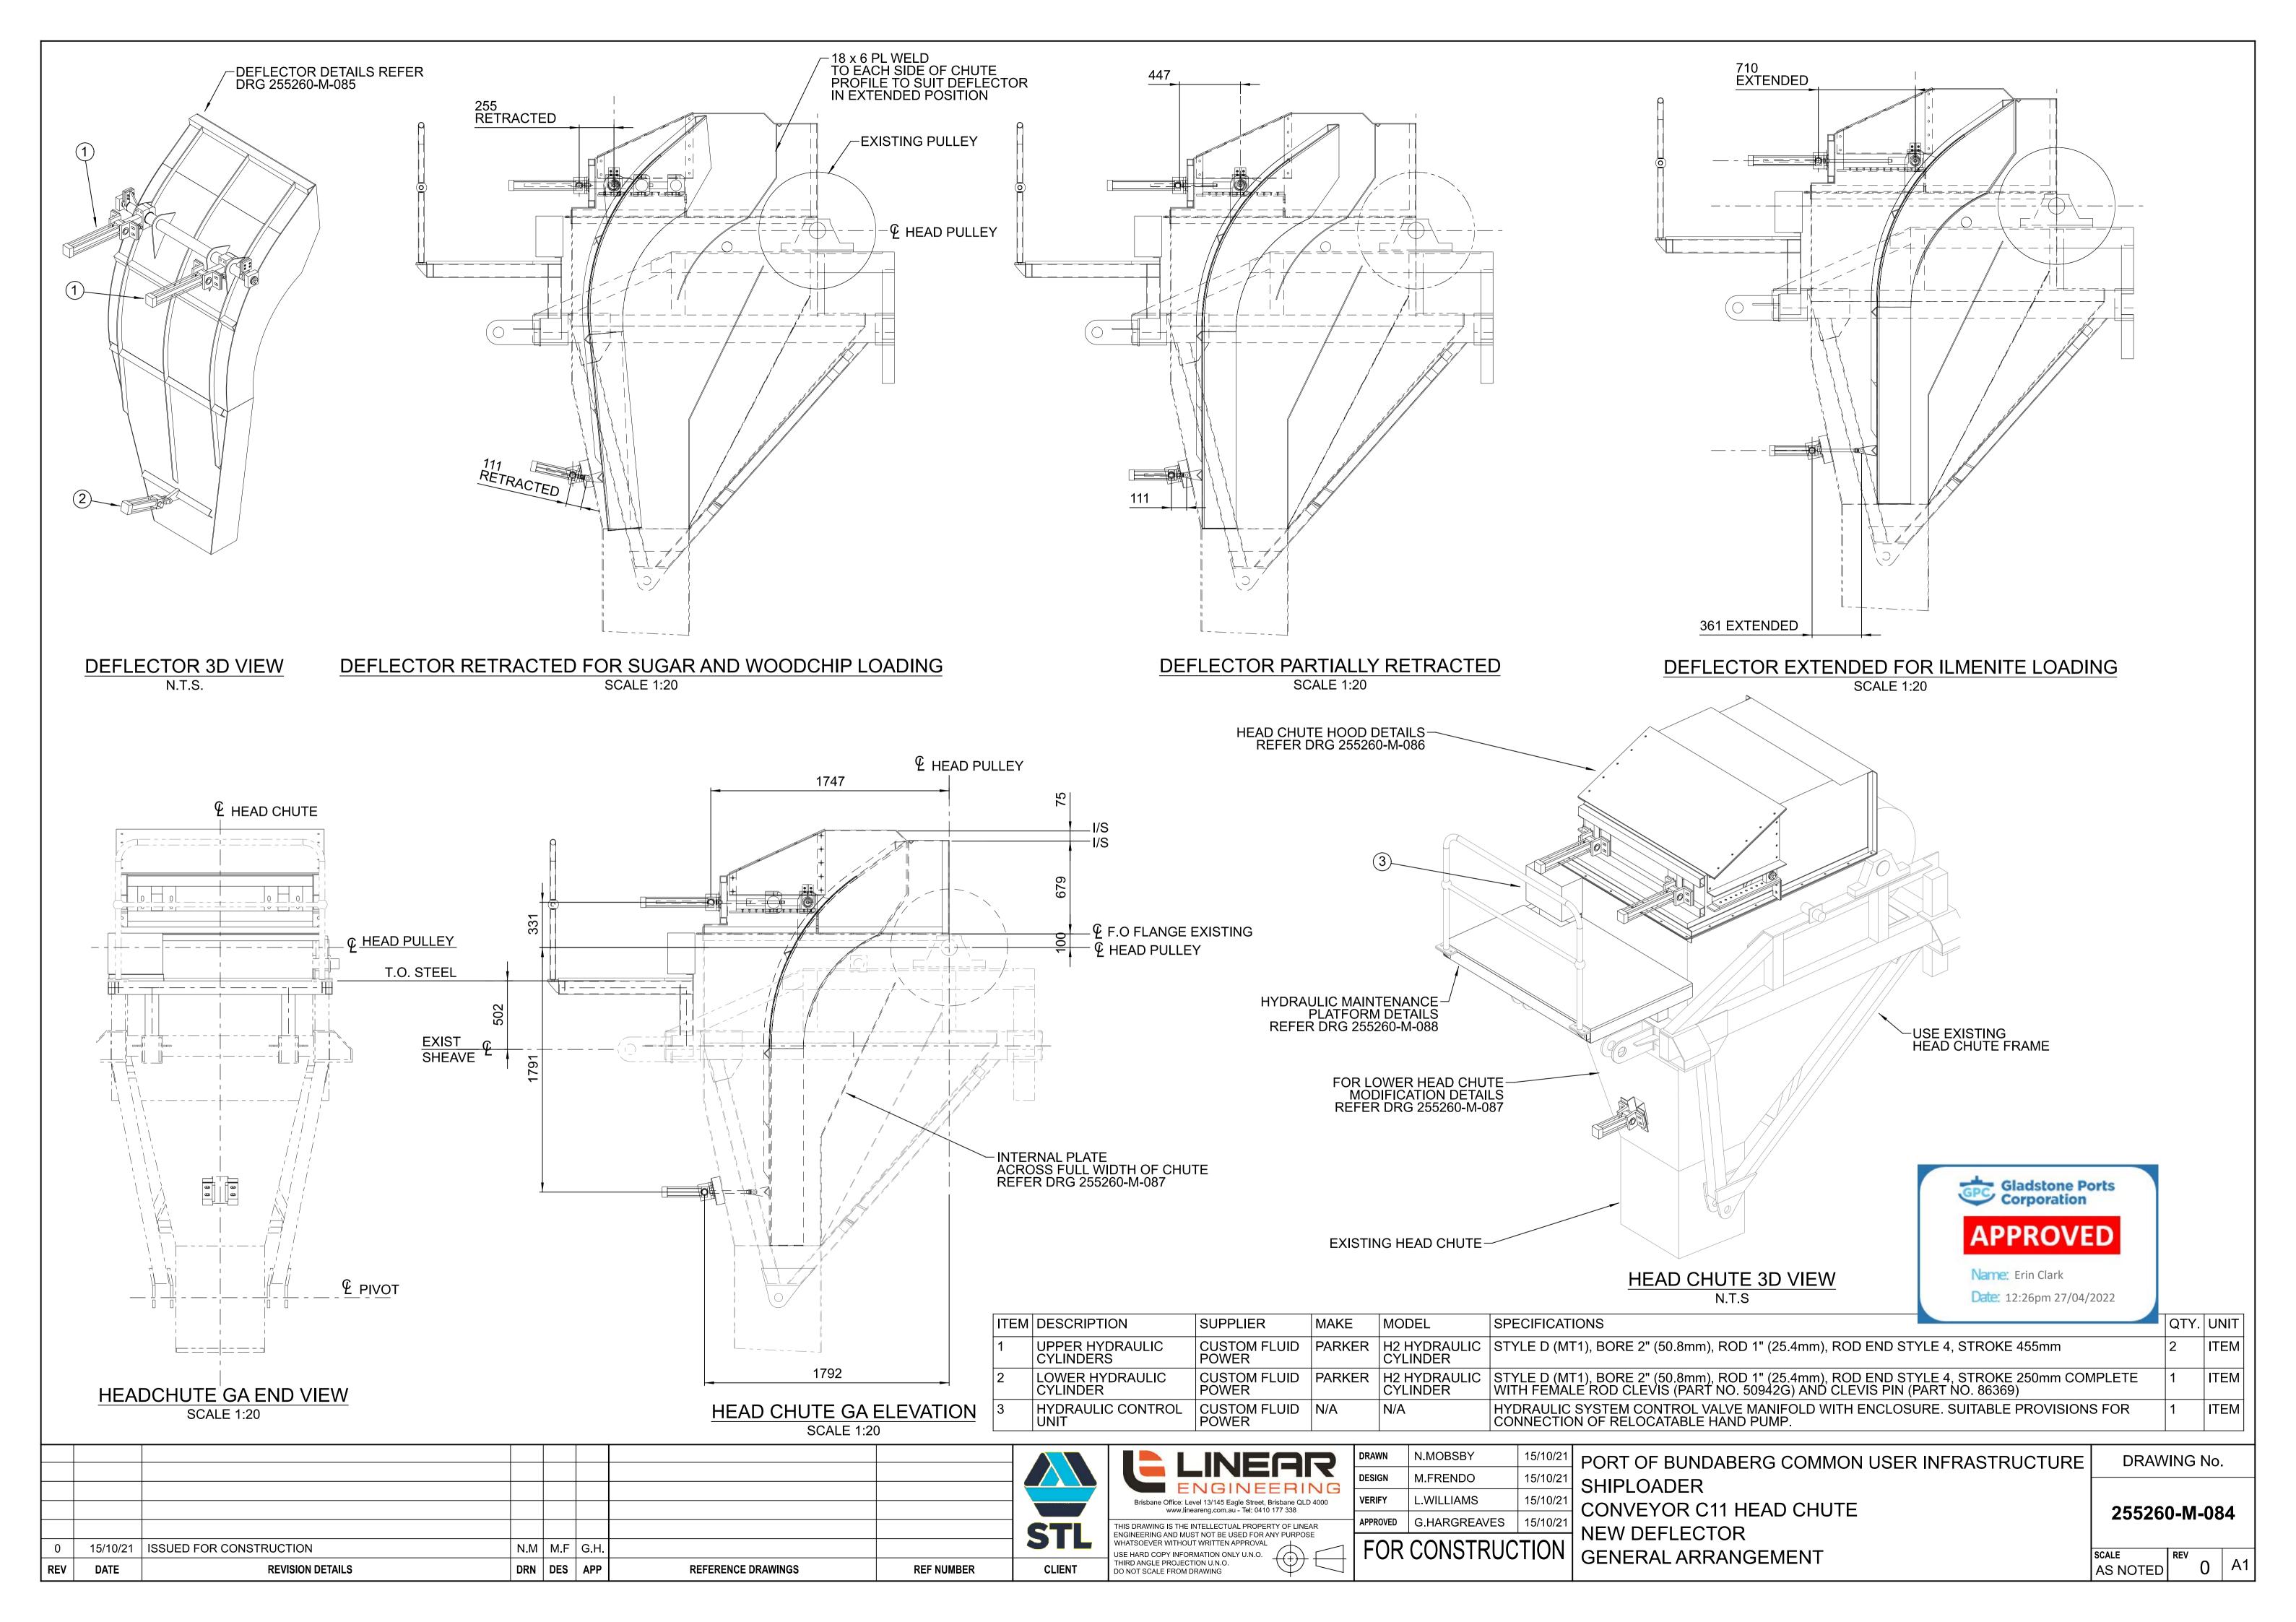


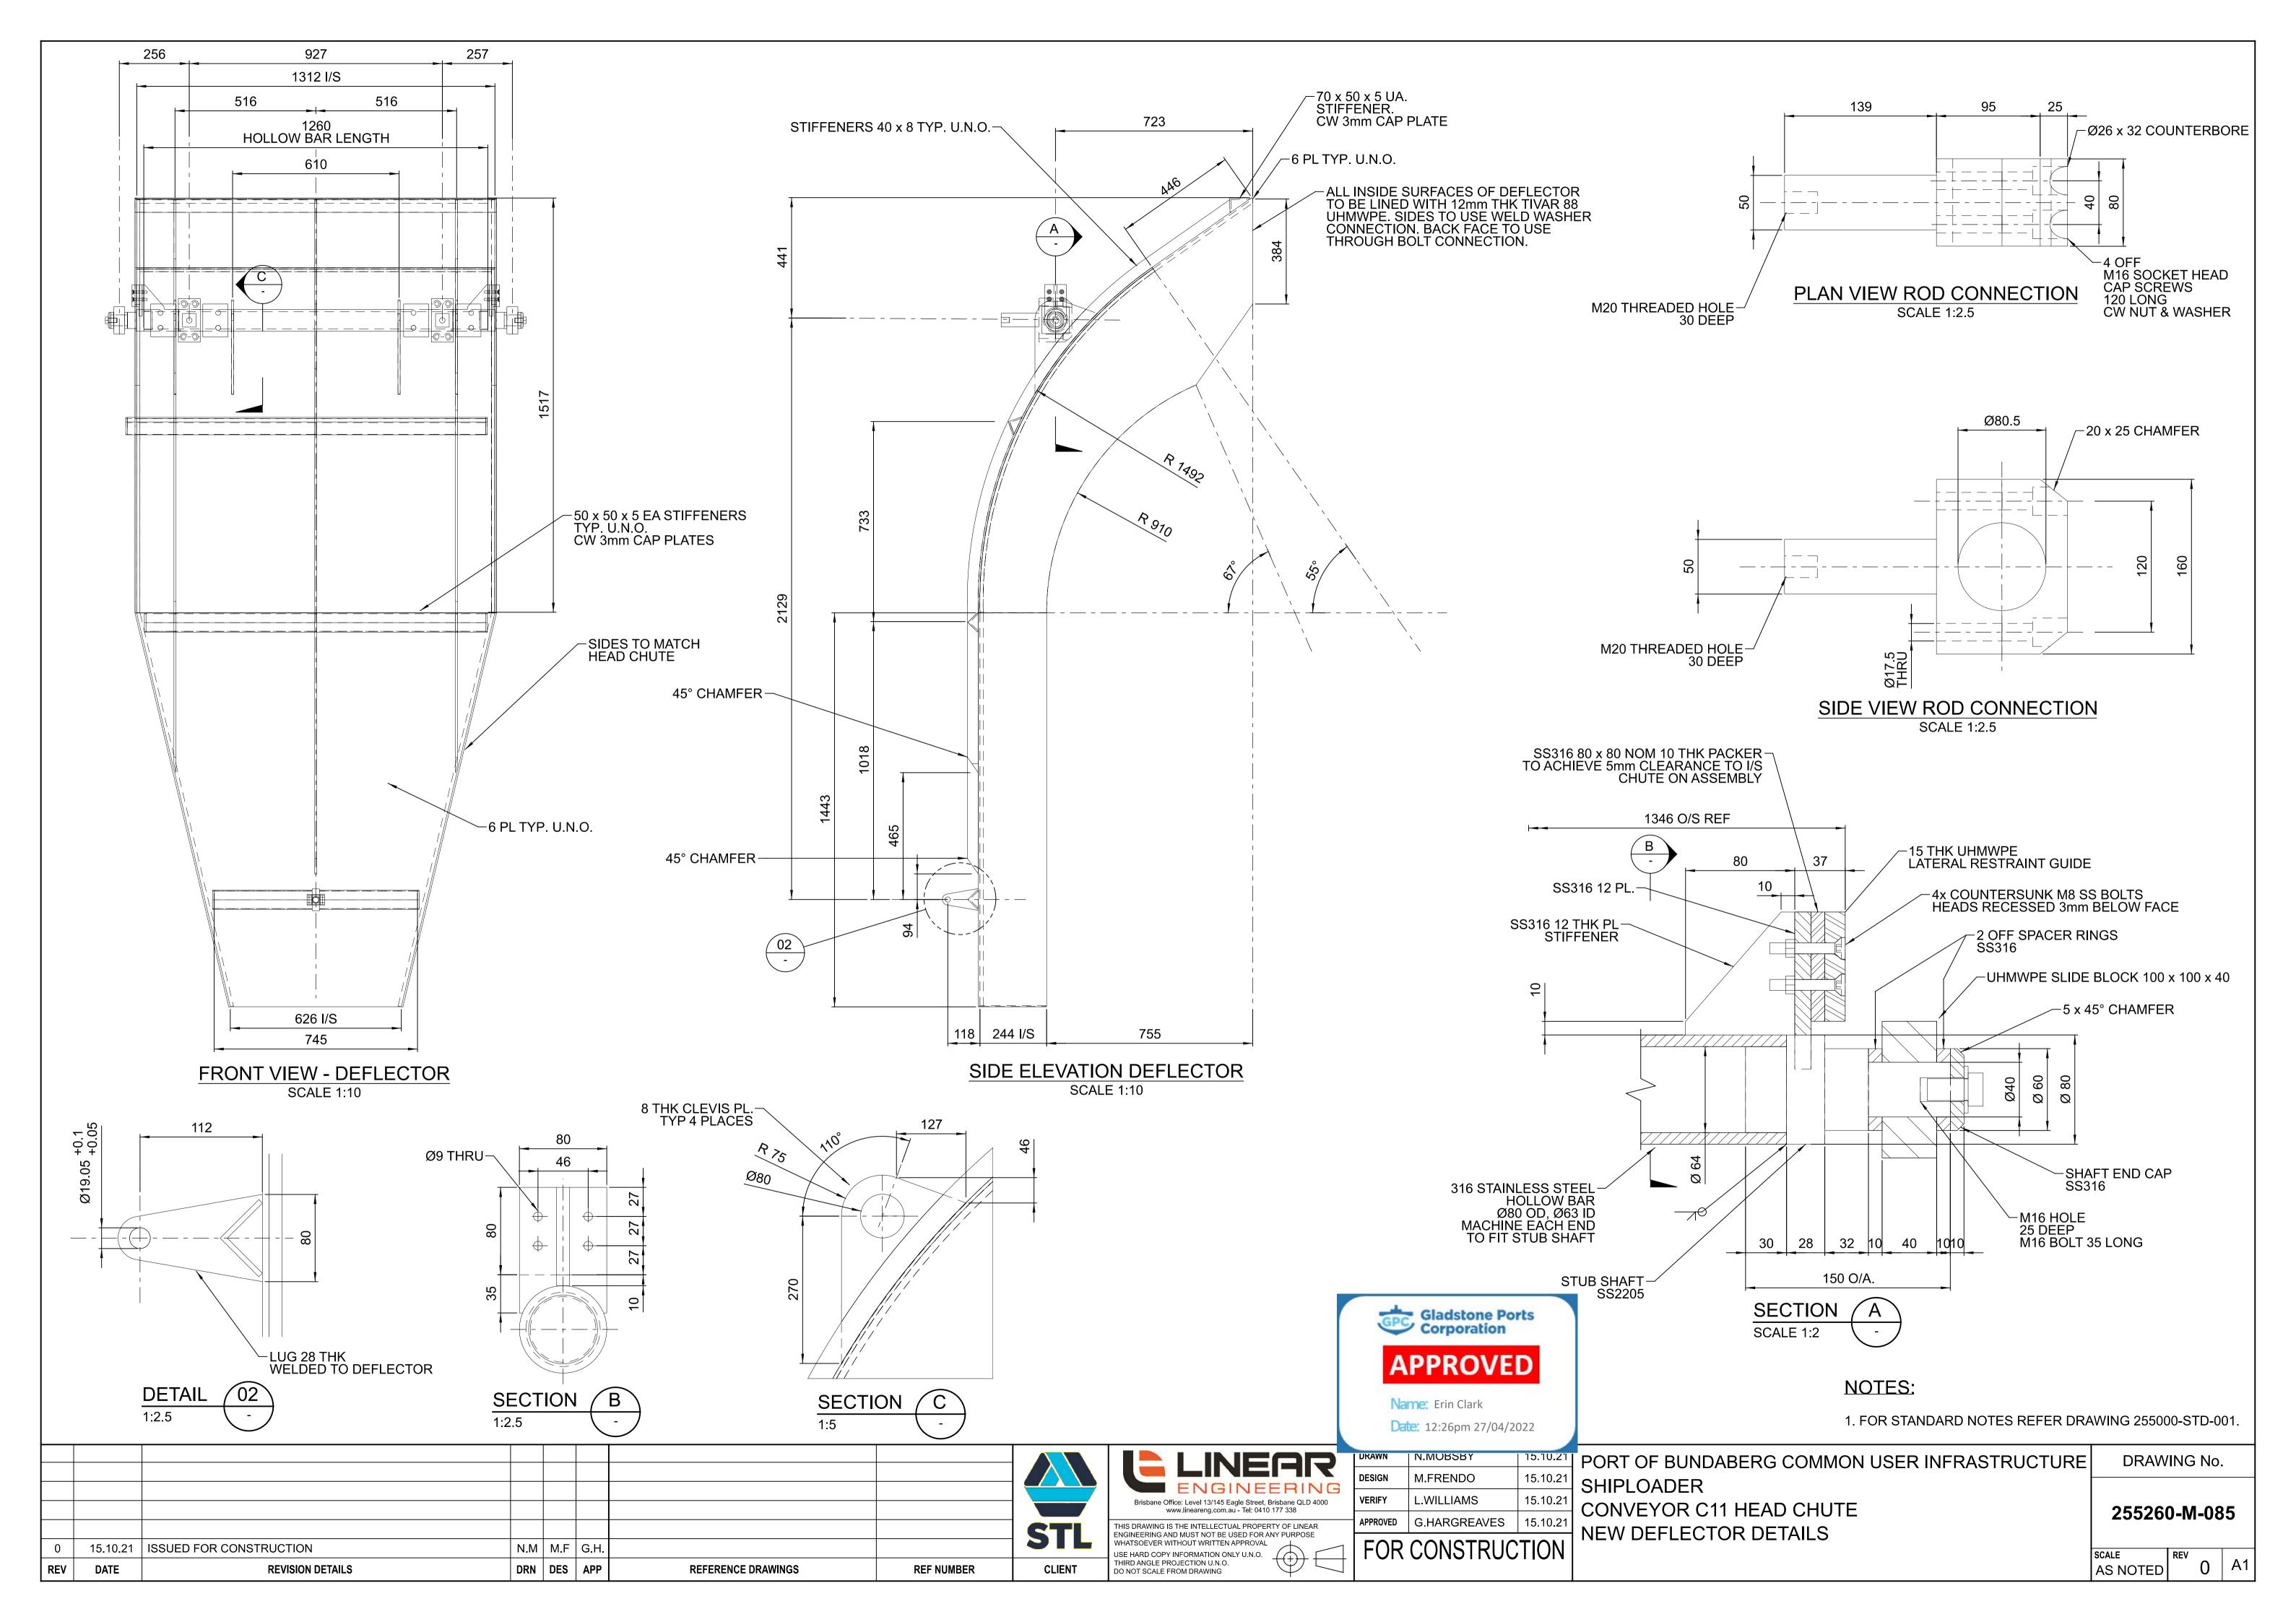


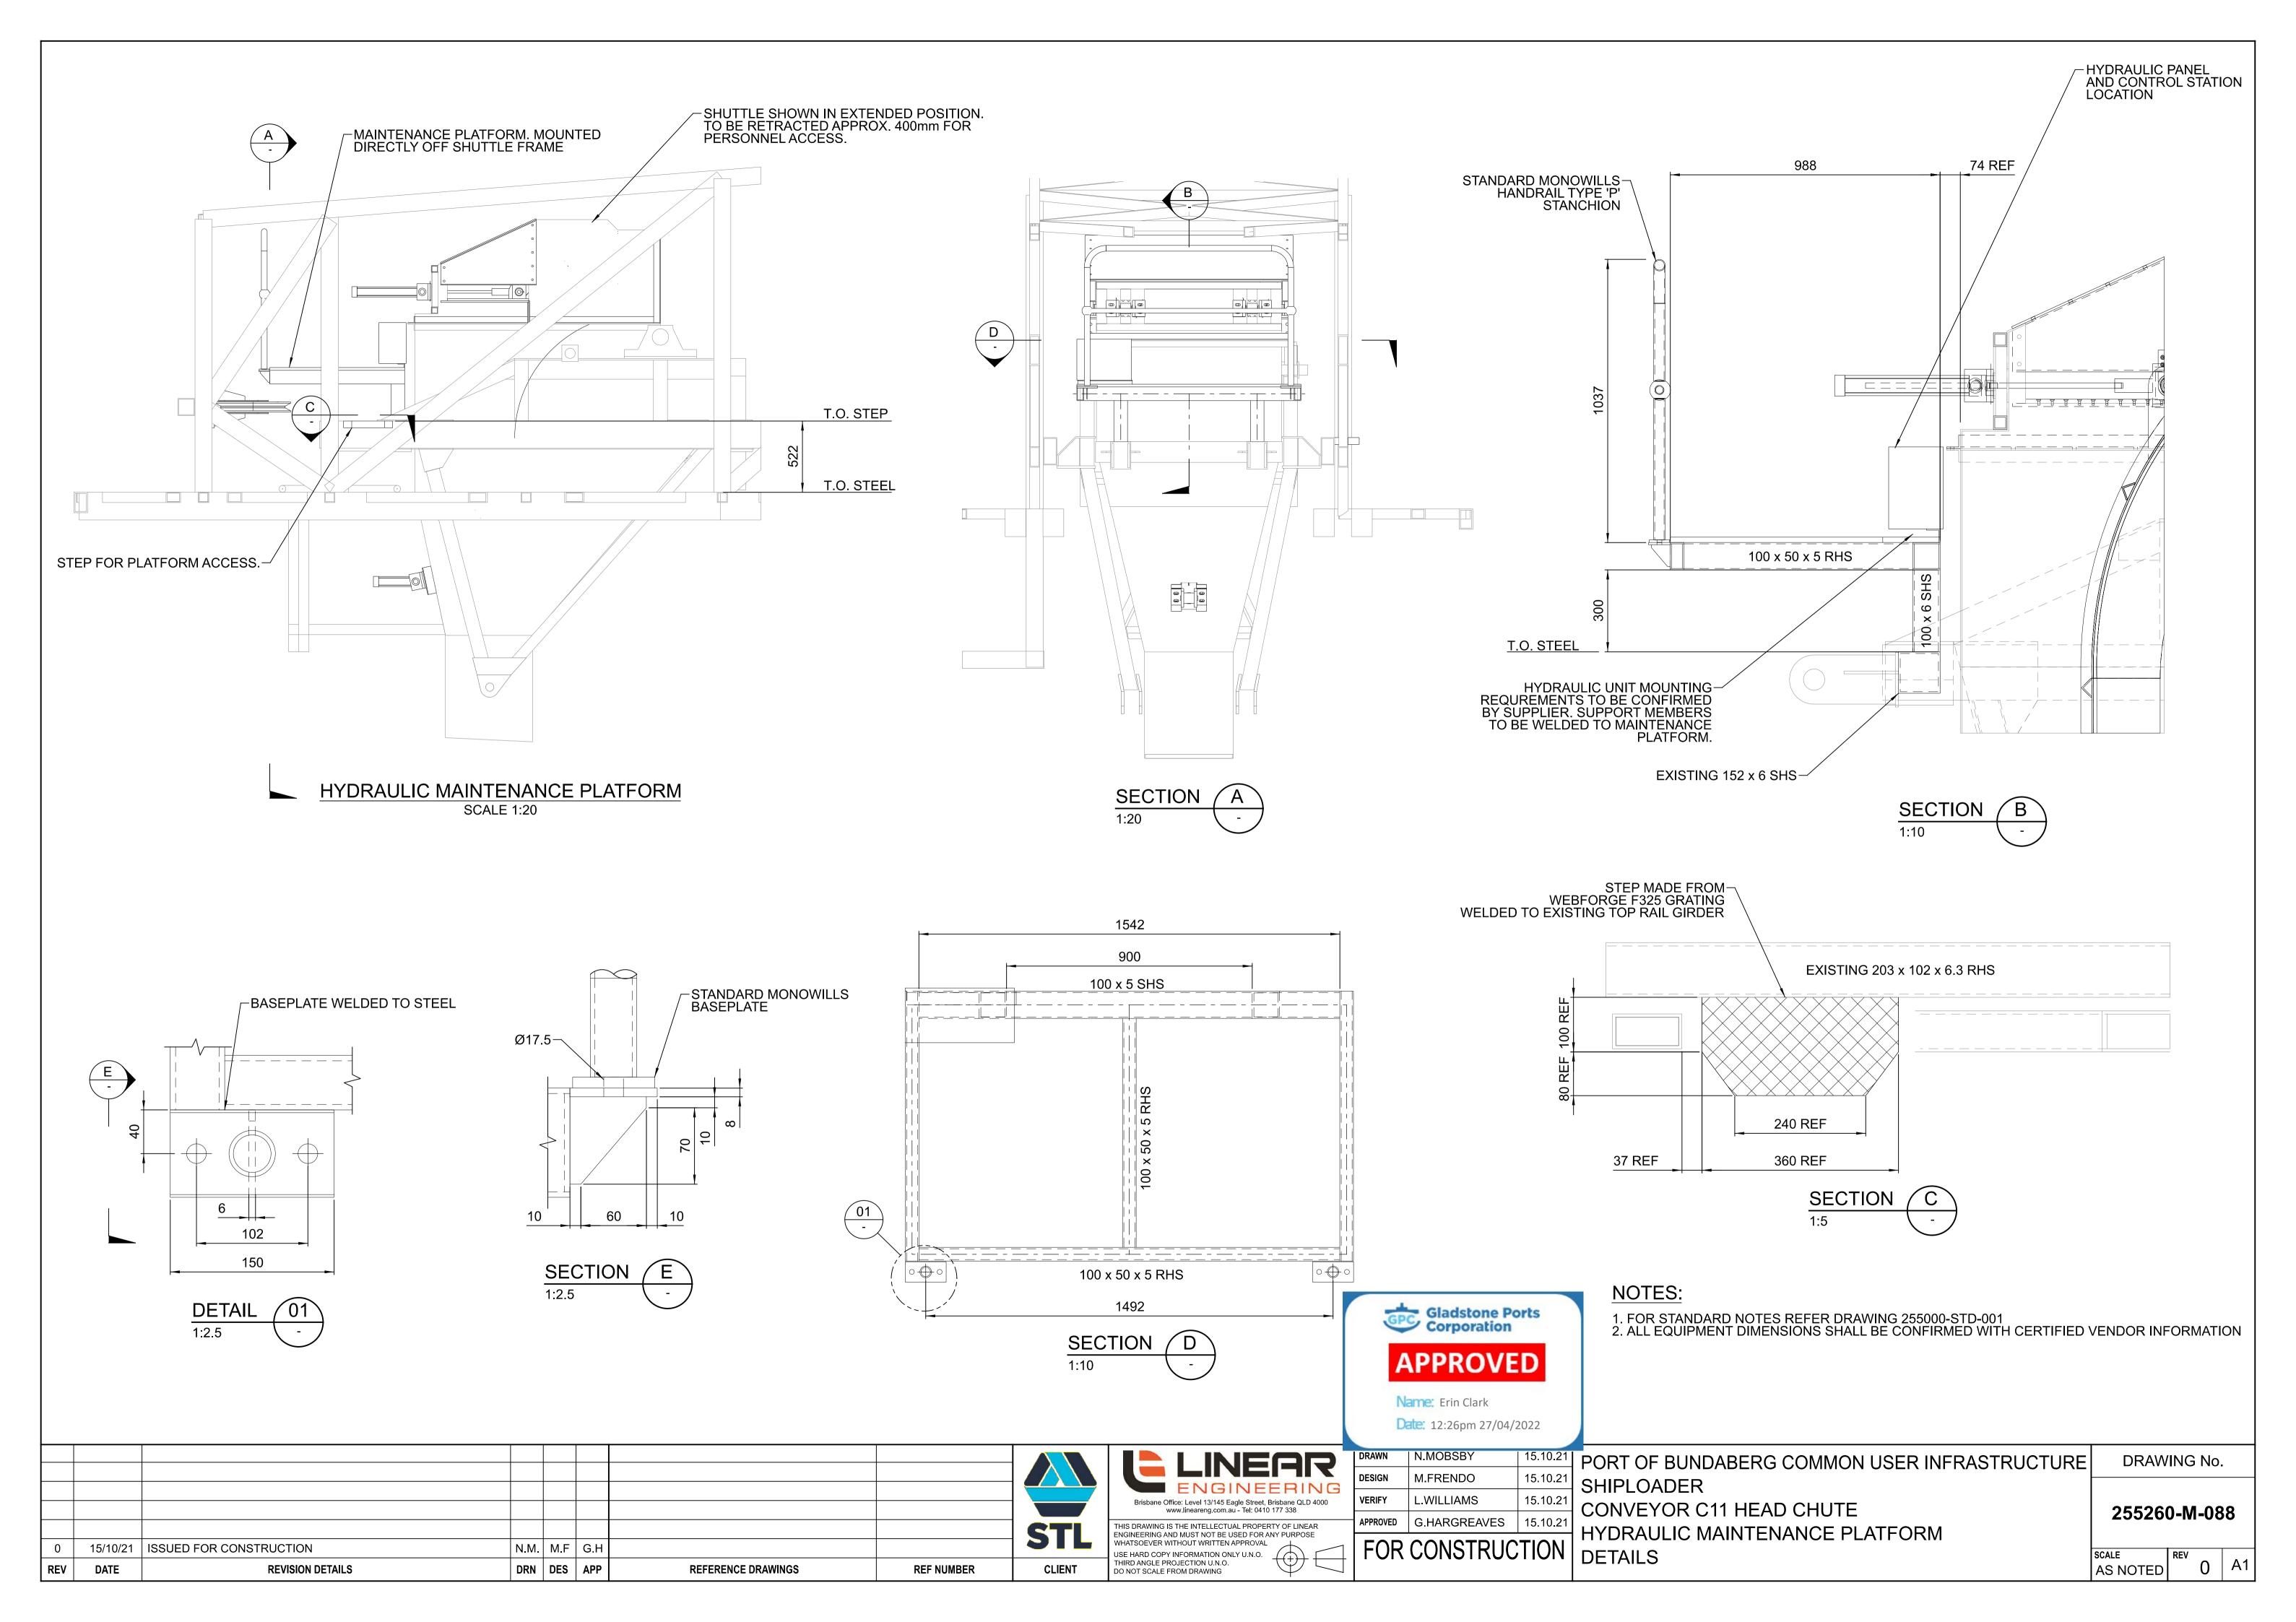


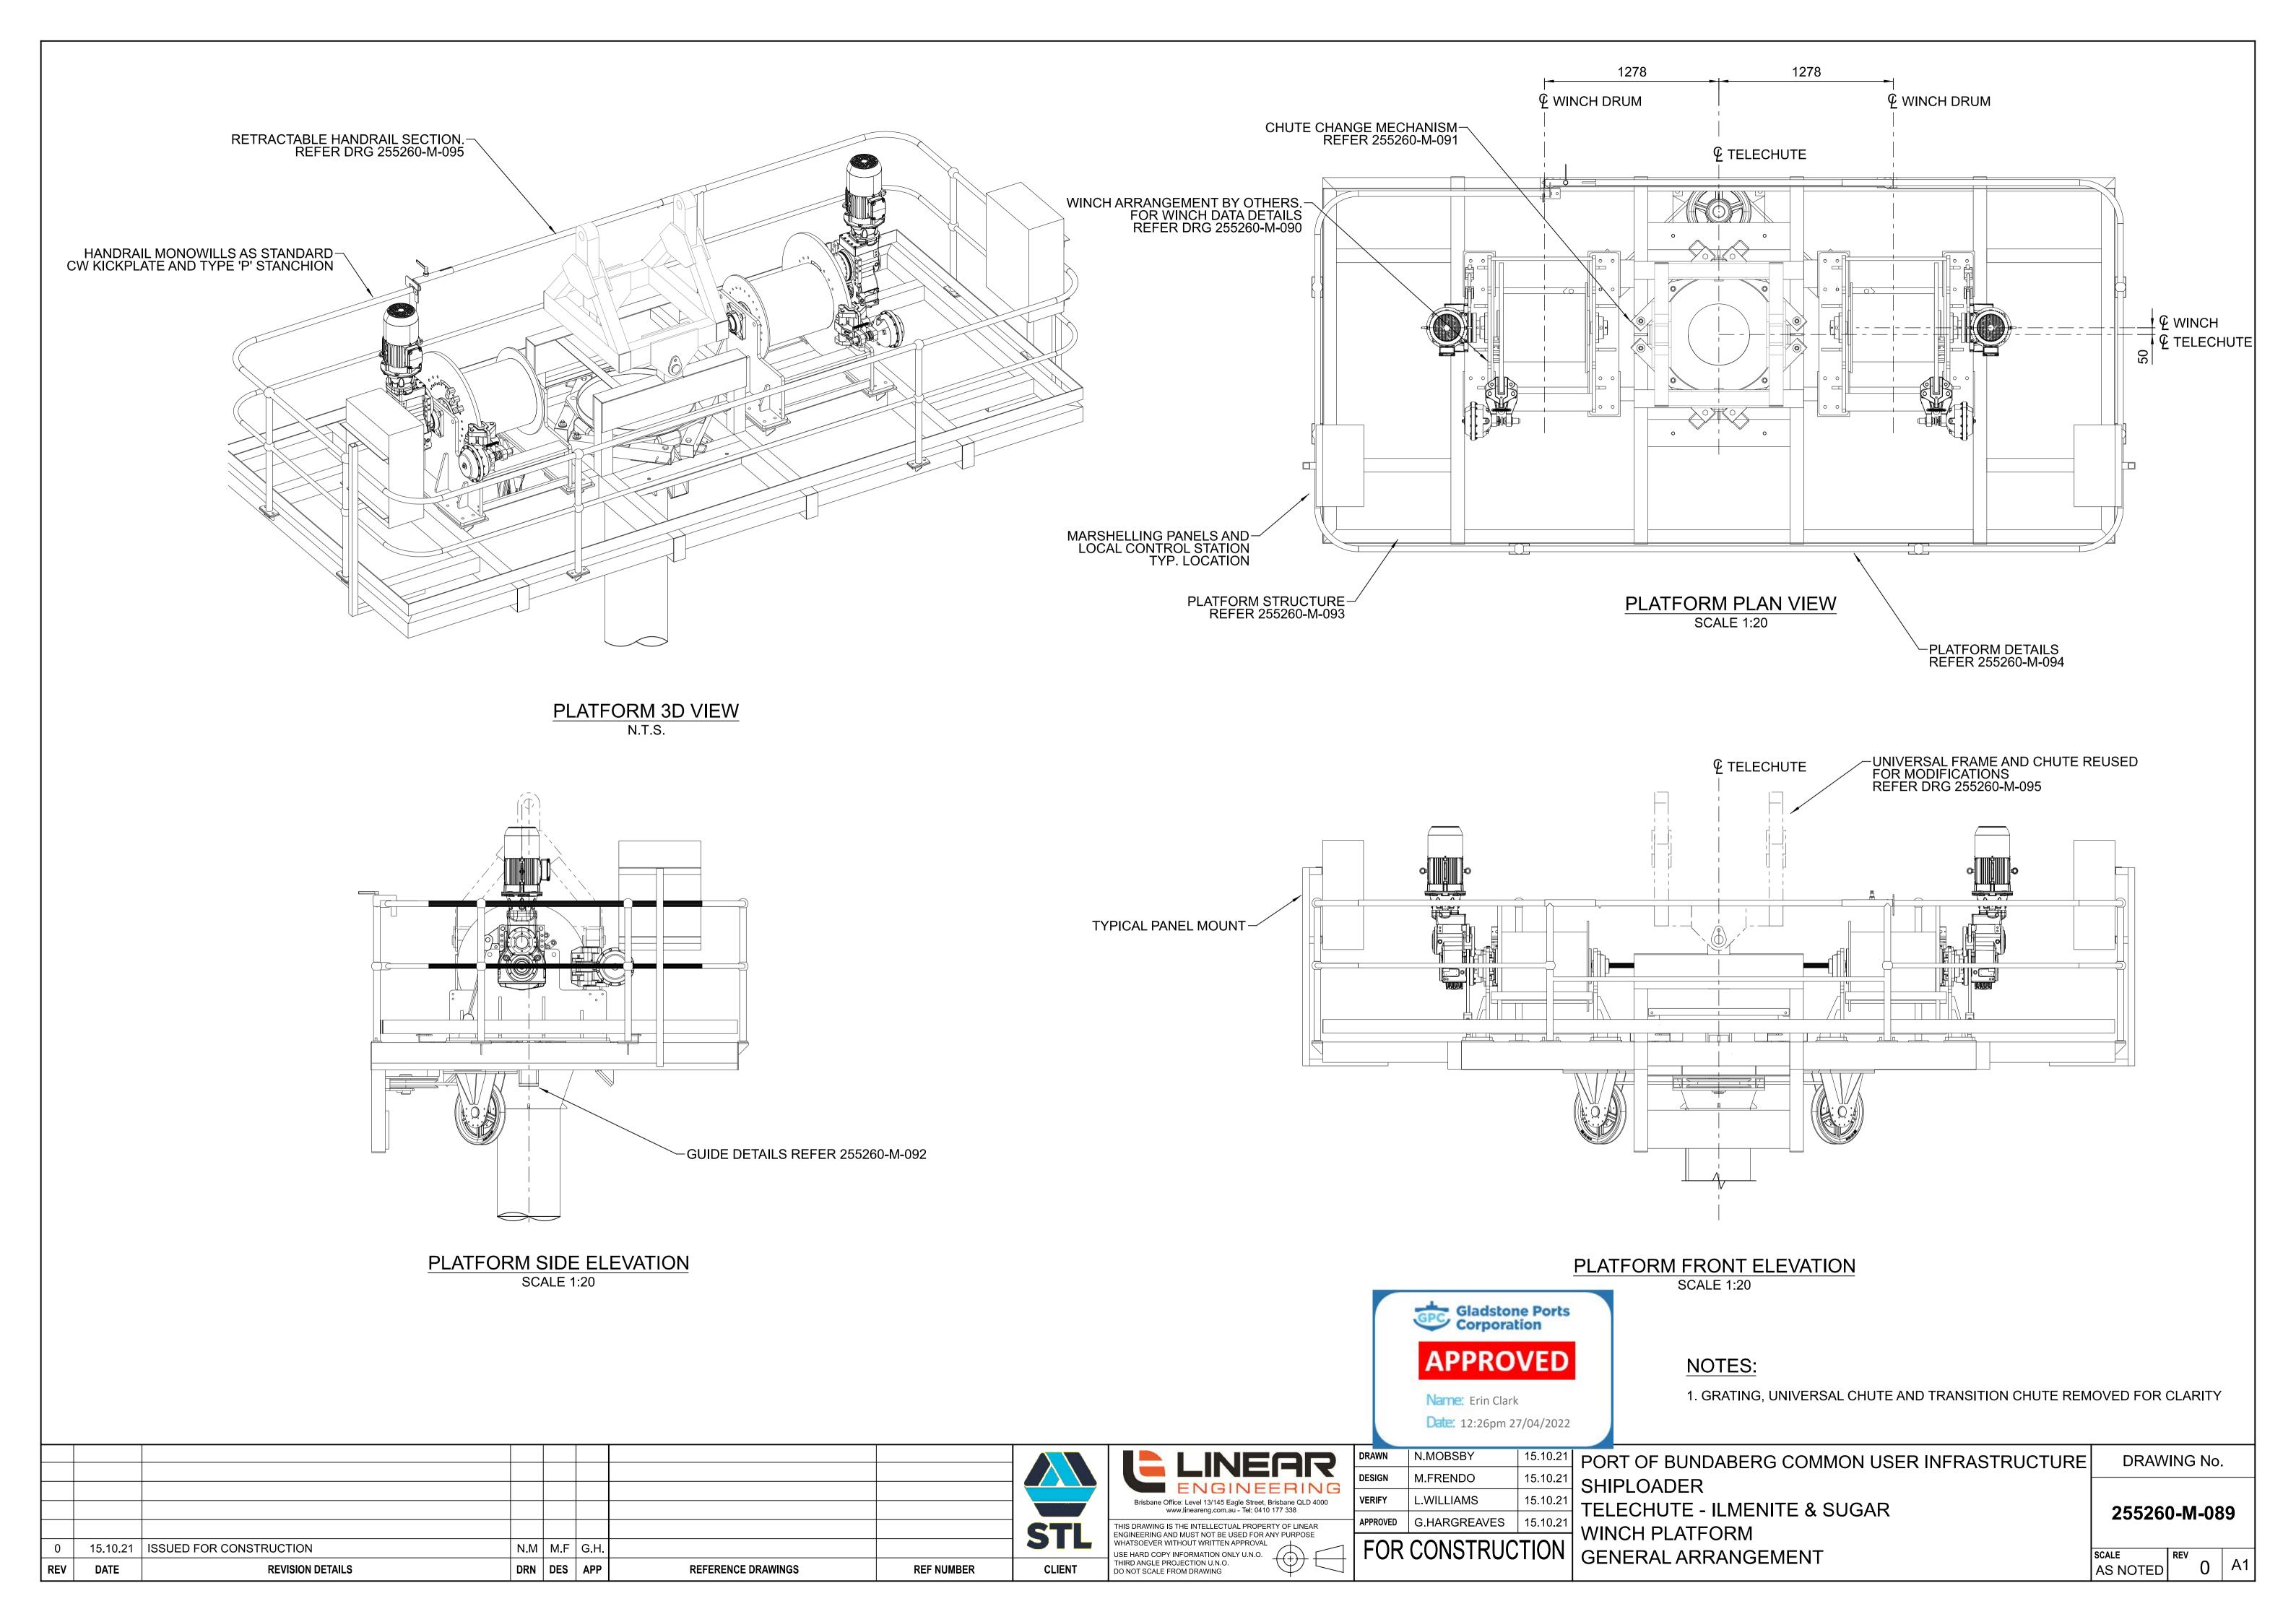


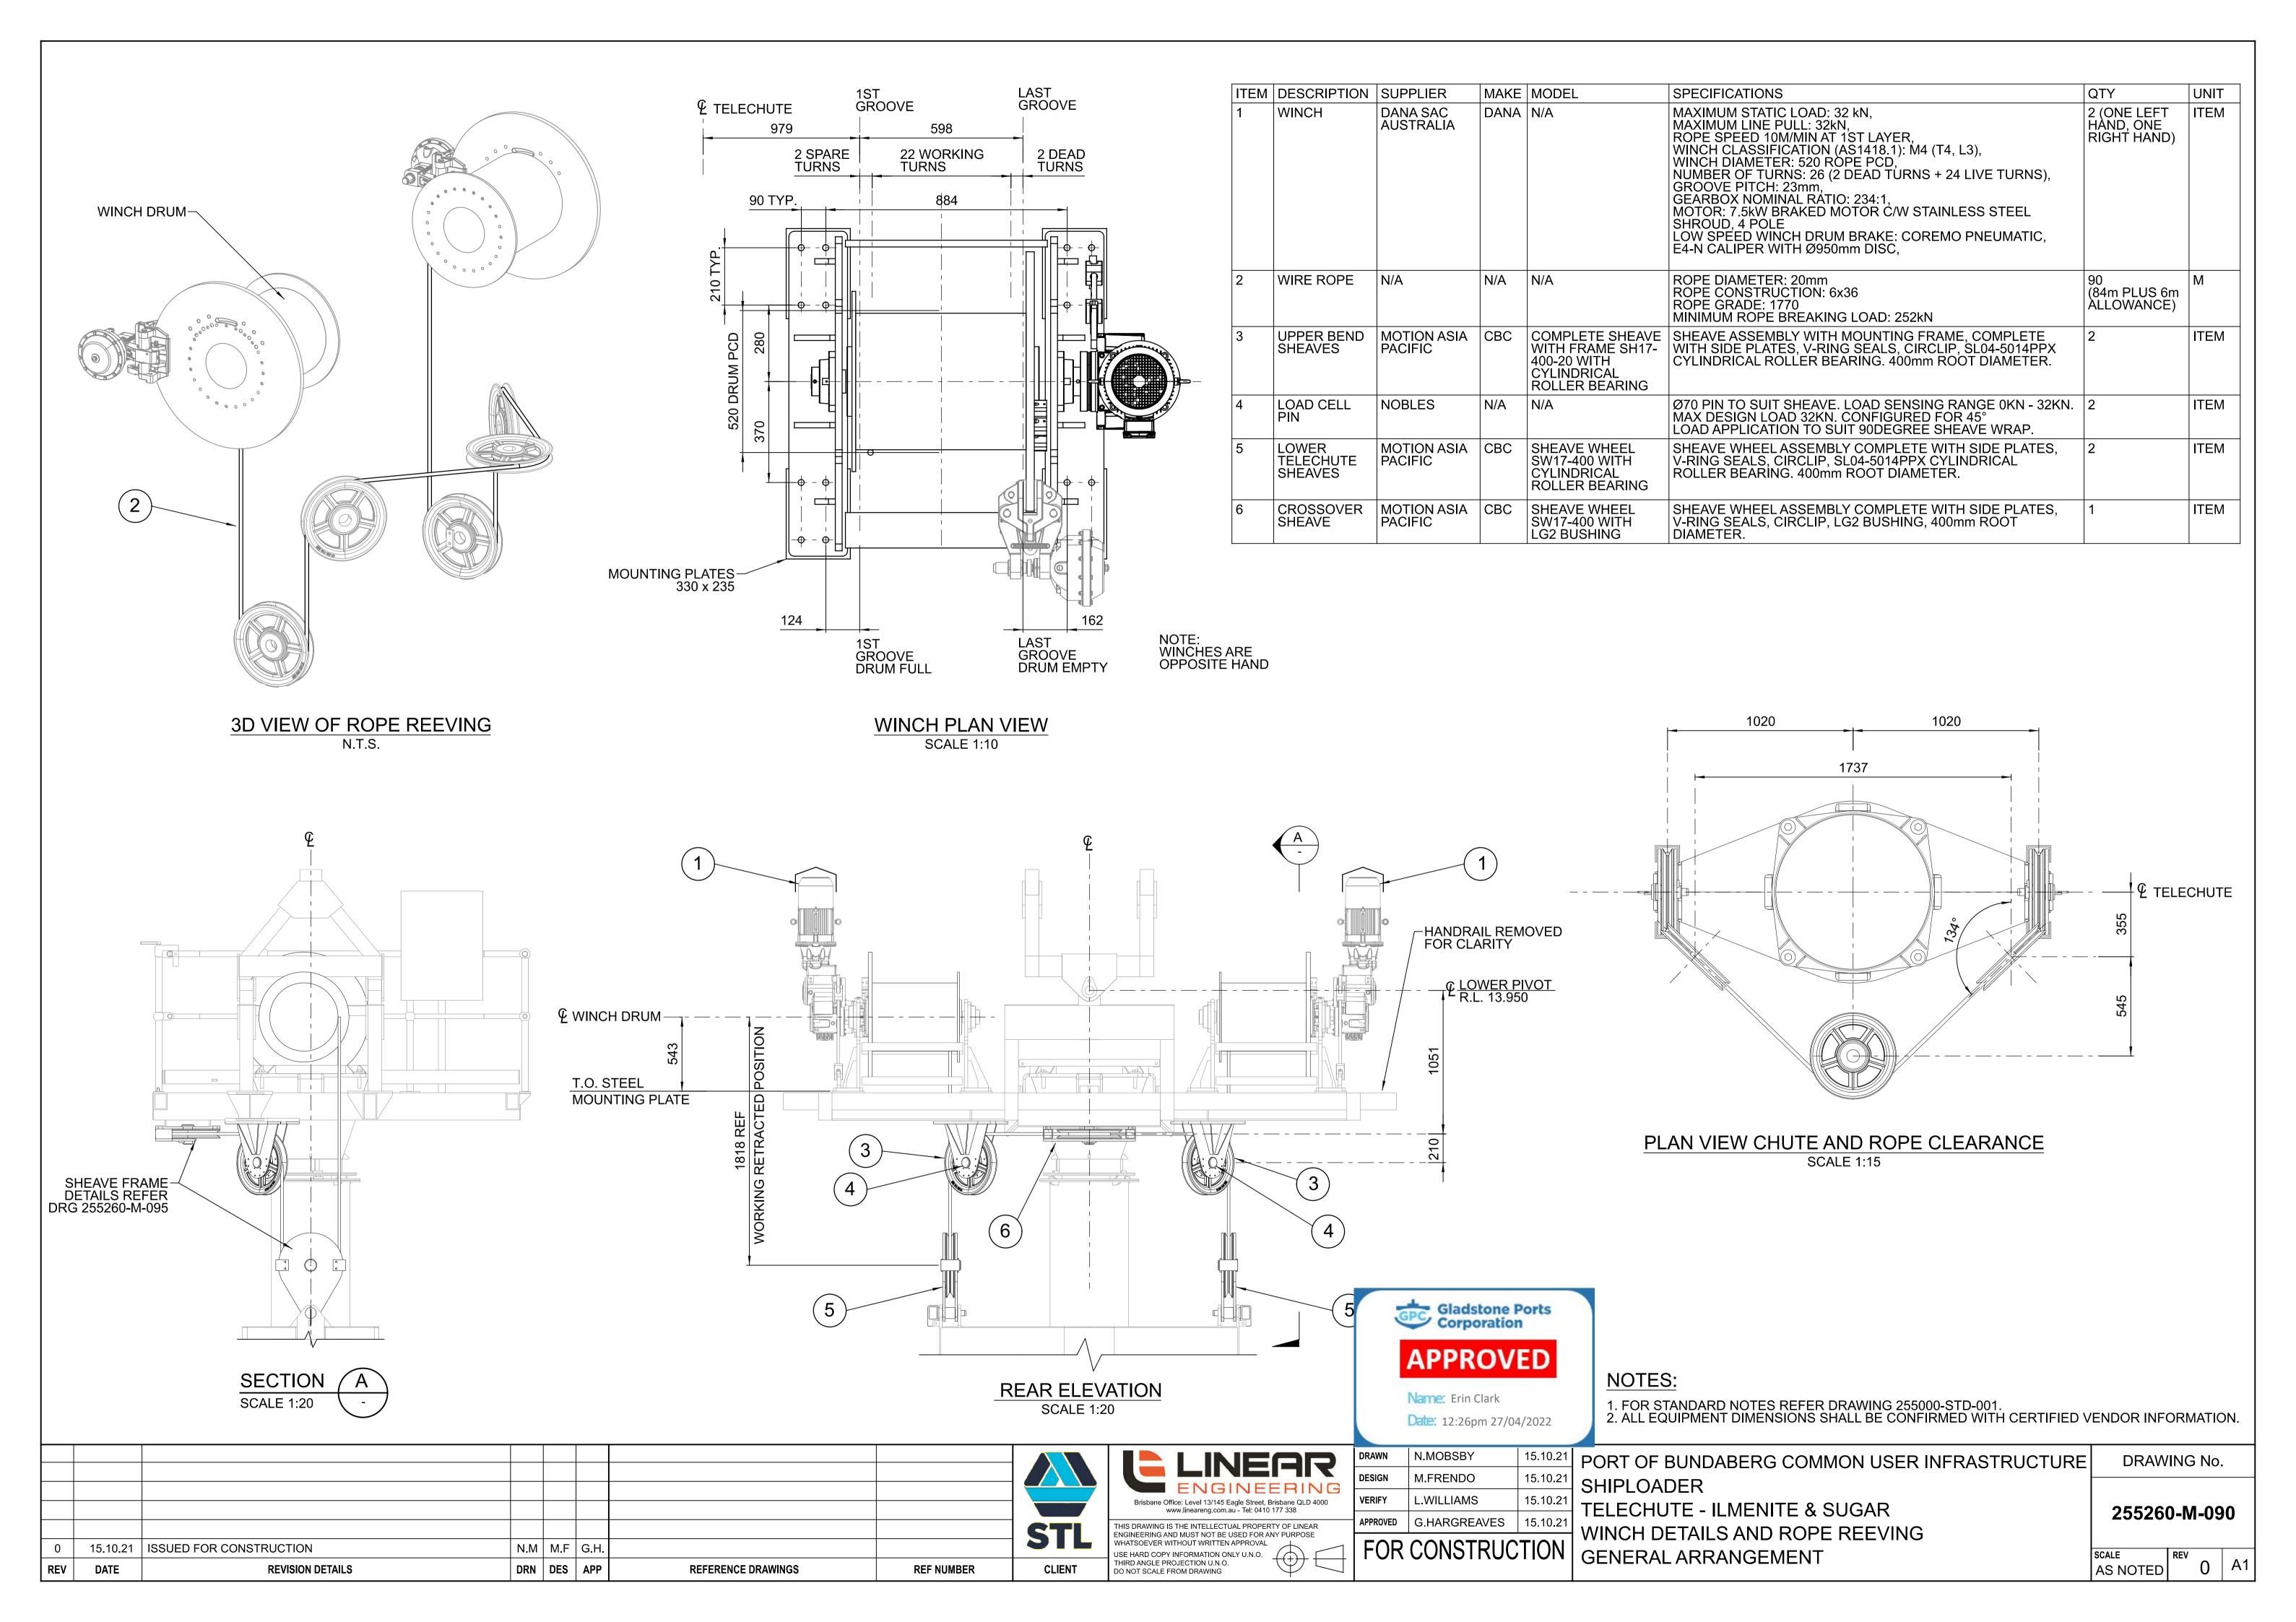


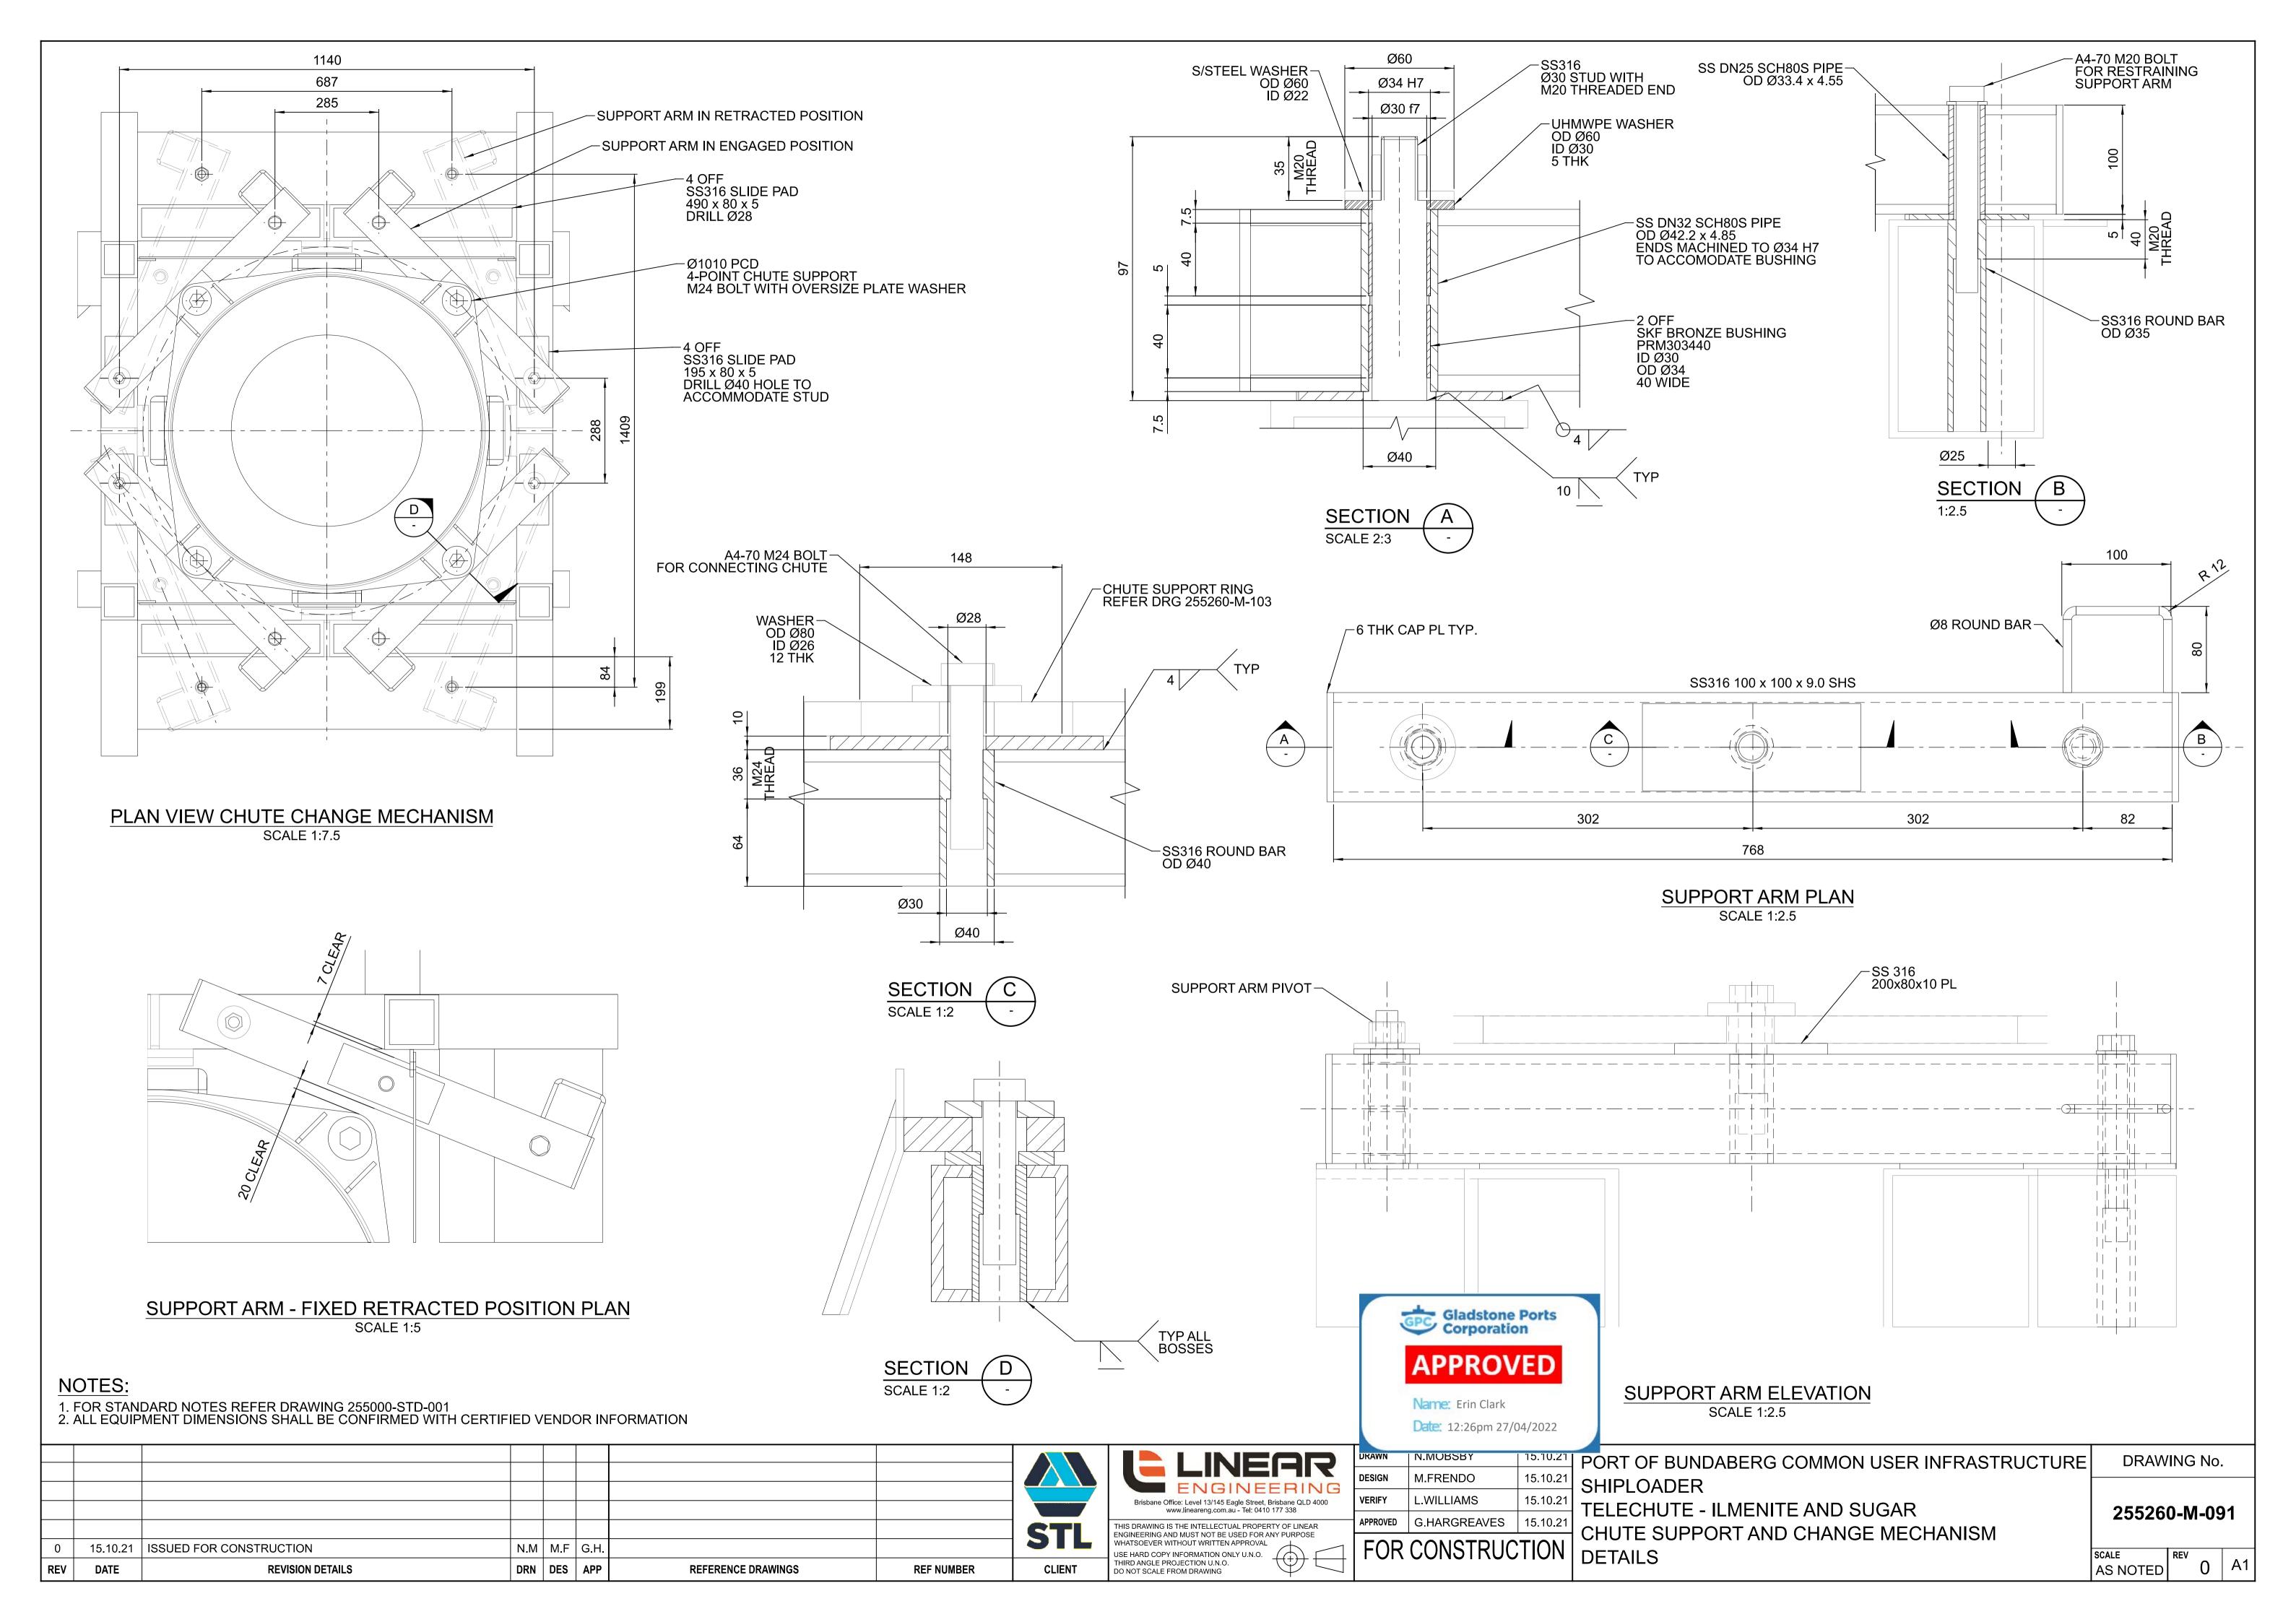


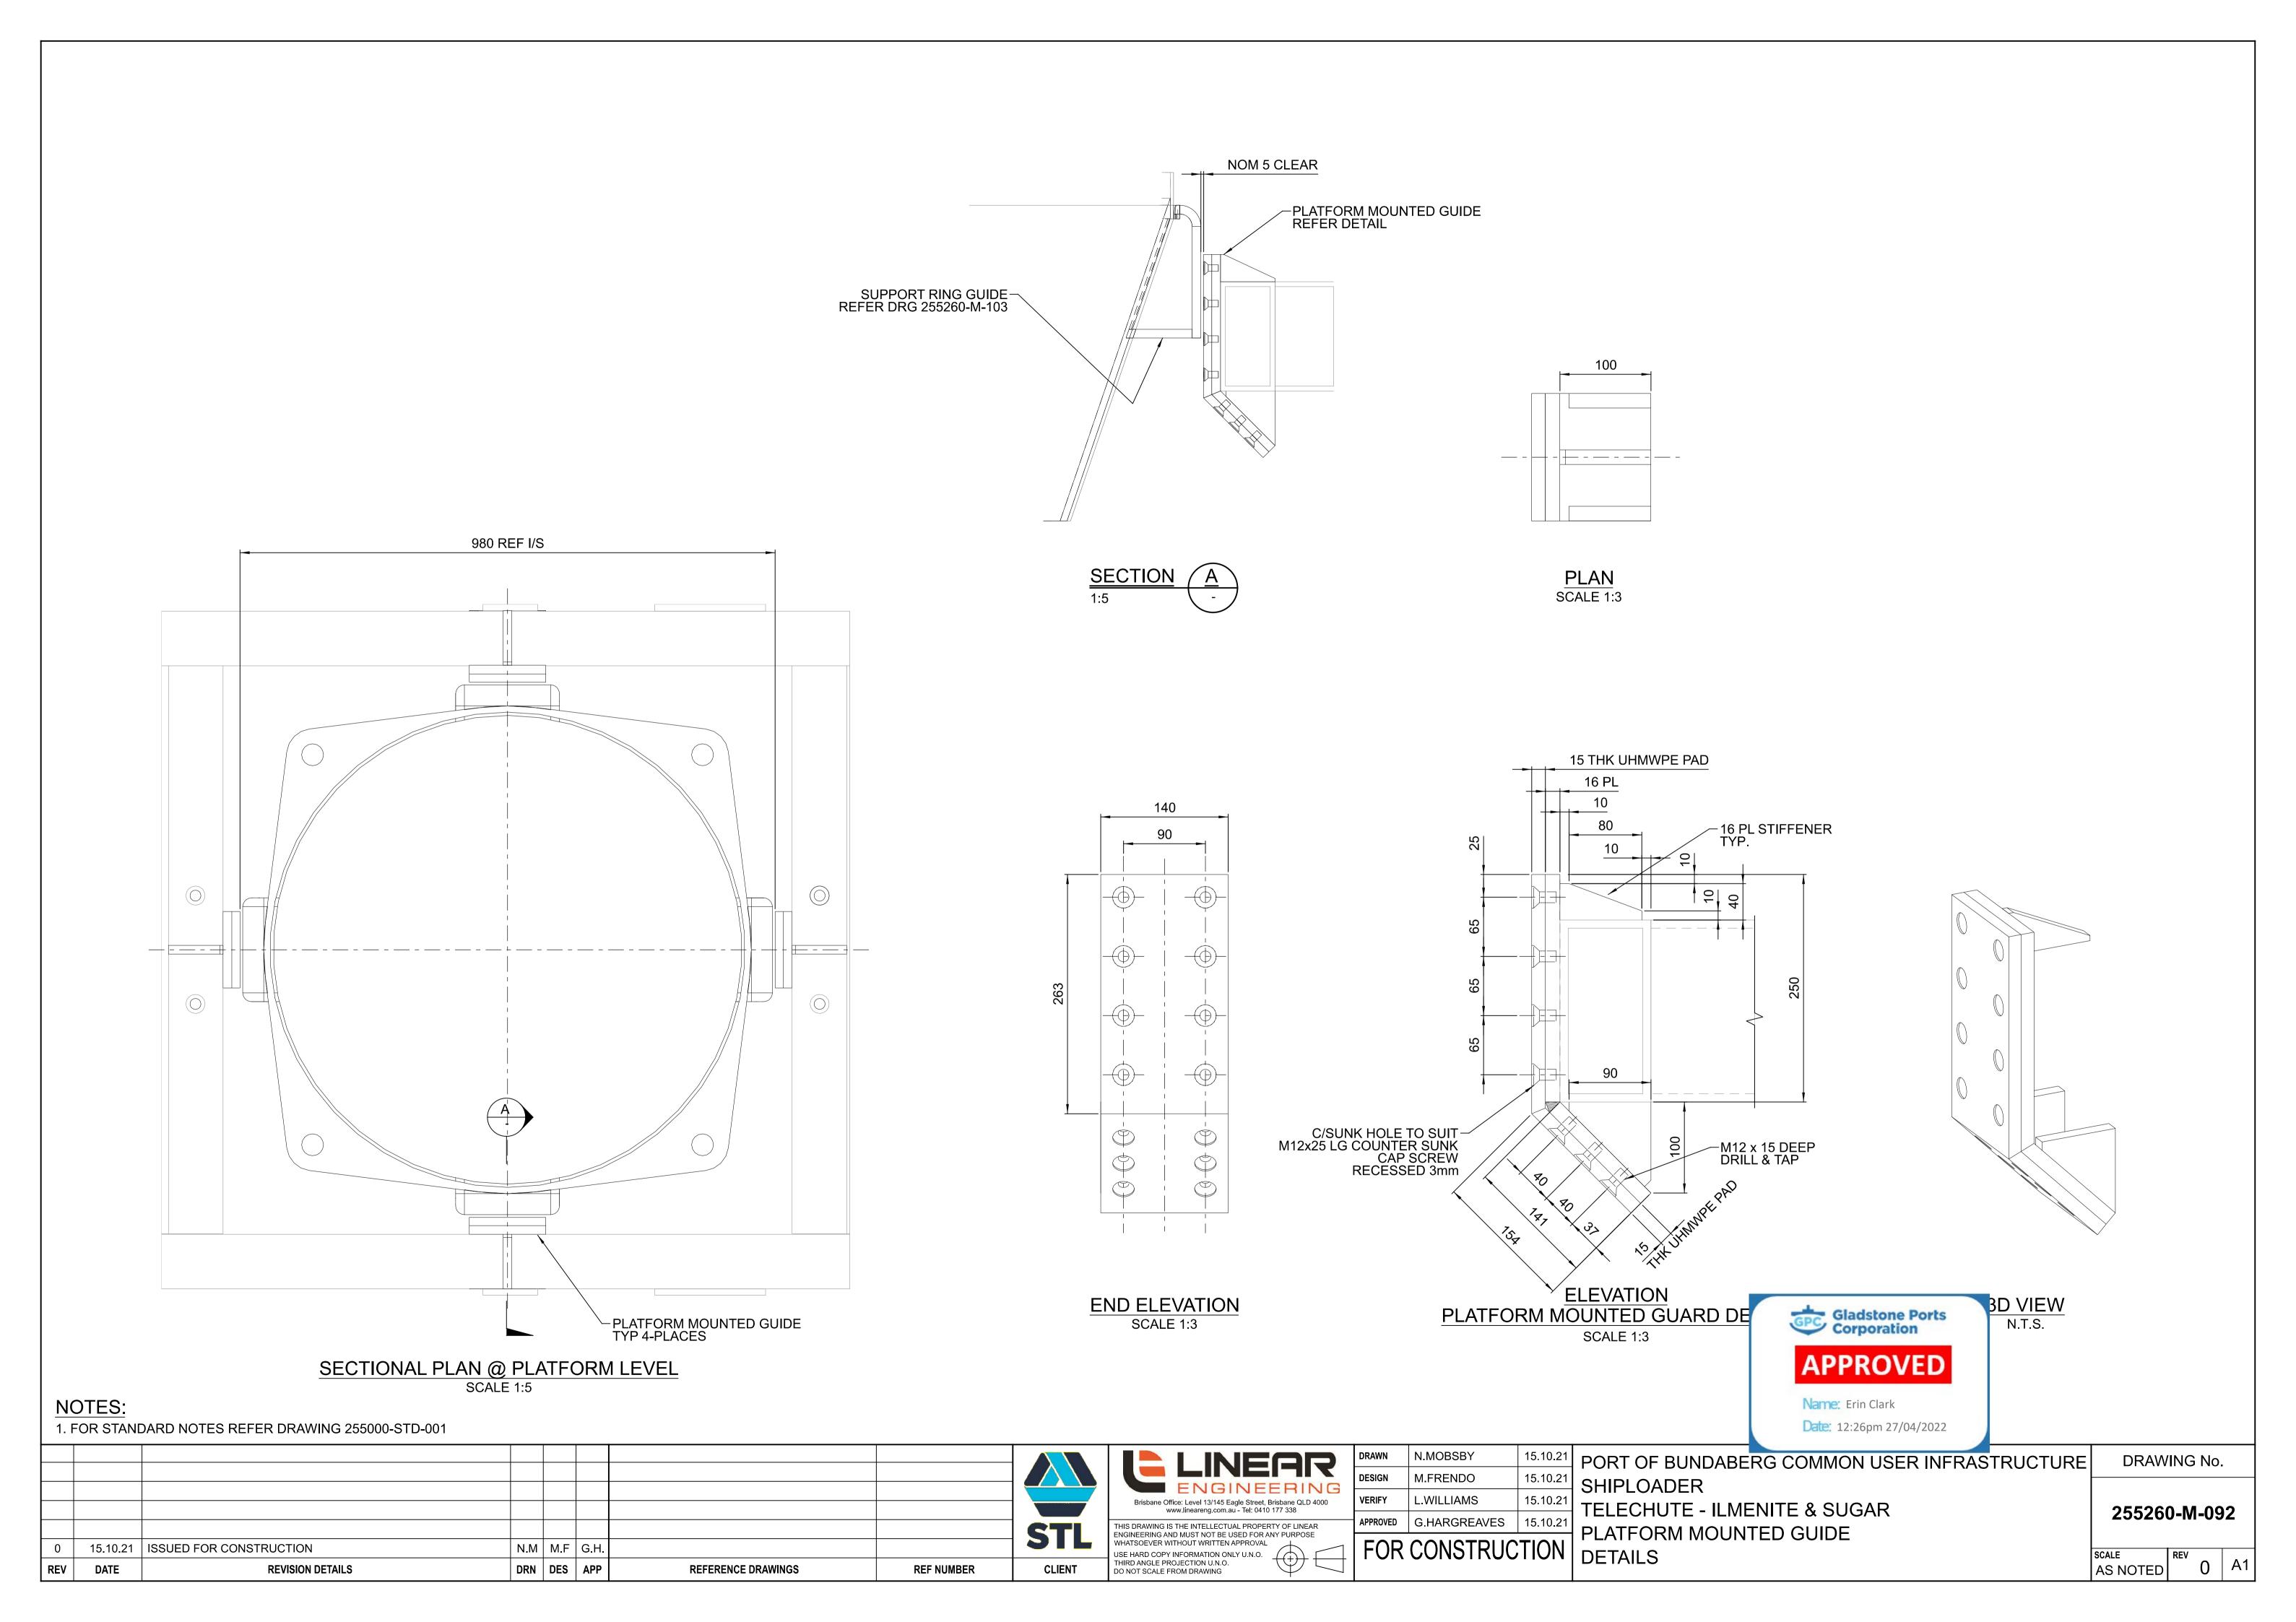


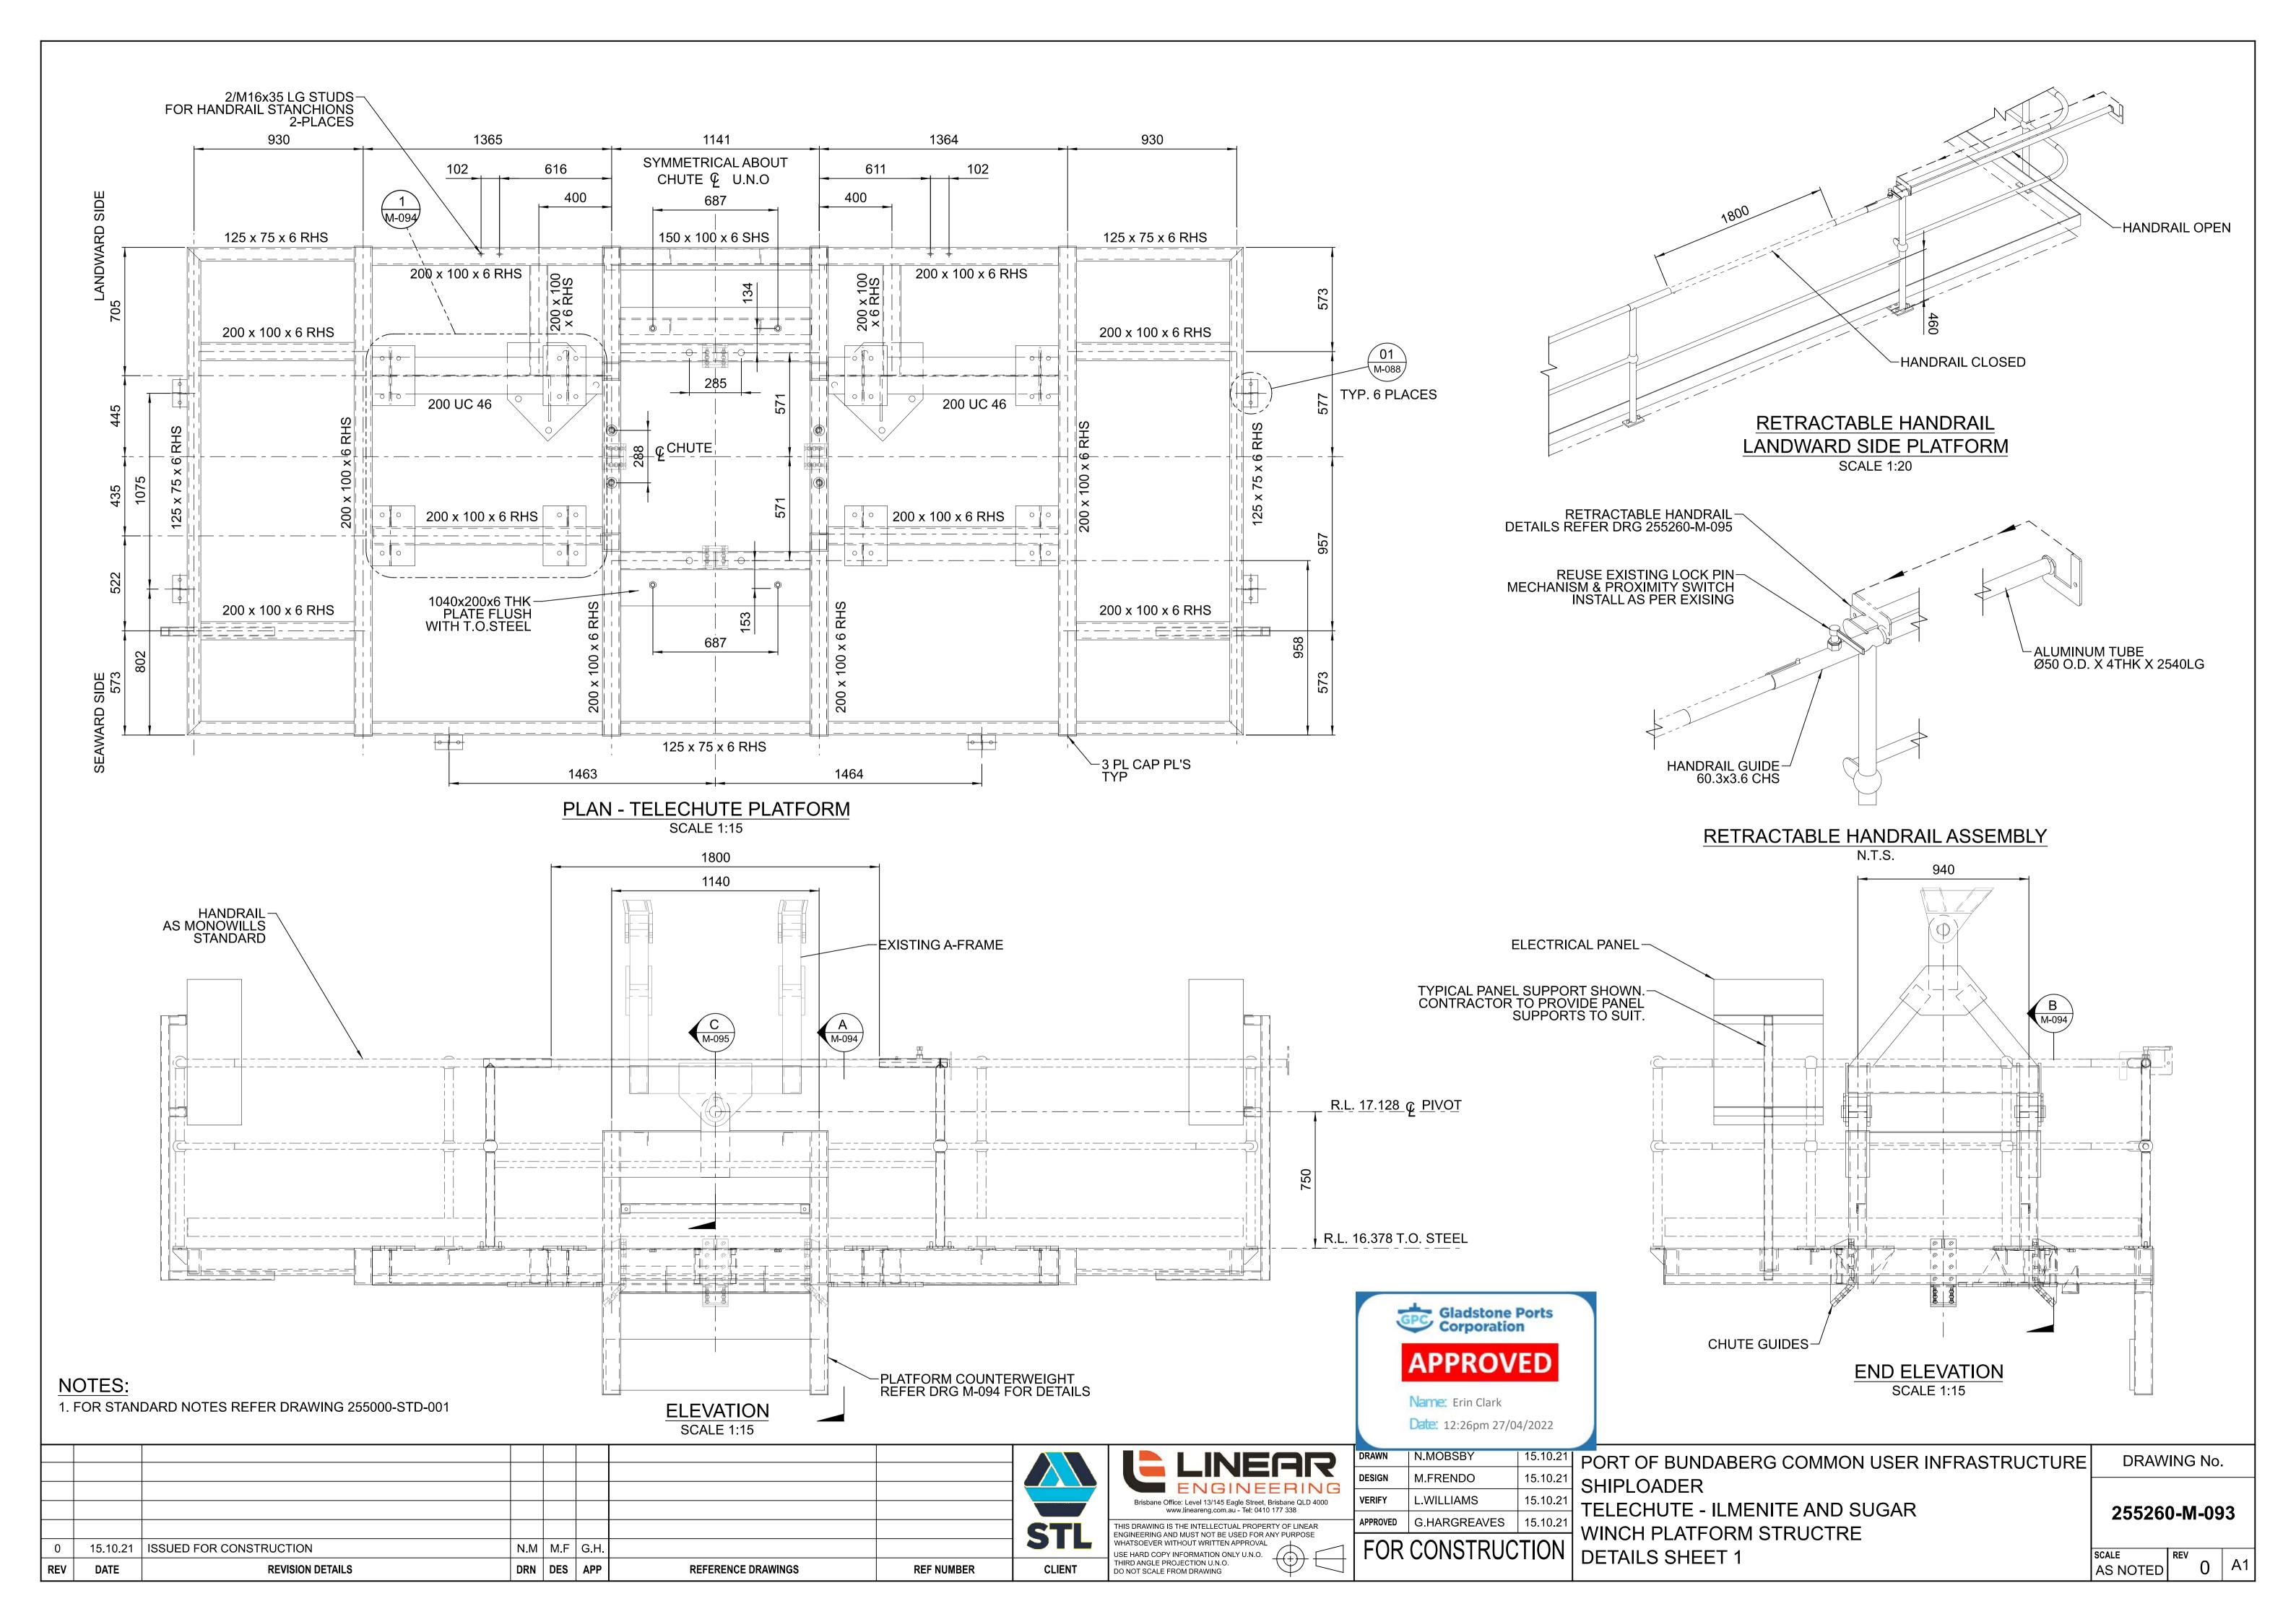


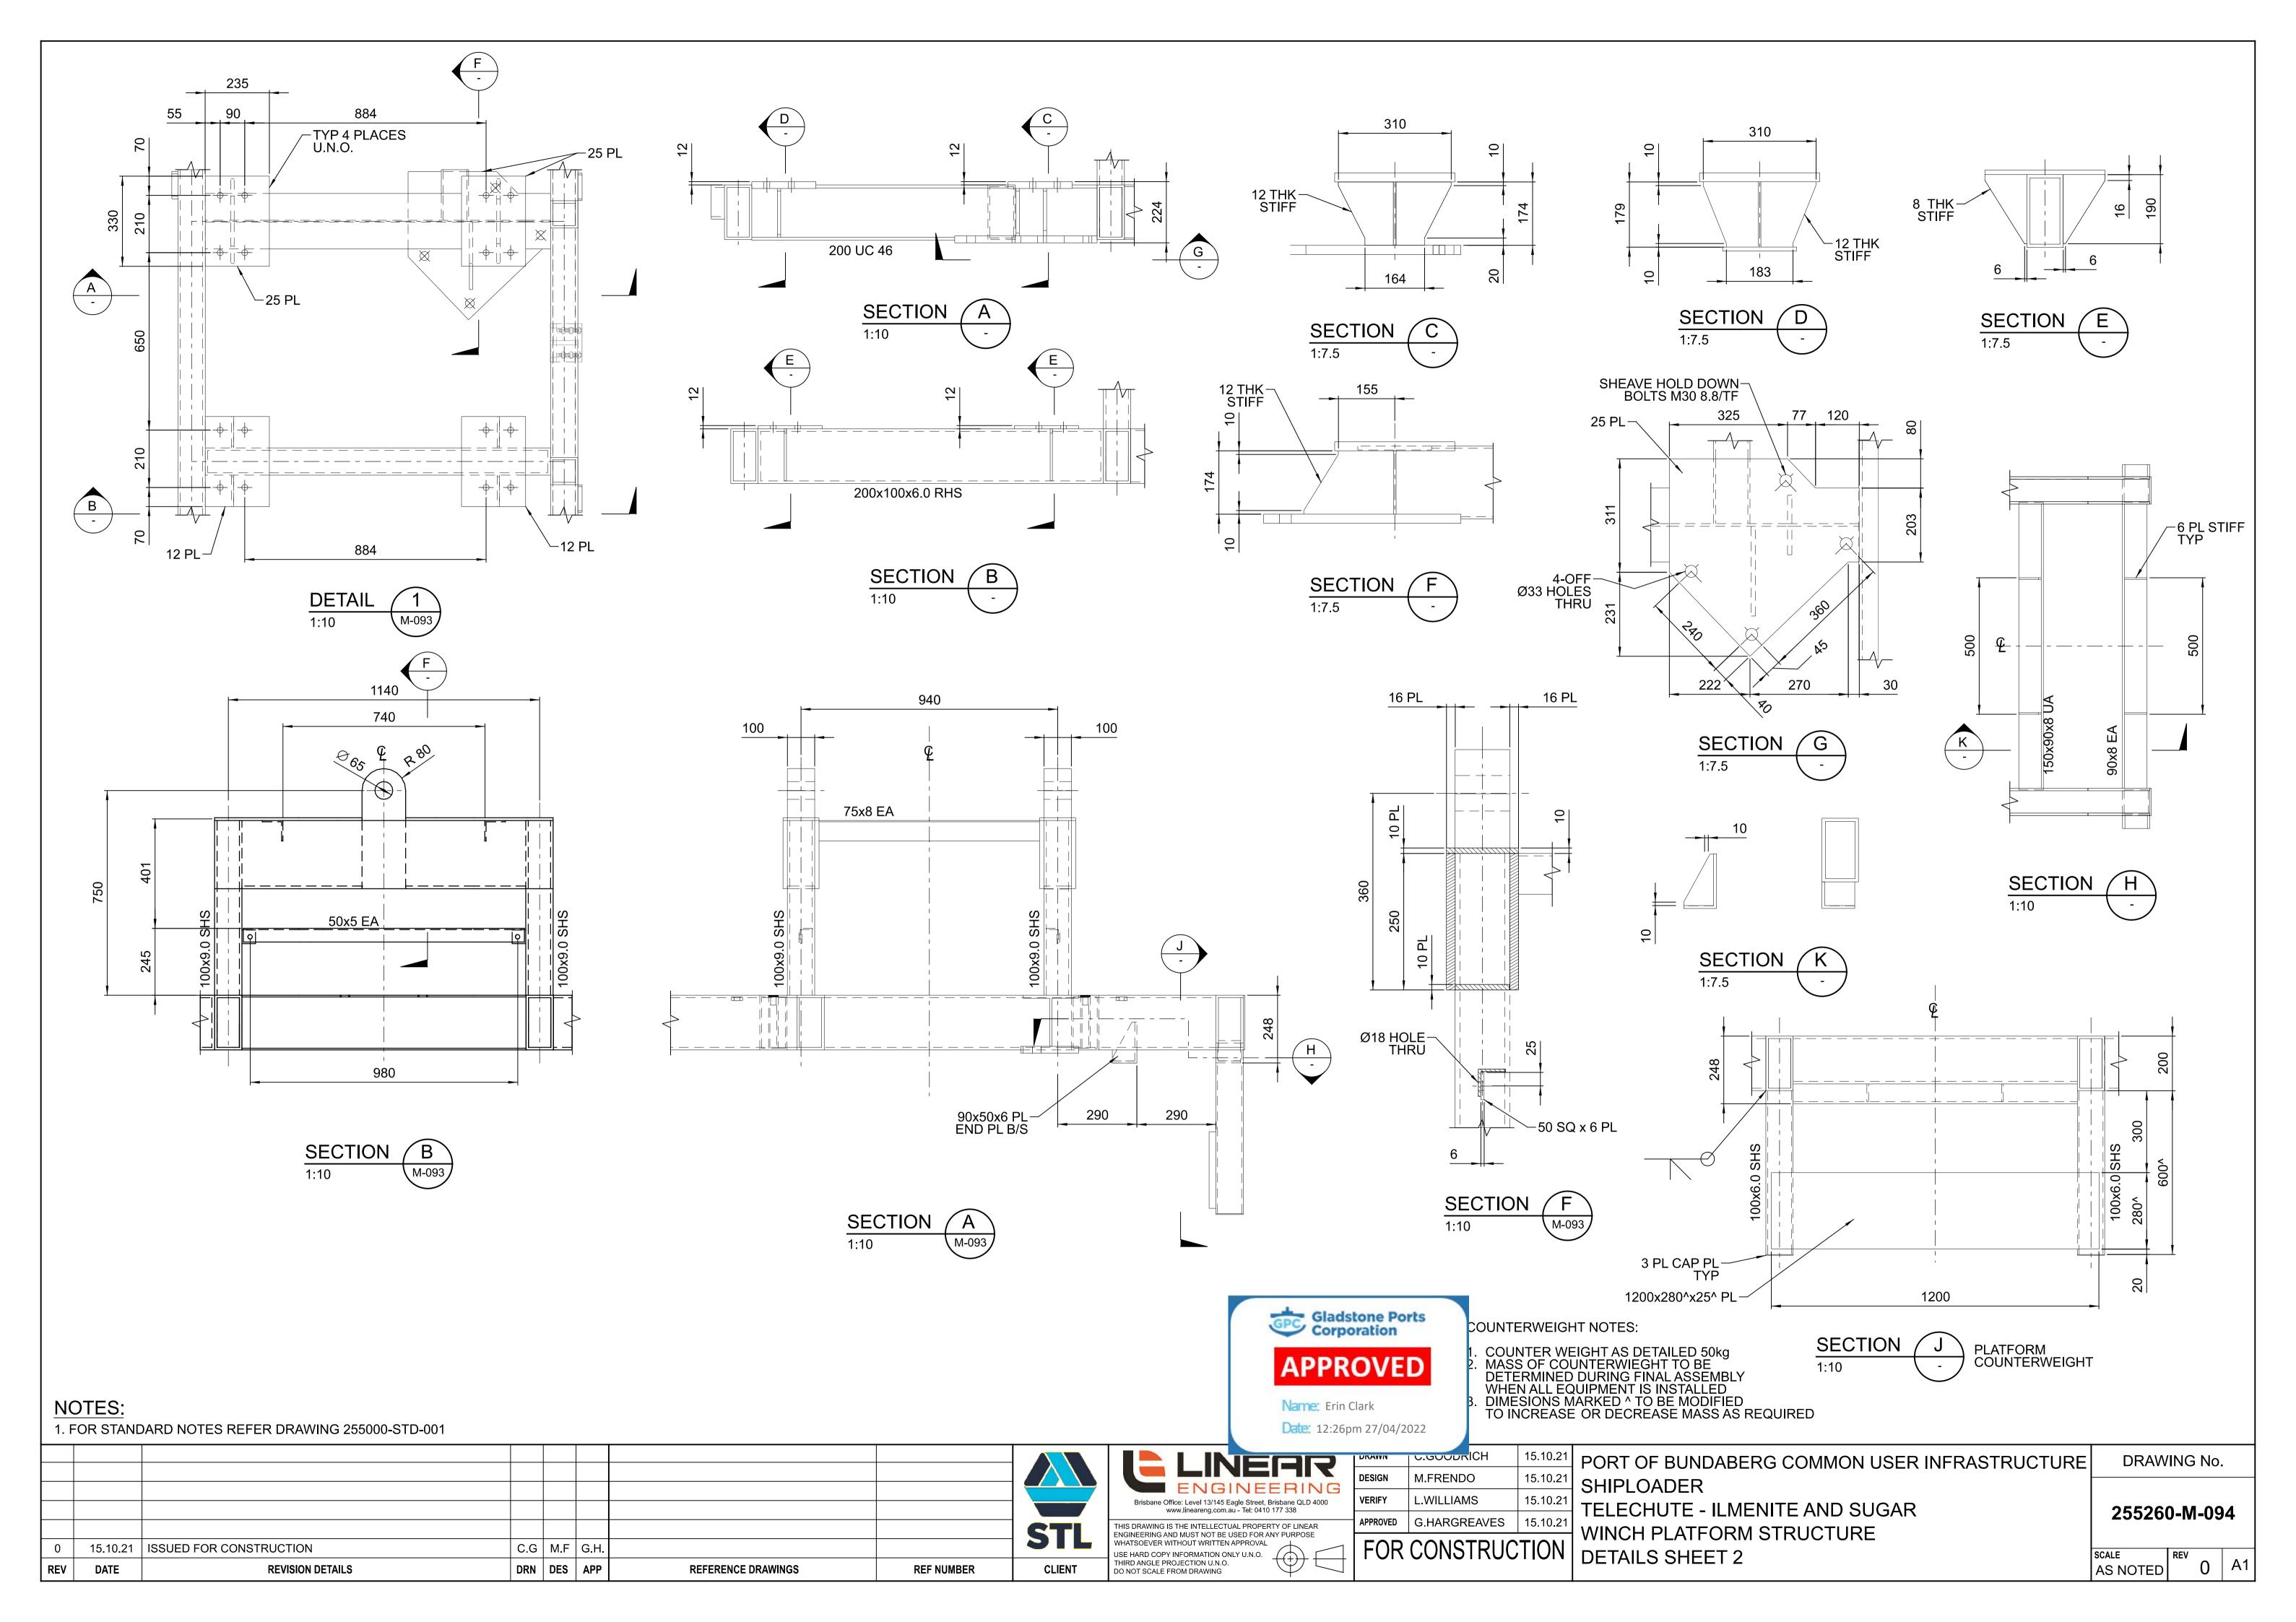


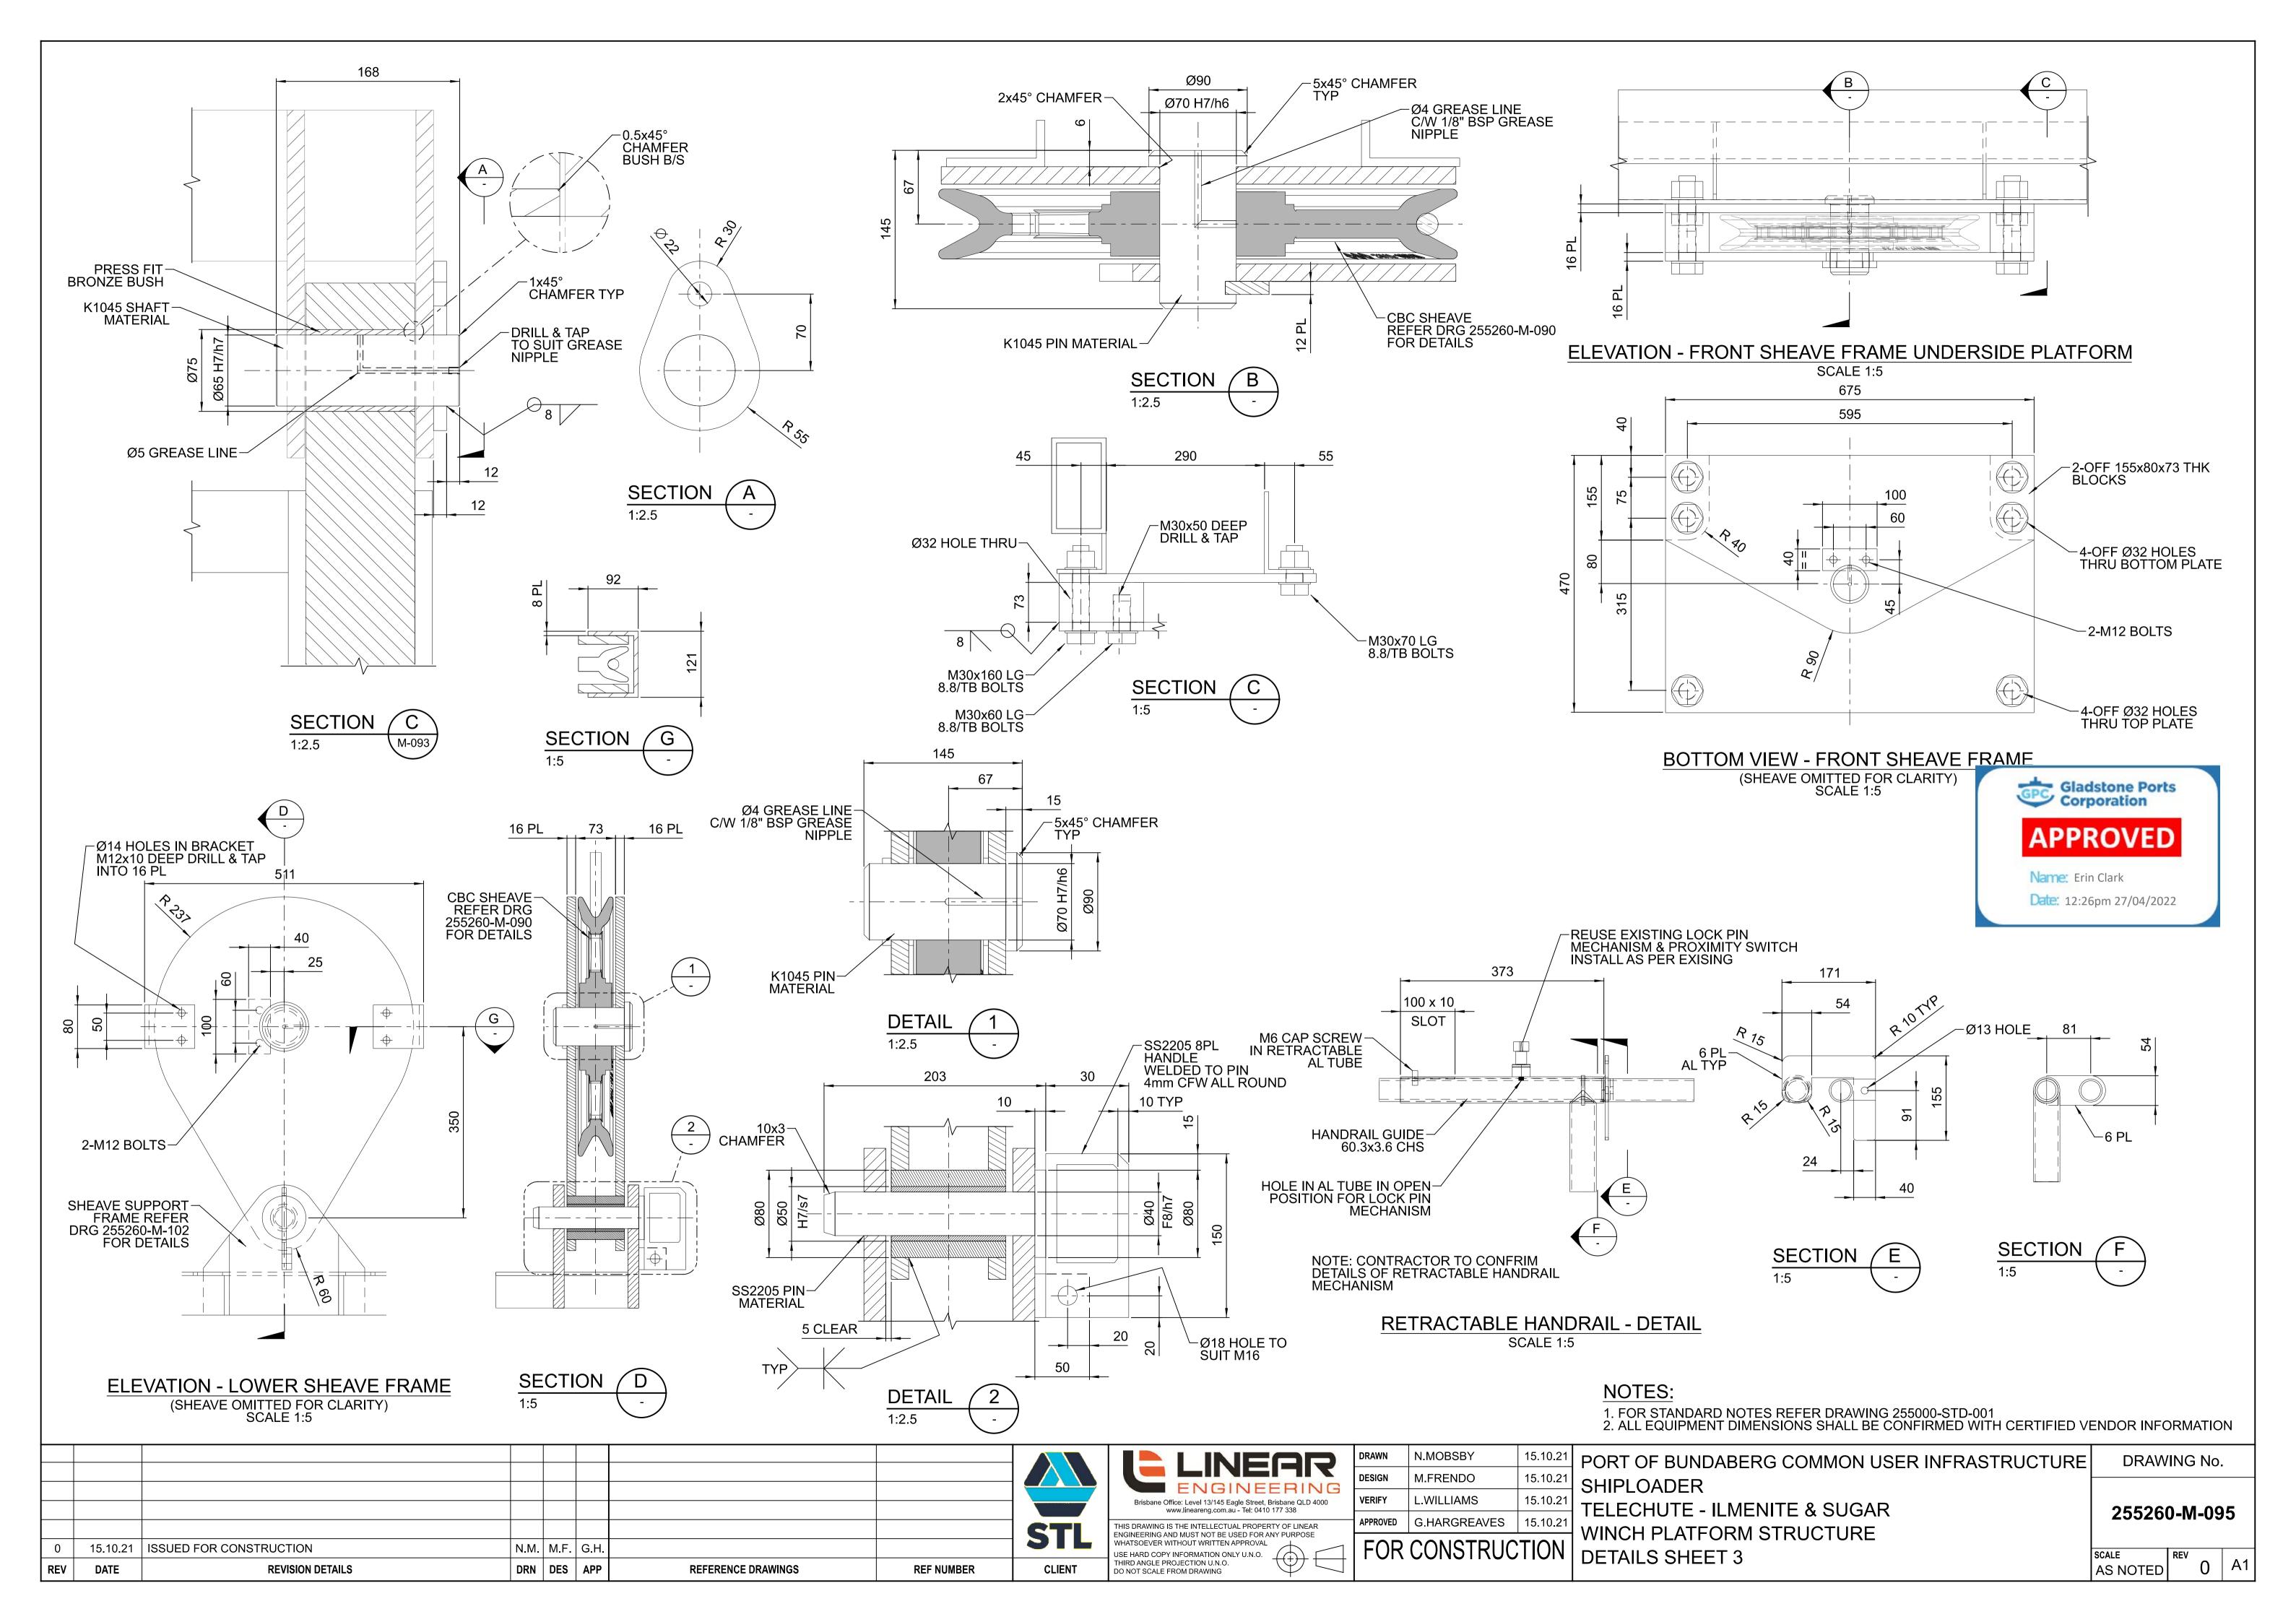


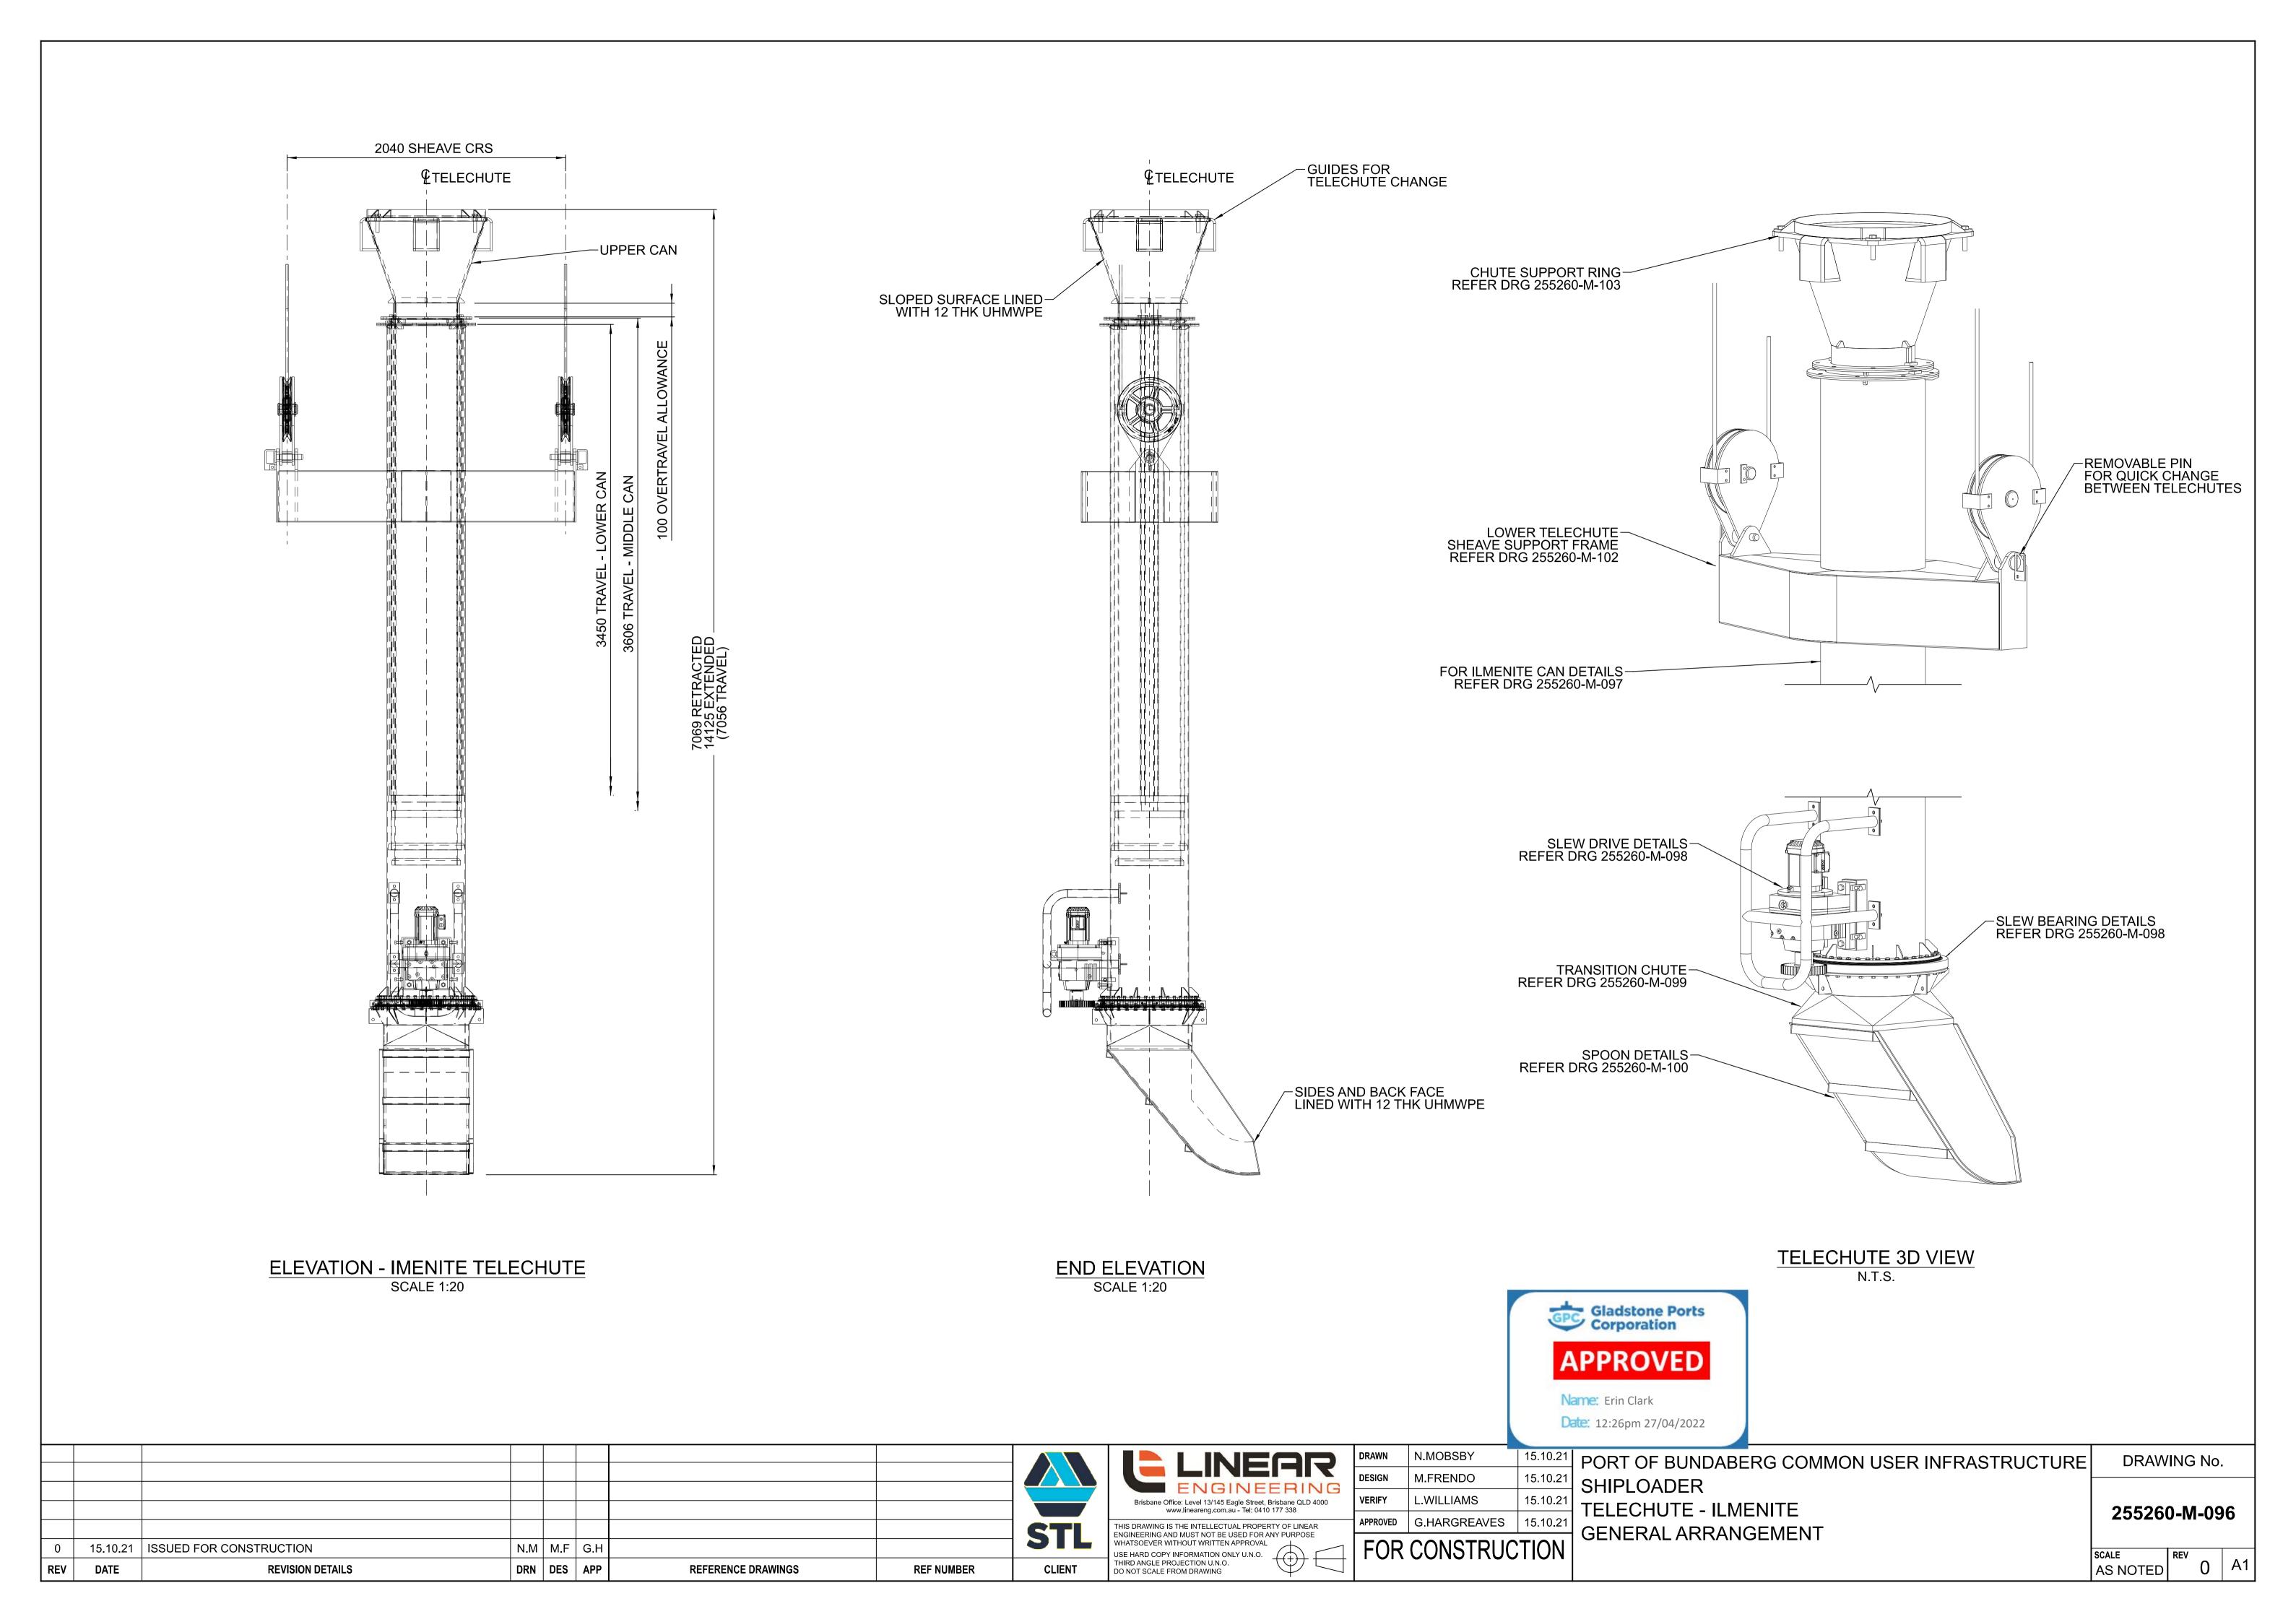


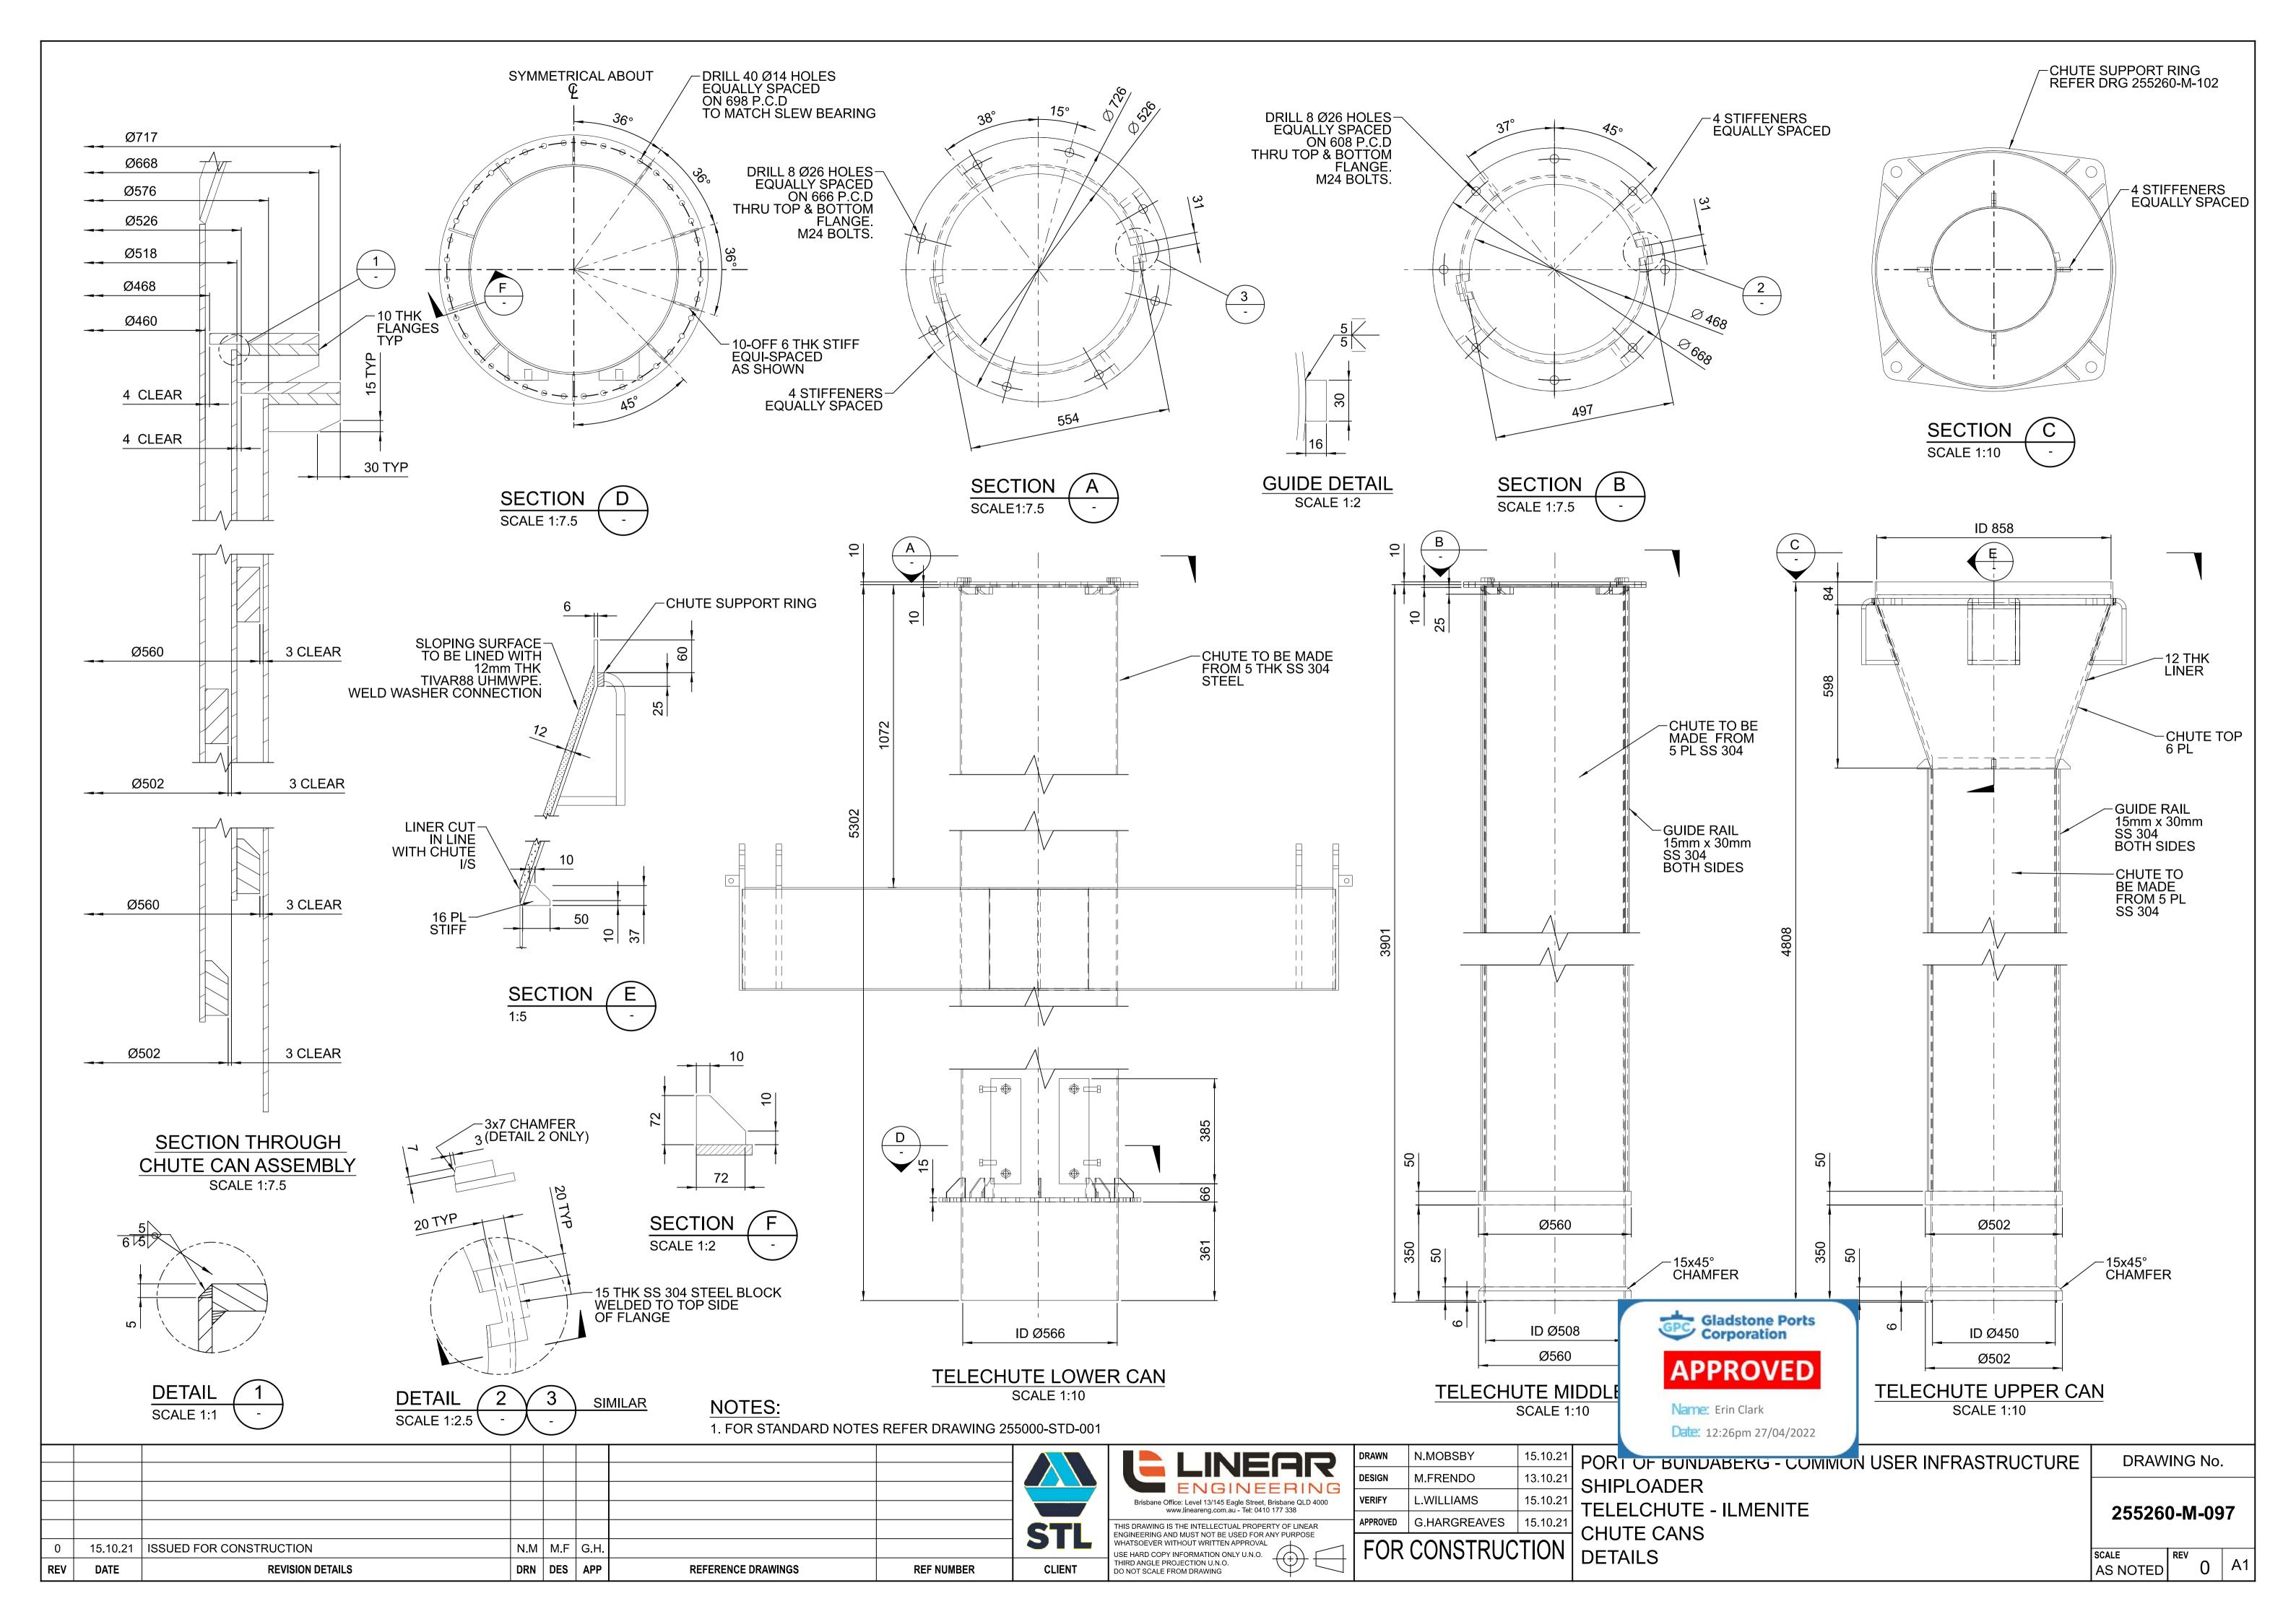


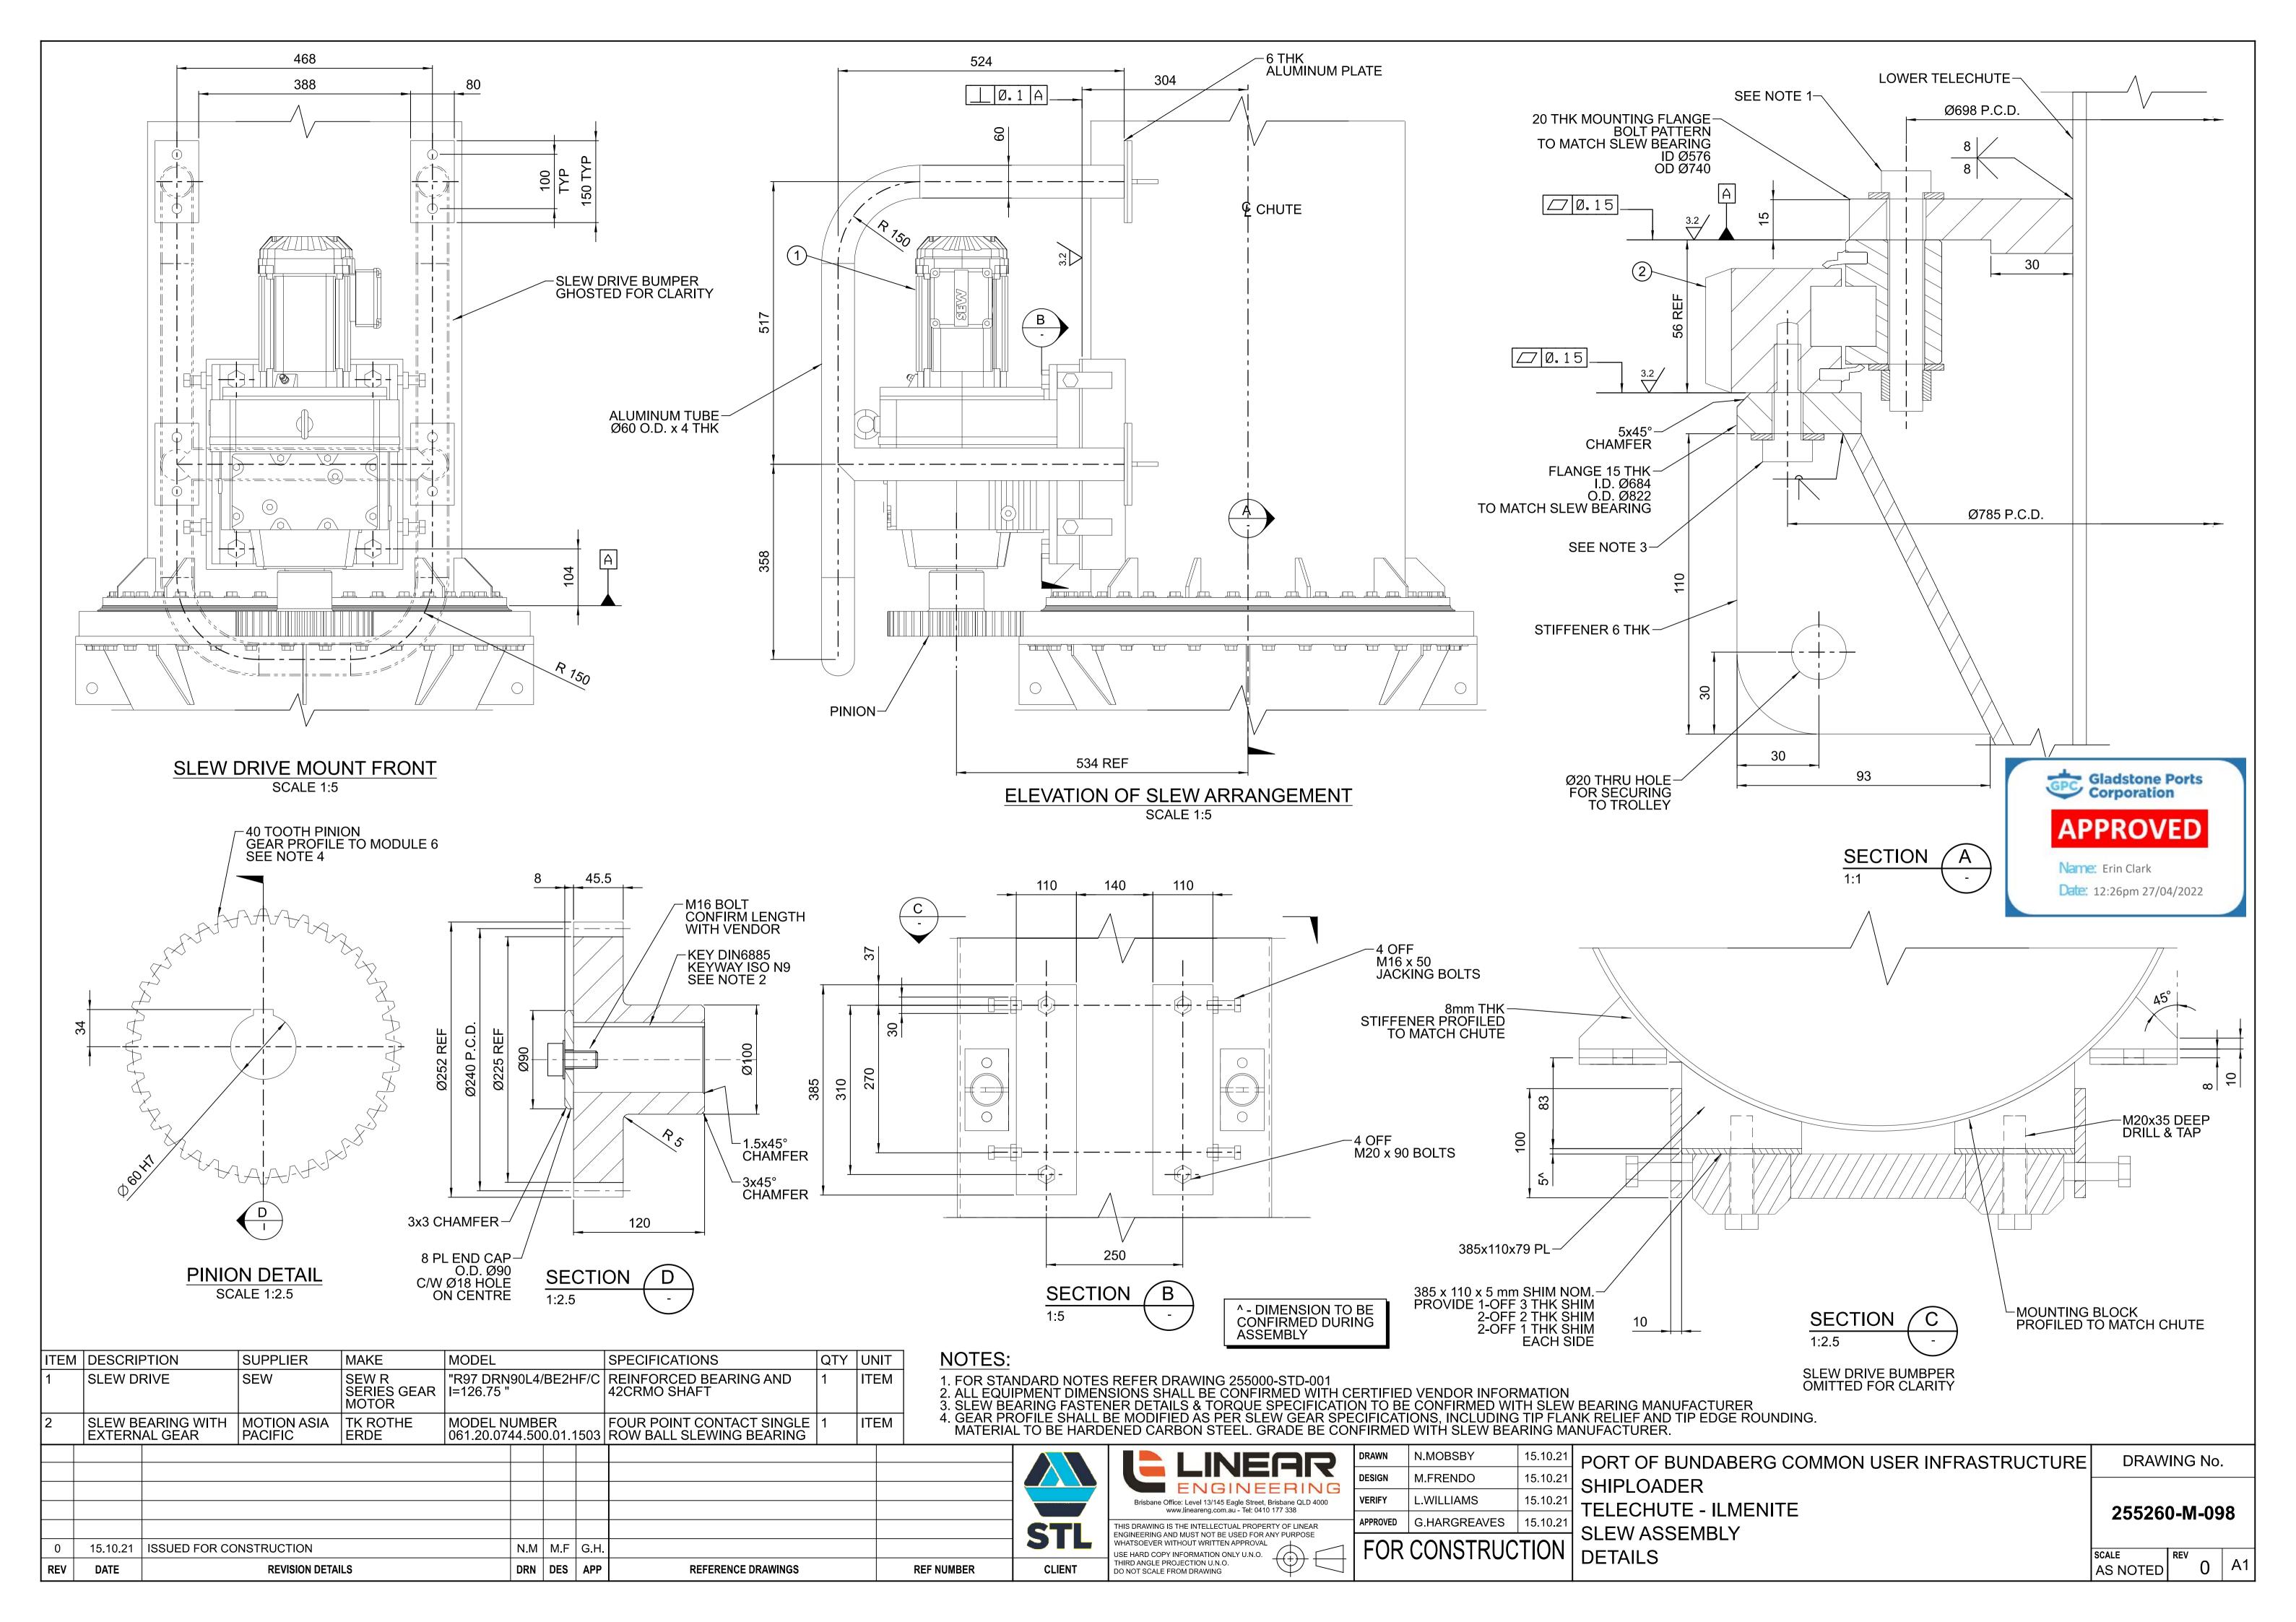

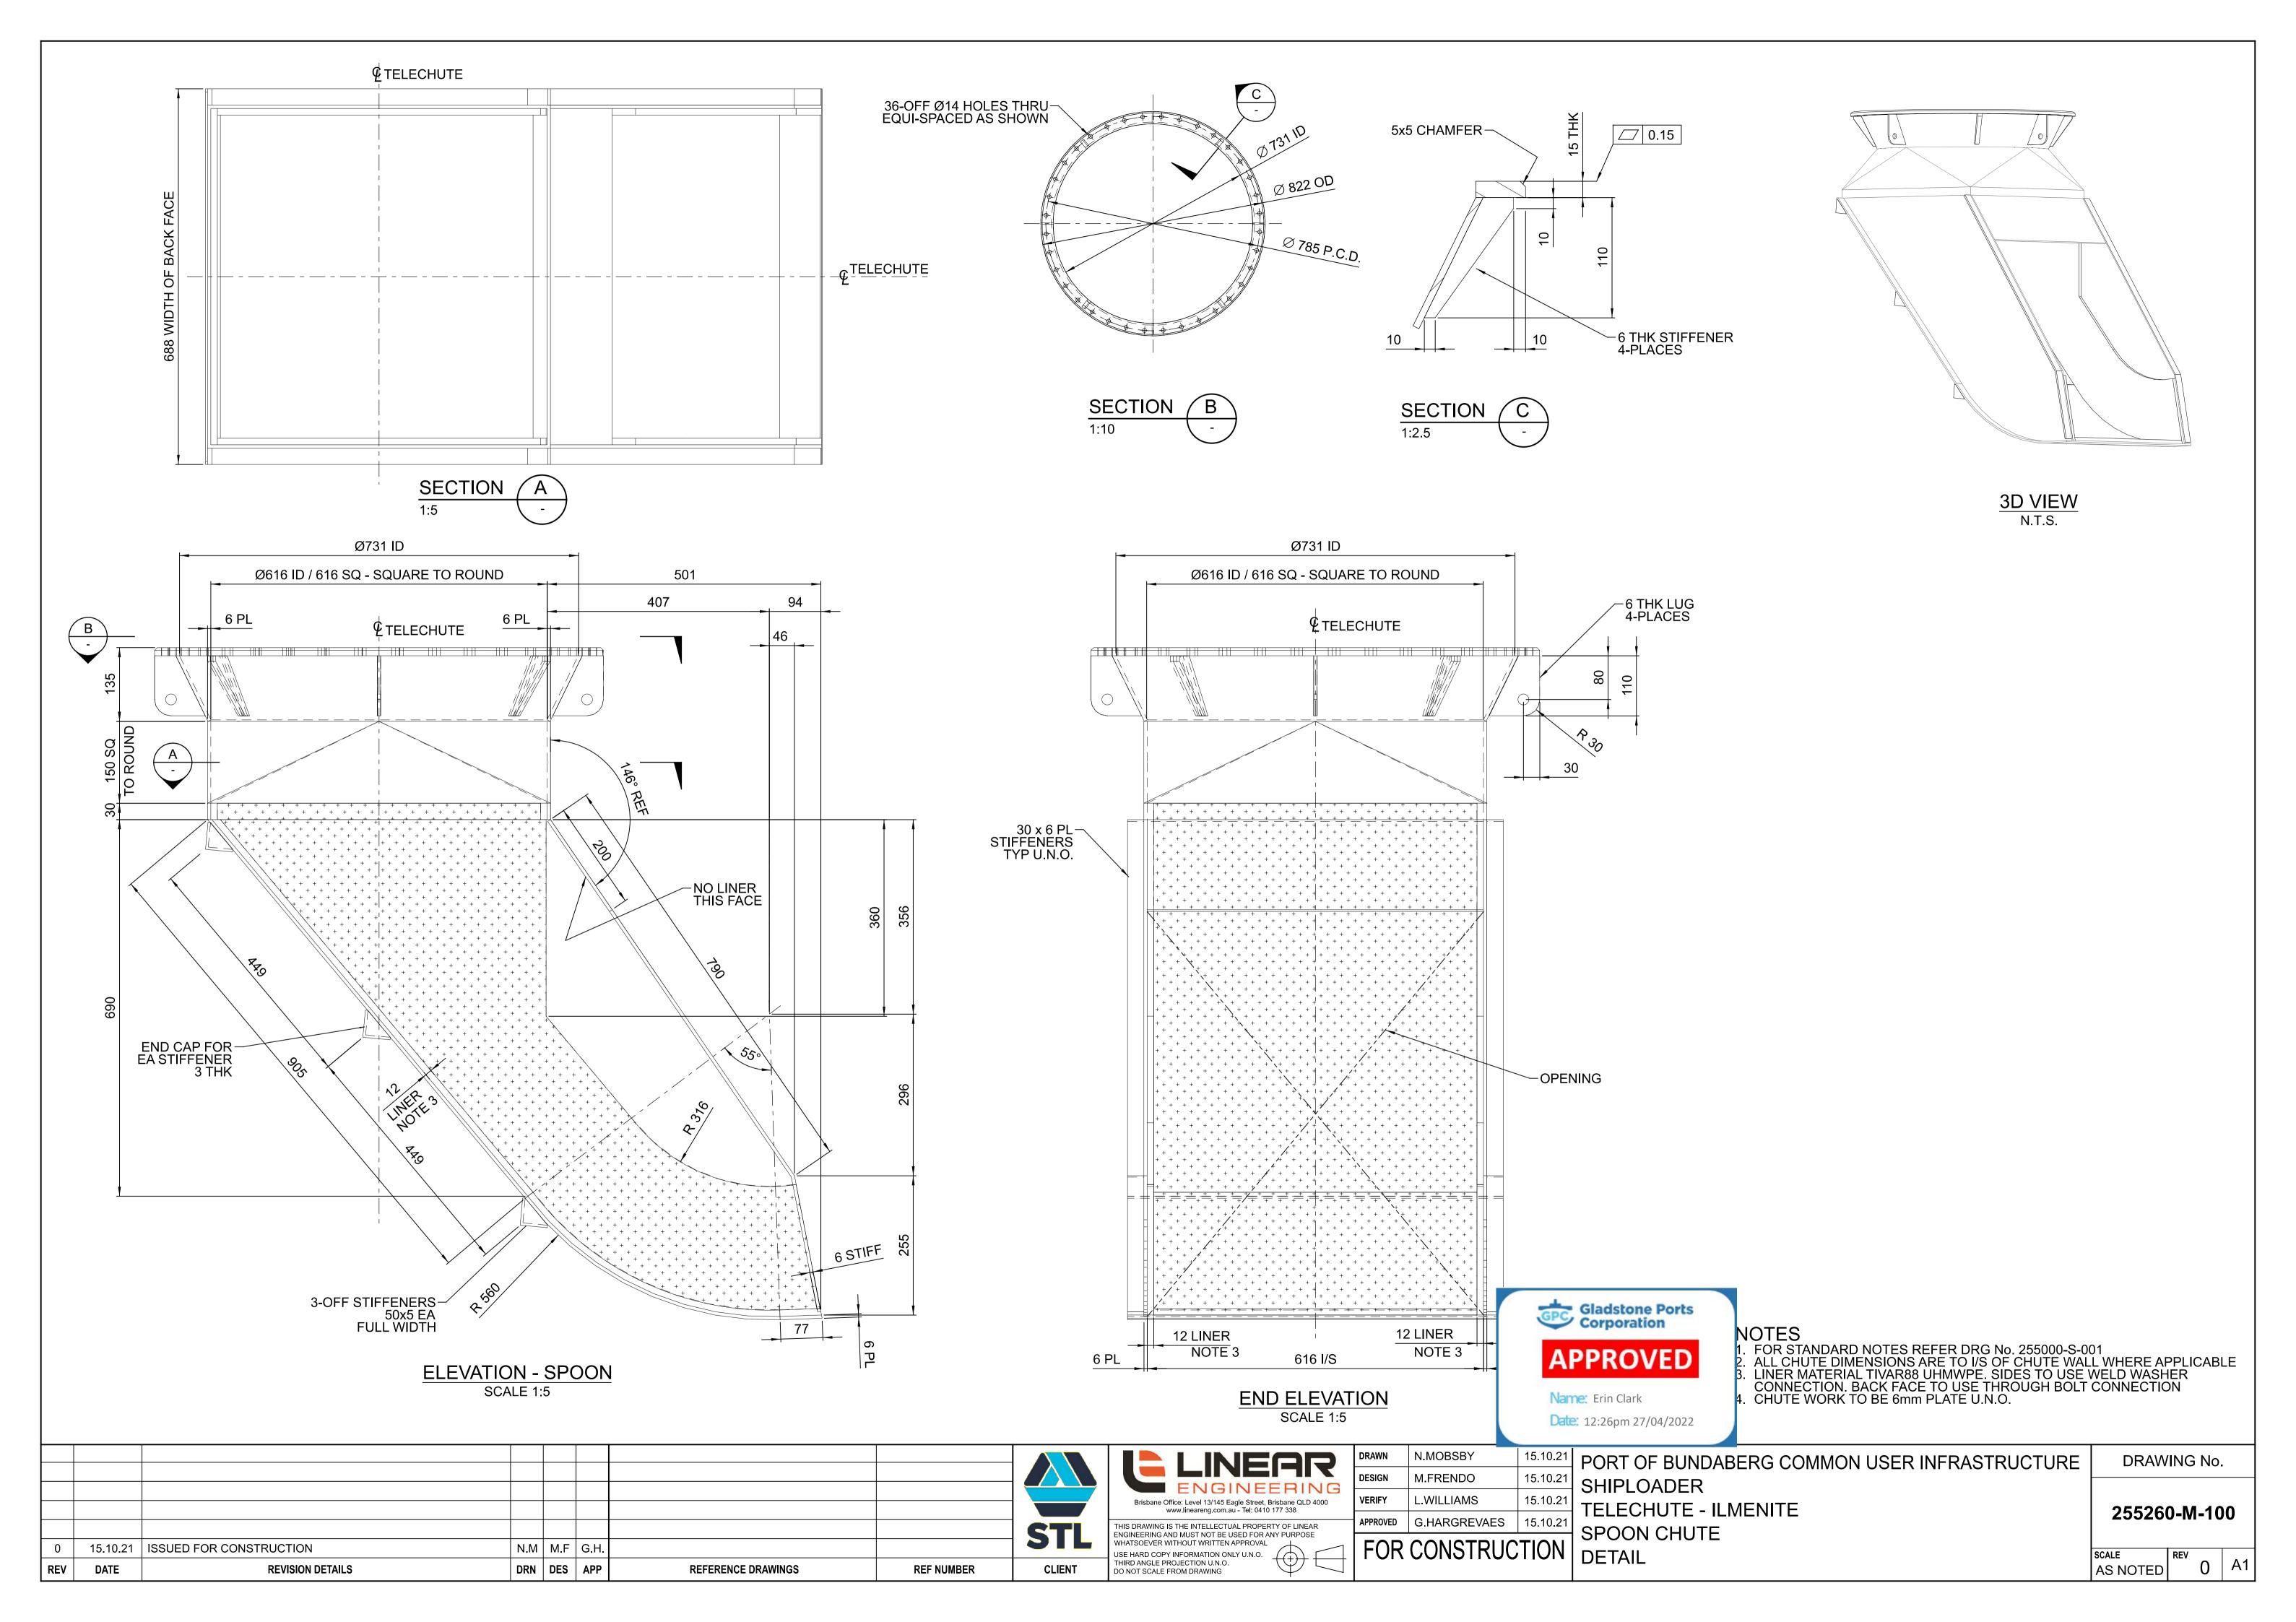

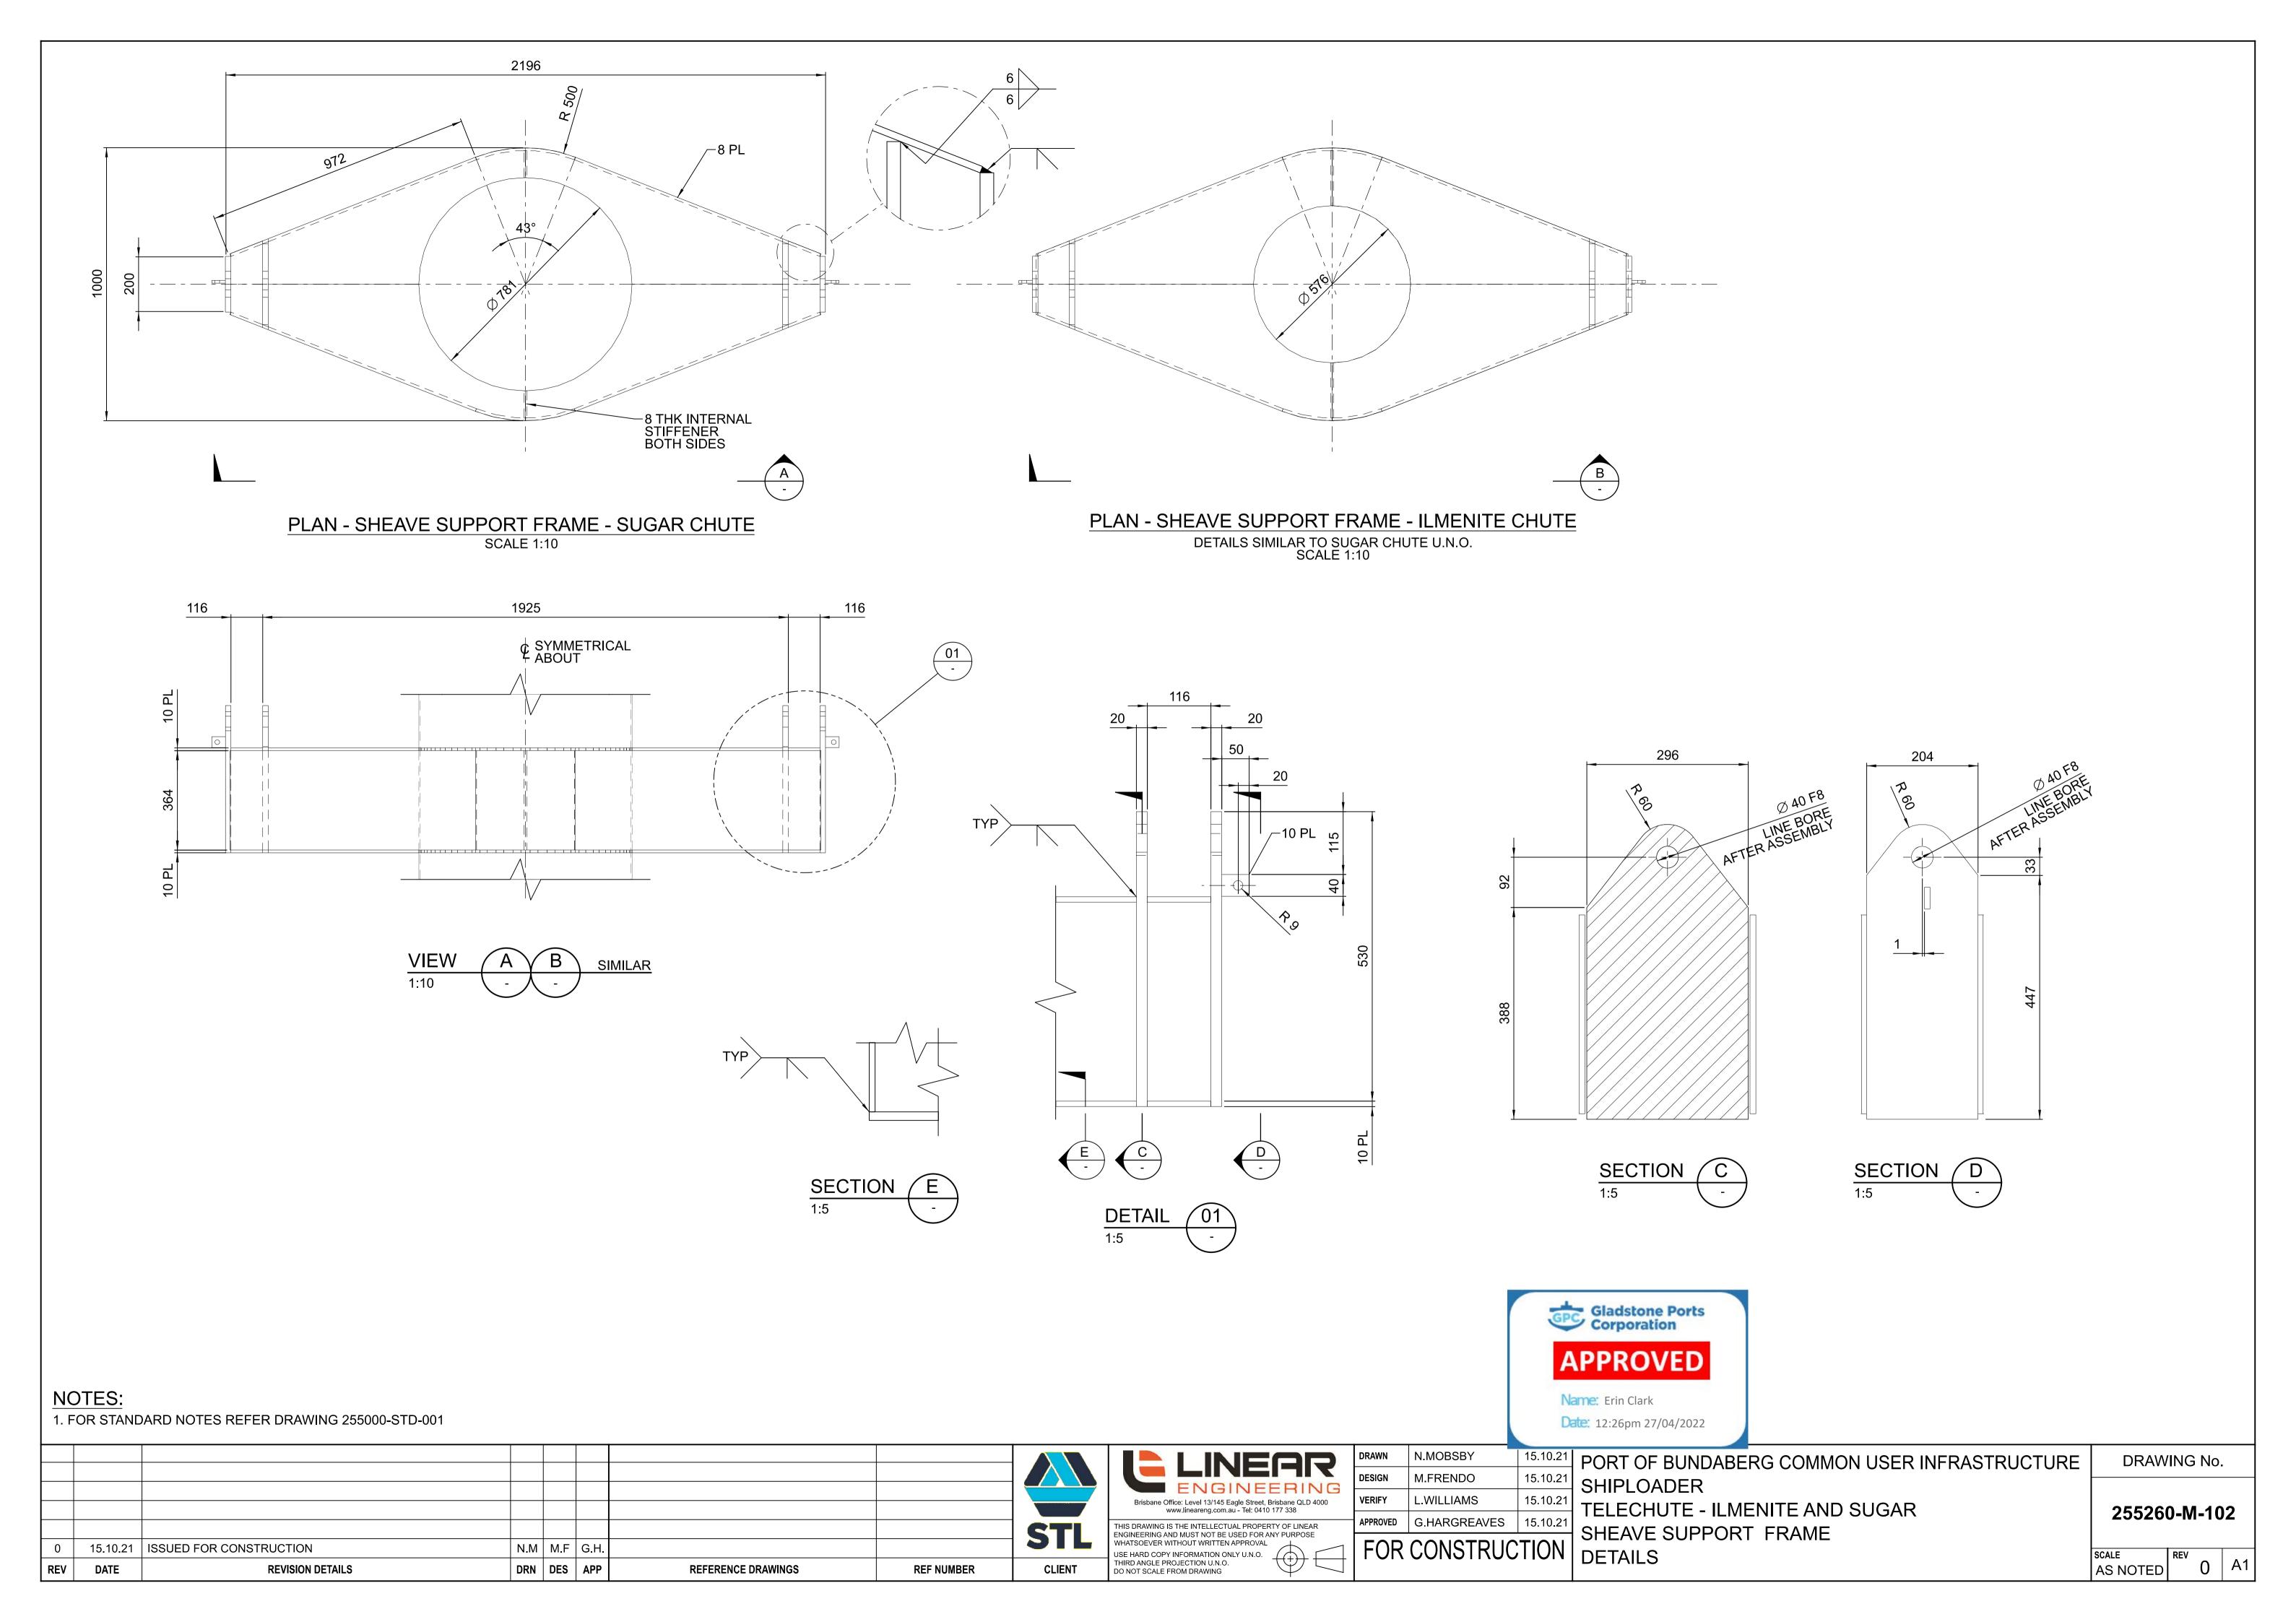

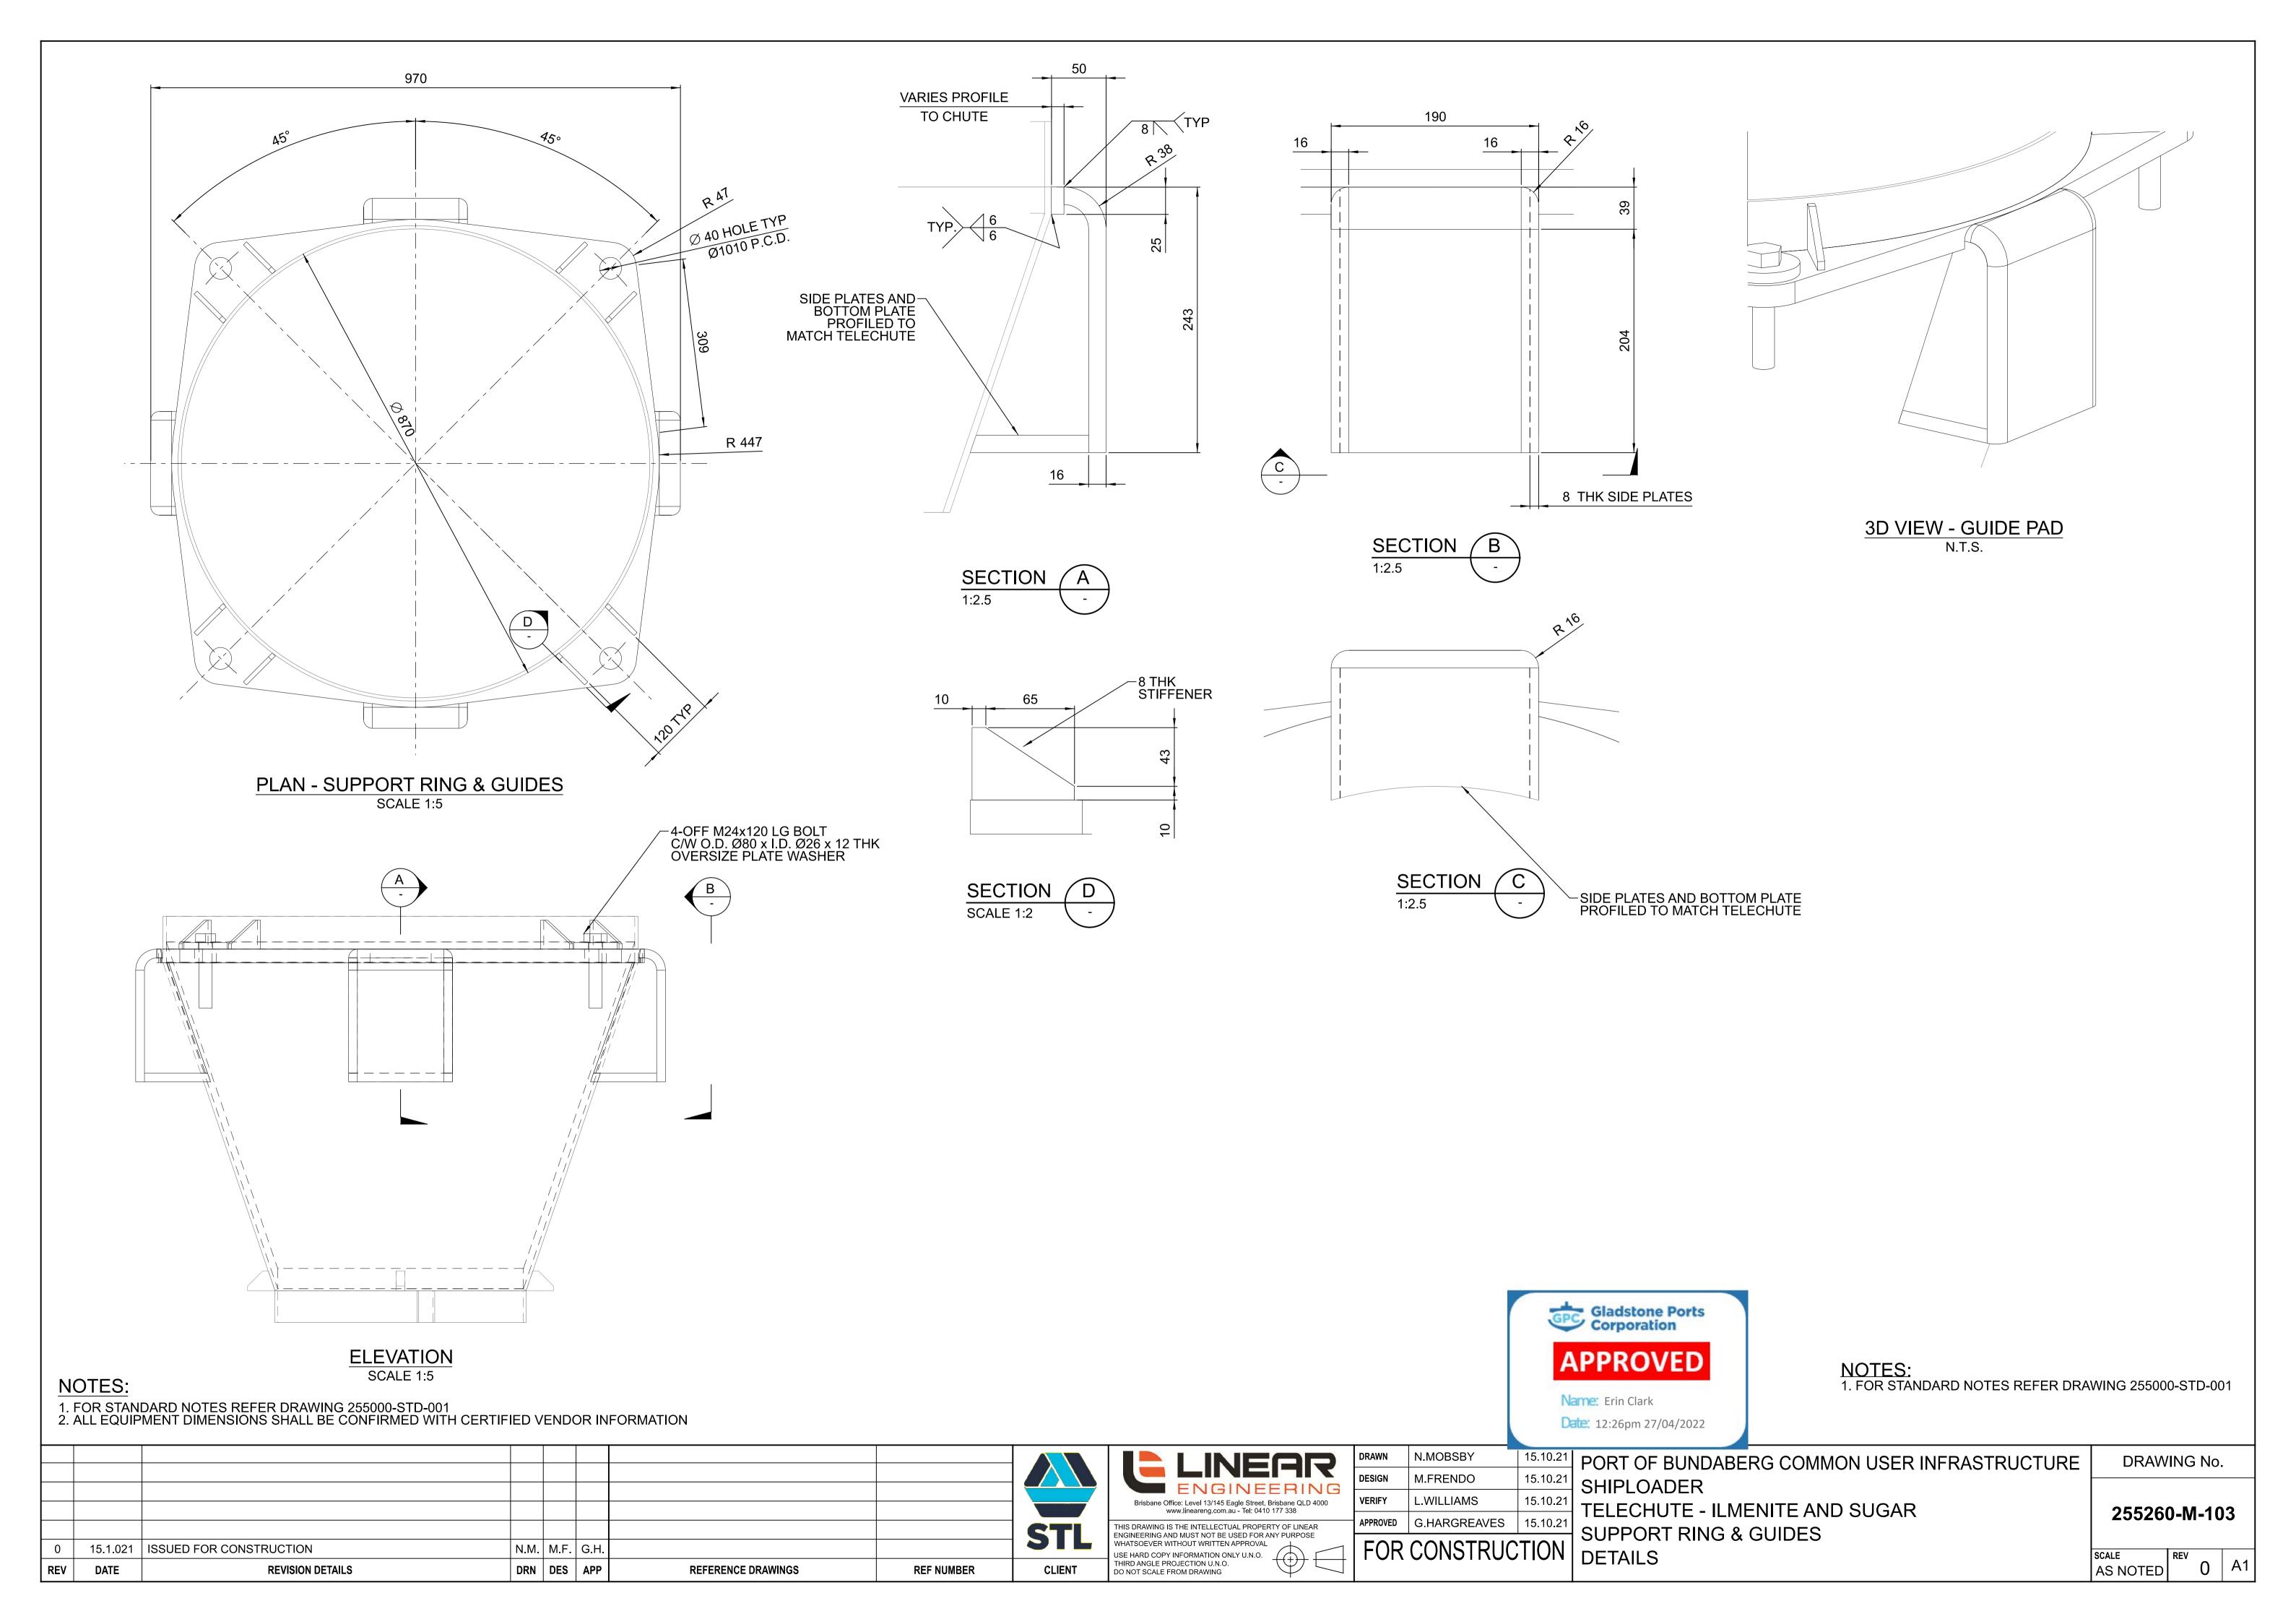

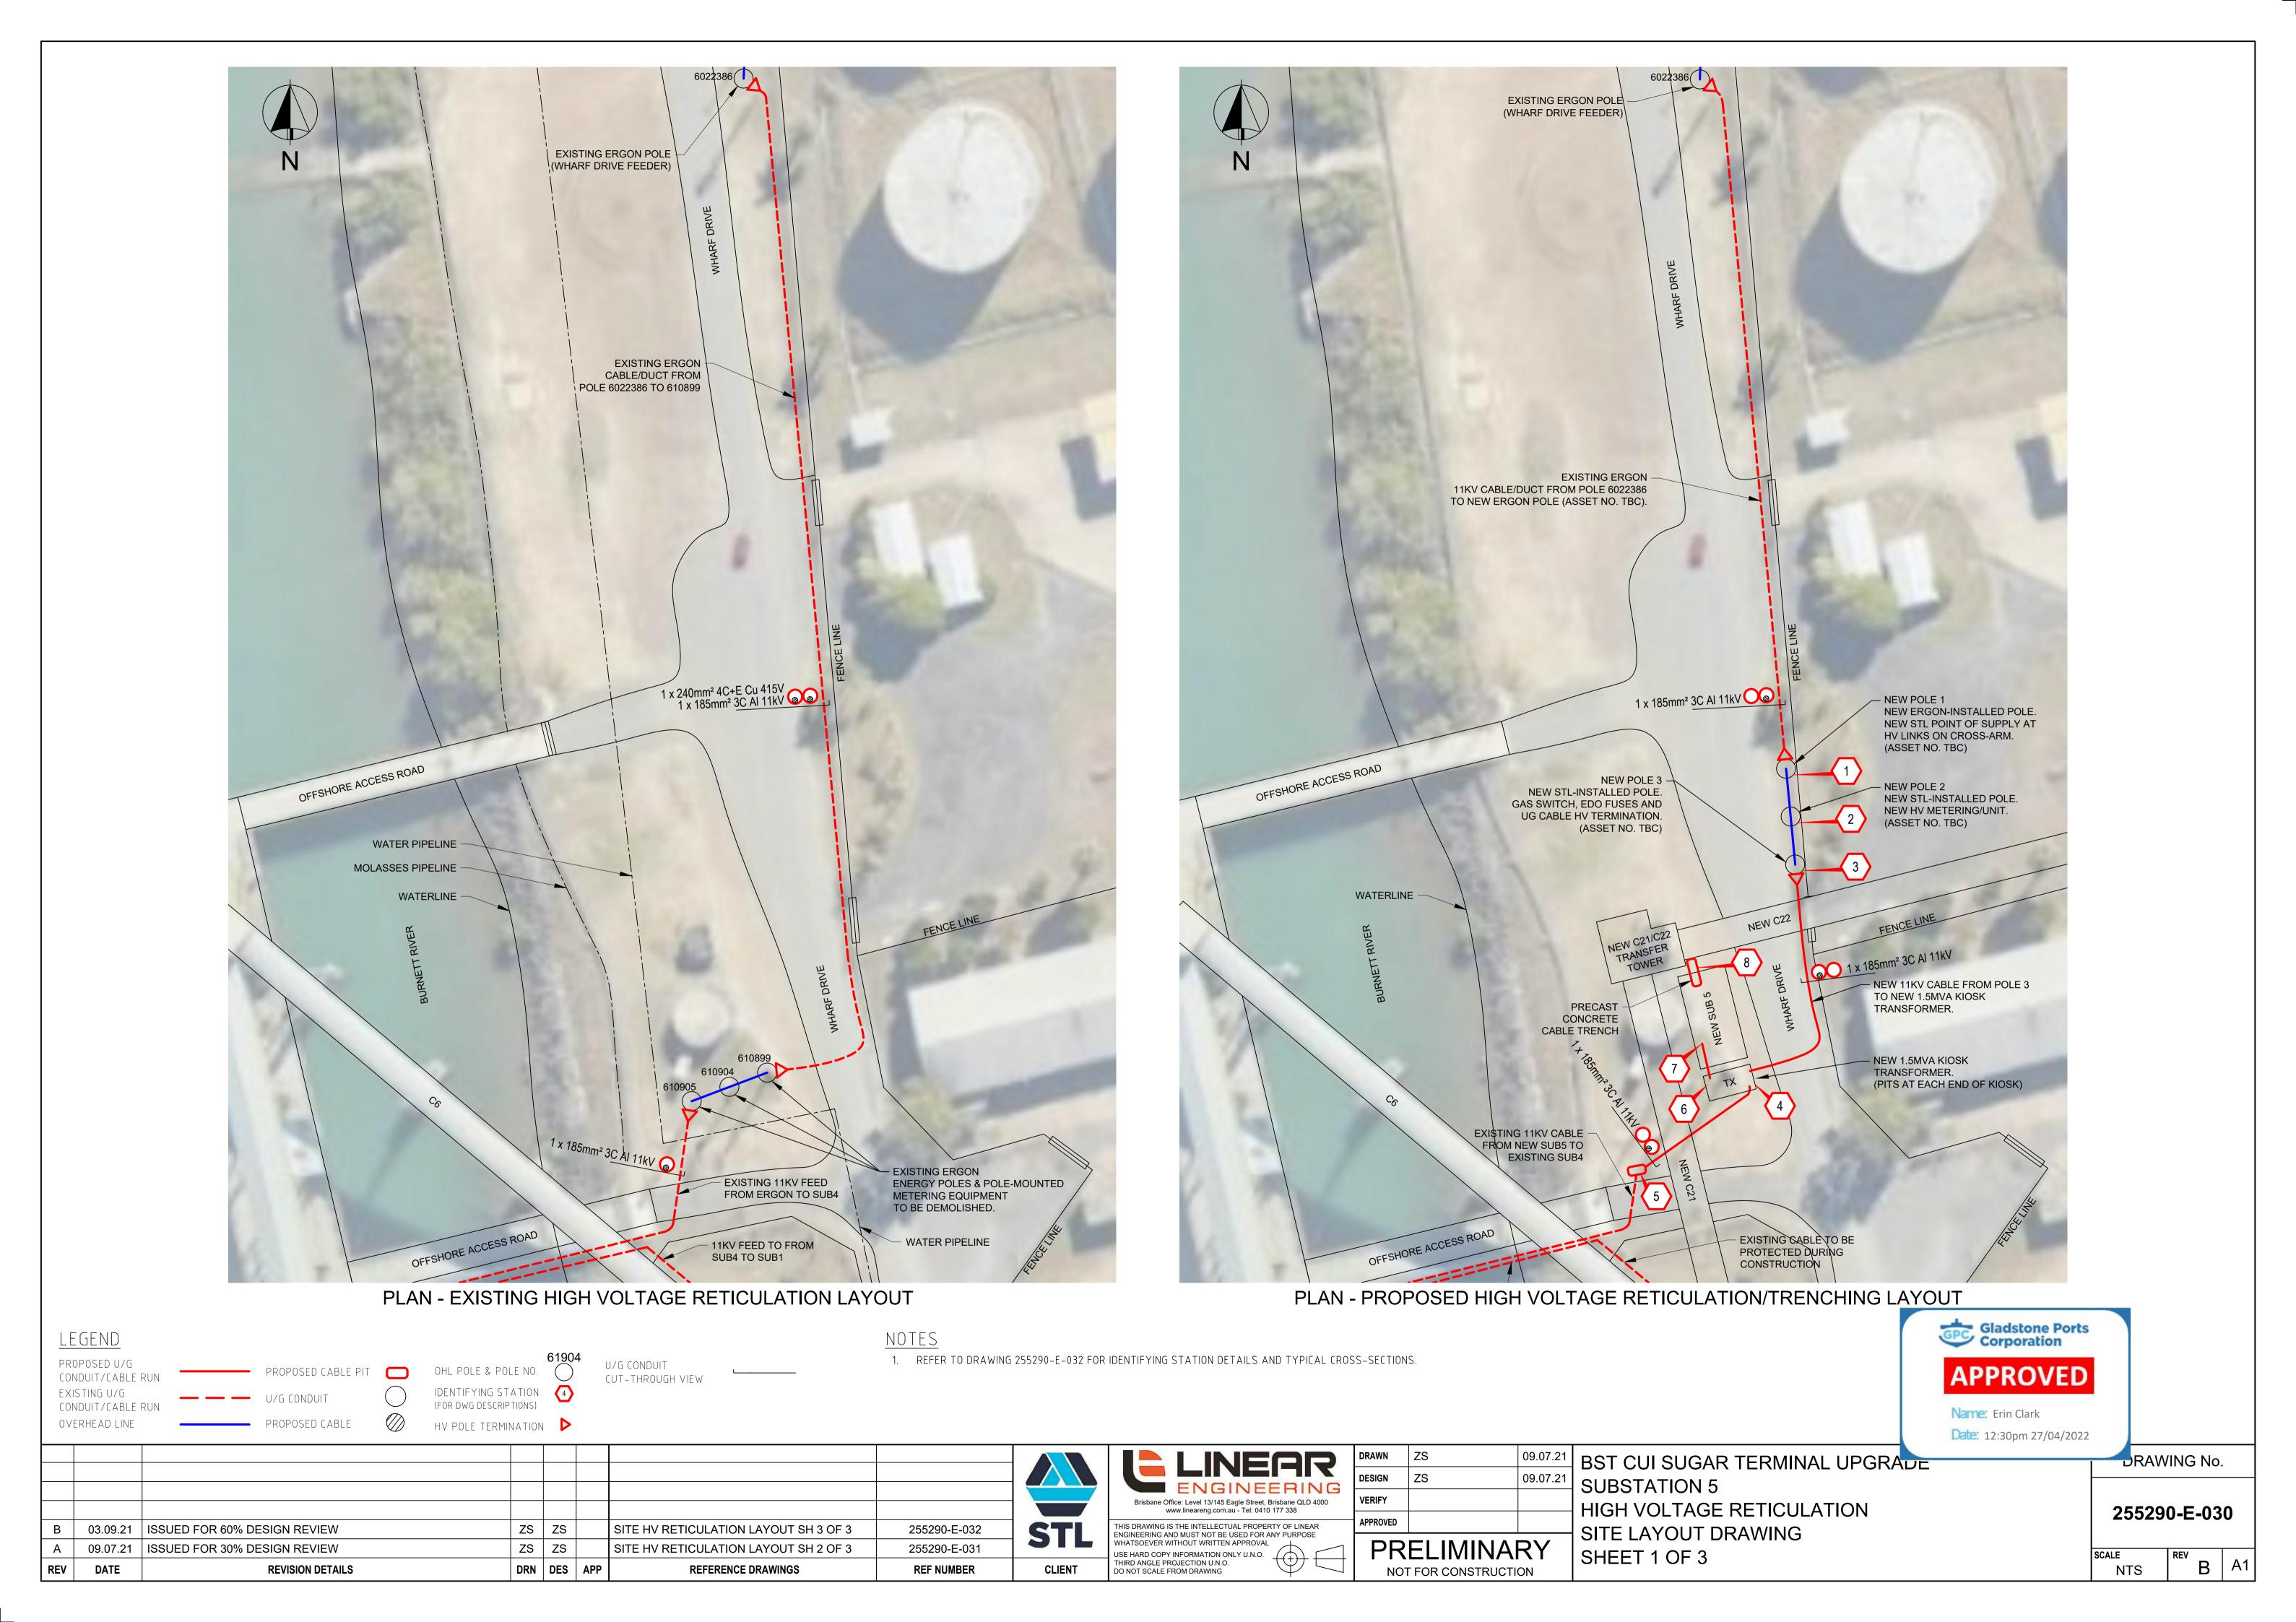



Extract of Appeal Provisions Attachment 3

Schedule 1 Appeals

section 229

1 Appeal rights and parties to appeals

- (1) Table 1 states the matters that may be appealed to—
 - (a) the P&E court; or
 - (b) a tribunal.
- (2) However, table 1 applies to a tribunal only if the matter involves—
 - (a) the refusal, or deemed refusal of a development application, for—
 - (i) a material change of use for a classified building; or
 - (ii) operational work associated with building work, a retaining wall, or a tennis court; or
 - (b) a provision of a development approval for-
 - a material change of use for a classified building;
 or
 - (ii) operational work associated with building work, a retaining wall, or a tennis court; or
 - (c) if a development permit was applied for—the decision to give a preliminary approval for—
 - (i) a material change of use for a classified building; or
 - (ii) operational work associated with building work, a retaining wall, or a tennis court; or
 - (d) a development condition if—
 - (i) the development approval is only for a material change of use that involves the use of a building classified under the Building Code as a class 2 building; and

- (ii) the building is, or is proposed to be, not more than 3 storeys; and
- (iii) the proposed development is for not more than 60 sole-occupancy units; or
- (e) a decision for, or a deemed refusal of, an extension application for a development approval that is only for a material change of use of a classified building; or
- (f) a decision for, or a deemed refusal of, a change application for a development approval that is only for a material change of use of a classified building; or
- (g) a matter under this Act, to the extent the matter relates to the Building Act, other than a matter under that Act that may or must be decided by the Queensland Building and Construction Commission; or
- (h) a decision to give an enforcement notice—
 - (i) in relation to a matter under paragraphs (a) to (g);or
 - (ii) under the Plumbing and Drainage Act 2018; or
- (i) an infrastructure charges notice; or
- (j) the refusal, or deemed refusal, of a conversion application; or
- (l) a matter prescribed by regulation.
- (3) Also, table 1 does not apply to a tribunal if the matter involves—
 - (a) for a matter in subsection (2)(a) to (d)—
 - (i) a development approval for which the development application required impact assessment; and
 - (ii) a development approval in relation to which the assessment manager received a properly made submission for the development application; or
 - (b) a provision of a development approval about the identification or inclusion, under a variation approval, of a matter for the development.

- (4) Table 2 states the matters that may be appealed only to the P&E Court.
- (5) Table 3 states the matters that may be appealed only to the tribunal.
- (6) In each table—
 - (a) column 1 states the appellant in the appeal; and
 - (b) column 2 states the respondent in the appeal; and
 - (c) column 3 states the co-respondent (if any) in the appeal; and
 - (d) column 4 states the co-respondents by election (if any) in the appeal.
- (7) If the chief executive receives a notice of appeal under section 230(3)(f), the chief executive may elect to be a co-respondent in the appeal.
- (8) In this section—

storey see the Building Code, part A1.1.

Table 1 Appeals to the P&E Court and, for certain matters, to a tribunal

1. Development applications

For a development application other than an excluded application, an appeal may be made against—

- (a) the refusal of all or part of the development application; or
- (b) the deemed refusal of the development application; or
- (c) a provision of the development approval; or
- (d) if a development permit was applied for—the decision to give a preliminary approval.

Appeals	to the P&E Court an	Table 1 d, for certain matters	, to a tribunal
Column 1 Appellant	Column 2 Respondent	Column 3 Co-respondent (if any)	Column 4 Co-respondent by election (if any)
The applicant	The assessment manager	If the appeal is about a concurrence agency's referral response—the concurrence agency	

2. Change applications

For a change application other than an excluded application, an appeal may be made against—

- (a) the responsible entity's decision on the change application; or
- (b) a deemed refusal of the change application.

Table 1 Appeals to the P&E Court and, for certain matters, to a tribunal					
Column 1 Appellant	Column 2 Respondent	Column 3 Co-respondent	Column 4 Co-respondent		
	*	(if any)	by election (if any)		
1 The applicant 2 If the responsible entity is the assessment manager—an affected entity that gave a pre-request notice or response notice	The responsible entity	If an affected entity starts the appeal—the applicant	1 A concurrence agency for the development application 2 If a chosen assessment manager is the respondent—the prescribed assessment manager 3 A private certifier for the development application 4 Any eligible advice agency for the change application 5 Any eligible submitter for the change application		

3. Extension applications

For an extension application other than an extension application called in by the Minister, an appeal may be made against—

- (a) the assessment manager's decision on the extension application; or
- (b) a deemed refusal of the extension application.

Table 1 Appeals to the P&E Court and, for certain matters, to a tribunal					
Column 1 Appellant	Column 2 Respondent	Column 3 Co-respondent (if any)	Column 4 Co-respondent by election (if any)		
1 The application of an extension agency, on than the concurrent agency than the concurrent agency than the concurrent agency of the application o	manager n a efusal ension on—a nce ther chief , for	If a concurrence agency starts the appeal—the applicant	If a chosen assessment manager is the respondent—the prescribed assessment manager		

4. Infrastructure charges notices

An appeal may be made against an infrastructure charges notice on 1 or more of the following grounds—

- (a) the notice involved an error relating to—
 - (i) the application of the relevant adopted charge; or

Examples of errors in applying an adopted charge—

- the incorrect application of gross floor area for a non-residential development
- applying an incorrect 'use category', under a regulation, to the development
- (ii) the working out of extra demand, for section 120; or
- (iii) an offset or refund; or
- (b) there was no decision about an offset or refund; or
- (c) if the infrastructure charges notice states a refund will be given—the timing for giving the refund; or
- (d) for an appeal to the P&E Court—the amount of the charge is so unreasonable that no reasonable relevant local government could have imposed the amount.

Appeals to	Ta the P&E Court and,	ble 1 for certain matters	s, to a tribunal
Column 1	Column 2	Column 3	Column 4
Appellant	Respondent	Co-respondent	Co-respondent
		(if any)	by election (if
			any)
The person given the infrastructure charges notice	The local government that gave the infrastructure charges notice		_
5. Conversion application	ations	5.9	
An appeal may be ma	ade against—		
(a) the refusal of a c	onversion application;	or	
(b) a deemed refusal	of a conversion applic	ation.	
Column 1	Column 2	Column 3	Column 4
Appellant	Respondent	Co-respondent	Co-respondent
		(if any)	by election (if
			any)
The applicant	The local government to which the conversion application was made		
6. Enforcement notice	ès		
An appeal may be ma	de against the decision	to give an enforcemen	nt notice.
Column 1	Column 2	Column 3	Column 4
Appellant	Respondent	Co-respondent	Co-respondent
		(if any)	by election (if
			any)
The person given the enforcement notice	The enforcement authority		If the enforcement authority is not the local government for the premises in relation to which the offence is alleged to have happened—the local government

Table 2 Appeals to the P&E Court only

1. Appeals from tribunal

An appeal may be made against a decision of a tribunal, other than a decision under section 252, on the ground of—

- (a) an error or mistake in law on the part of the tribunal; or
- (b) jurisdictional error.

Column 1	Column 2	Column 3	Column 4
Appellant	Respondent	Co-respondent	Co-respondent
		(if any)	by election (if
			any)
A party to the proceedings for the decision	The other party to the proceedings for the decision	_	_

2. Eligible submitter appeals

For a development application or change application other than an excluded application, an appeal may be made against the decision to approve the application, to the extent the decision relates to—

- (a) any part of the development application or change application that required impact assessment; or
- (b) a variation request.

Column 1	Column 2	Column 3	Column 4
Appellant	Respondent	Co-respondent (if any)	Co-respondent by election (if any)
1 For a development application—an eligible submitter for the development application 2 For a change application—an eligible submitter for the change application	 For a development application—the assessment manager For a change application—the responsible entity 	1 The applicant 2 If the appeal is about a concurrence agency's referral response—the concurrence agency	Another eligible submitter for the application

Table 2 Appeals to the P&E Court only

3. Eligible submitter and eligible advice agency appeals

For a development application or change application other than an excluded application, an appeal may be made against a provision of the development approval, or a failure to include a provision in the development approval, to the extent the matter relates to—

- (a) any part of the development application or change application that required impact assessment; or
- (b) a variation request.

Co	lumn 1	Column 2	Column 3	Column 4
	pellant	Respondent	Co-respondent (if any)	Co-respondent by election (if any)
2	For a development application—an eligible submitter for the development application For a change application—an eligible submitter for the change application An eligible	1 For a development application—the assessment manager 2 For a change application—the responsible entity	concurrence agency's referral response—the	Another eligible submitter for the application
12	advice agency for the development application or change application			

4. Compensation claims

An appeal may be made against-

- (a) a decision under section 32 about a compensation claim; or
- (b) a decision under section 265 about a claim for compensation; or
- (c) a deemed refusal of a claim under paragraph (a) or (b).

		ole 2 P&E Court only	
Column 1	Column 2	Column 3	Column 4
Appellant	Respondent	Co-respondent	Co-respondent
		(if any)	by election (if
			any)
A person dissatisfied with the decision	The local government to which the claim was made		
5. Registered premise	es	*	
An appeal may be ma	ade against a decision o	of the Minister under cl	napter 7, part 4.
Column 1	Column 2	Column 3	Column 4
Appellant	Respondent	Co-respondent	Co-respondent
10	n n	(if any)	by election (if
			any)
I A person given a decision notice about the decision	The Minister	-	If an owner or occupier starts the appeal—the owner of the registered
2 If the decision is			premises
to register			a ×
premises or renew the		**	
registration of			
premises—an owner or		7	
occupier of			ta .
premises in the affected area for			
the registered		≅ .	
premises who is dissatisfied with	=		
the decision			

6. Local laws

An appeal may be made against a decision of a local government, or conditions applied, under a local law about—

- (a) the use of premises, other than a use that is the natural and ordinary consequence of prohibited development; or
- (b) the erection of a building or other structure.

Schedule 1

Table 2 Appeals to the P&E Court only					
Column 1	Column 2	Column 3	Column 4		
Appellant	Respondent	Co-respondent	Co-respondent		
		(if any)	by election (if		
			any)		
A person who—	The local		_		
(a) applied for the decision; and	government	, ,			
(b) is dissatisfied with the decision or conditions.		10			

Table 3 Appeals to a tribunal only

1. Building advisory agency appeals

An appeal may be made against giving a development approval for building work to the extent the building work required code assessment against the building assessment provisions.

Column 1	Column 2	Column 3	Column 4
Appellant	Respondent	Co-respondent	Co-respondent
		(if any)	by election (if
			any)
A building advisory agency for the development application related to the approval	The assessment manager	The applicant	1 A concurrence agency for the development application related to the approval
			2 A private certifier for the development application related to the approval

Table 3 Appeals to a tribunal only

2. Inspection of building work

An appeal may be made against a decision of a building certifier or referral agency about the inspection of building work that is the subject of a building development approval under the Building Act.

Column 1	Column 2	Column 3	Column 4
Appellant	Respondent	Co-respondent	Co-respondent
		(if any)	by election (if
			any)
The applicant for the development approval	The person who made the decision	_	

- 3. Certain decisions under the Building Act and the *Plumbing and Drainage Act 2018*An appeal may be made against—
- (a) a decision under the Building Act, other than a decision made by the Queensland Building and Construction Commission, if an information notice about the decision was given or required to be given under that Act; or
- (b) a decision under the *Plumbing and Drainage Act 2018*, other than a decision made by the Queensland Building and Construction Commission, if an information notice about the decision was given or required to be given under that Act.

Column 1	Column 2	Column 3	Column 4
Appellant	Respondent	Co-respondent	Co-respondent
		(if any)	by election (if
			any)
A person who received, or was entitled to receive, an	The entity that made the decision		
information notice about the decision			

4. Local government failure to decide application under the Building Act

An appeal may be made against a local government's failure to decide an application under the Building Act within the period required under that Act.

Schedule 1

Table 3 Appeals to a tribunal only				
Column 1 Appellant	Column 2 Respondent	Column 3 Co-respondent (if any)	Column 4 Co-respondent by election (if any)	
A person who was entitled to receive notice of the decision	The local government to which the application was made			

5. Failure to make a decision about an application or other matter under the *Plumbing and Drainage Act 2018*

An appeal may be made against a failure to make a decision under the *Plumbing and Drainage Act 2018*, other than a failure by the Queensland Building and Construction Commission to make a decision, within the period required under that Act, if an information notice about the decision was required to be given under that Act.

Column 1	Column 2	Column 3	Column 4
Appellant	Respondent	Co-respondent	Co-respondent
		(if any)	by election (if
			any)
A person who was entitled to receive an information notice about the decision	The entity that failed to make the decision		