



Growth, prosperity, community.

#1887277: EC: TS
GPC Reference: RR2023/005/01

23 August 2023

Queensland Alumina Limited

Alison Green

Parsons Point

GLADSTONE QLD 4680

Email: greena@qal.com.au

Dear Ms Green

REFERRAL AGENCY RESPONSE WITH CONDITIONS - RR2023/005/01

(GIVEN UNDER S56 PLANNING ACT 2016)

1 Application Details

The development application was referred to the Gladstone Ports Corporation Limited under section 54 of the *Planning Act 2016* on **22 June 2023** and properly made on 22 August 2023.

Application Number:	RR2023/005/01
Applicant Name:	Queensland Alumina Limited
Applicant Contact Details:	Alison Green Queensland Alumina Limited Parsons Point GLADSTONE QLD 4680 Email: greena@qal.com.au
Approval Sought (Port Limits):	Operational Works on land below high-water mark and within the limits of a port.
Details of Proposed Development:	Operational Works on land below high-water mark and within the limits of a port – ash dam dust seawater intake and aboveground distribution system.
Location Street Address:	Parsons Point, Gladstone
Location Real Property Description:	Lot 348 CTN 1664
Land Owner:	Department of Resources
Priority Port Overlay	Port Industry and Commerce

1. Description Of Proposed Development

Sea water intake and above ground distribution system within port limits.

2. Referral Triggers

This development application was referred to the Gladstone Ports Corporation Limited under the following provisions of the *Planning Regulation 2017*:

Schedule 10, Part 13, Division 3, Table 1, Item 1

- a. Prescribed assessable development within limits of a port; and
- b. On land below high-water mark and within the limits of a port under the *Transport Infrastructure Act 1994*

3. Details of Referral Response

This development application has been assessed against port authority functions under the *Transport Infrastructure Act 1994*, Chapter 8, Part 3 as required in Schedule 10, Part 13, Division 3, Table 1, Item 4 of the *Planning Regulation 2017* and also matters referred to in section 22.

The Gladstone Ports Corporation Limited directs the Assessment Manager, under section 56(1)(b)(i) of the *Planning Act 2016* to give any development approval subject to development conditions stated in Attachment 1.

For further information please contact Trudi Smith, Planning Specialist on 07 4976 1314 or via email planning@gpcl.com.au.

Yours sincerely



Craig Haymes
Chief Executive Officer

Cc: Assessment Manager

Enc. Attachment 1: Referral Agency Conditions

Attachment 1: Referral Agency Conditions

PART 1: REFERRAL AGENCY CONDITIONS

In general the development proposal is in compliance with the requirements of *Transport Infrastructure Act 1994* (Chapter 8, Part 3). This Referral Agency response is subject to each the following conditions which are stated by GPC, the Referral Agency.

Part 1a: Approval sought under the *Transport Infrastructure Act 1994* (Chapter 8, Part 3).

General

1. Development must be carried out generally in accordance with the Approved plans, except where modified by conditions of this permit.
2. Unless otherwise stated, all conditions must be complied with and completed prior to the commencement of the development.
3. Where additional “approval” is required under these conditions by the Referral Agency (Gladstone Ports Corporation Limited) for drawings or documentation the Applicant must submit for review, amend to the satisfaction of, and obtain written approval from the Referral Agency.

Furthermore, the Referral Agency will require no less than 20 business days, unless otherwise conditioned by the Assessment Manager, to initially assess the drawings or documentation provided prior to the commencement of the development/works. Should further information be required for assessment, the Referral Agency will require a further 5 business days to complete the information request assessment and response.

4. The development must be appropriately designed and constructed to mitigate potential adverse impacts to port operations, services and facilities, and to maintain safe navigable access within Port Limits.

Engineering

5. Upon completion of the works, the Applicant must supply the Referral Agency with RPEQ certified “As Constructed” plans in electronic (CAD format) which illustrate all infrastructure and services installed on, under or over Port Limits associated with the activity unless otherwise approved in writing by the Referral Agency.
6. The Applicant must inform the Referral Agency of completion of works within Port Limits within 14 days of practical completion and certify that the site is fit for purpose.
7. Any site lighting used during construction / development should not negatively impact on the visibility of Navigational Aids utilised for the primary shipping channels within Port Limits nor illuminate a landward glare beyond the site boundary. Lighting must be reviewed during construction and use of the development with respect to navigation. Where an issue is identified or a validated complaint received, the Applicant must immediately rectify to the satisfaction of the Referral Agency.
8. Any material which is deposited or any debris which falls or is deposited within Port Limits during the construction of the approved development shall be removed by the applicant at their cost and expense. The applicant is to notify the Port Authority if any material or debris is deposited.

9. Upon completion of construction, the applicant shall provide the Referral Agency with written confirmation that the seabed is clear of foreign materials.
10. If, as a result of the works, or other cause attributable to the Applicant, any bank or tidal structure within Port Limits is displaced, the Applicant at its cost and expense shall restore the bank or structure to its former condition and take such other action as is necessary to ensure the stability of the bank or structure to the satisfaction of the Regional Harbour Master.

Construction Environmental Management Plan

11. Prior to construction works commencing on site an Construction Environmental Management Plan (CEMP) specific to this application and its associated works must be submitted to the Referral Agency (GPC) for approval, that ensures:
 - (a) Environmental risks, including but not limited to, water, air, noise, land, biodiversity, waste and community are identified, managed and continually assessed in relation to the construction activity;
 - (b) That staff are trained, aware and competency assessed of their obligations under the CEMP, a copy of which must be kept and available on site at all times;
 - (c) That reviews of environmental performance are undertaken at least annually; and
 - (d) Any amendments to the CEMP are to be submitted to GPC for review and approval.
 - (e) Once approved by the Referral Agency (GPC), the construction activity must be carried out in accordance with this CEMP.

Note: GPC has a guideline for the development of environmental management plans that may be utilised in meeting the requirements of this condition.

Incident notification

12. Gladstone Ports Corporation's Environmental Hotline (07) 4976 1617 must be notified of the occurrence of any:
 - (a) release/spill of contaminants (e.g. fuels/chemicals/sewerage) greater than 20L to land;
 - (b) release/spill of contaminants (e.g. fuels/chemicals/sewerage) of any amount to water;
 - (c) environmental complaints received by the holder of this application;
 - (d) non-compliance with conditions of this application or any other environmental approval obtained in relation to the approved activity

Vessel Management (applicable where vessels are used)

13. Prior to works within Port Limits commencing, supply to the Referral Agency a Marine Execution Plan that has been approved by the Regional Harbour Master, where relevant.
14. Prior to works within Port Limits commencing, the Applicant or their Contractor must supply to the Referral Agency for review and approval an Emergency Management Plan for works within Port Limits for all potential incidents e.g. contaminant spill, riverine flood, adverse weather etc.
15. Refuelling of vessels used in construction must be carried out by a licenced bunkers provider only on site, or off site at a licenced refuelling facility.

16. Spillage of any material e.g. sediment, wastes, contaminants etc. must be cleaned immediately. Such spillage must not be cleaned up by hosing, sweeping or otherwise releasing such materials to any waters.
17. All waste generated on vessels in carrying out the works must be disposed of at a proper and appropriate facility.
18. Environmental incident notification must be included in any Management Plans for the works within Port Limits.


Part 1b Referral Agency Advice Notes

- a. Where the Applicant is required to submit further documentation to the Referral Agency, this is to be directed to the Planning section at planning@gpcl.com.au, including reference to the allocated referral response number RR2023/005/01.
- b. All development should proceed in accordance with the duty of care guidelines under the *Aboriginal Cultural Heritage Act 2003*. Penalties may apply where duty of care under that Act has been breached.
- c. The *Environmental Protection Act 1994* states that a person must not carry out any activity that causes, or is likely to cause, environmental harm unless the person takes all reasonable and practicable measures to prevent or minimise the harm. Environmental harm includes environmental nuisance. In this regard persons and entities, involved in the civil, earthworks, construction, and operational phases of this development, are to adhere to their 'general environmental duty' to minimise the risk of causing environmental harm.

Attachment 2. Approved Plans and Specifications

Gladstone Ports Corporation Limited


T: +61 7 4976 1333 • Fax: +61 7 4972 3045 • 40 Goondoon St/PO Box 259, Gladstone QLD, 4680, AUSTRALIA • www.gpcl.com.au
ACN 131 965 896 ABN 96 263 788 242

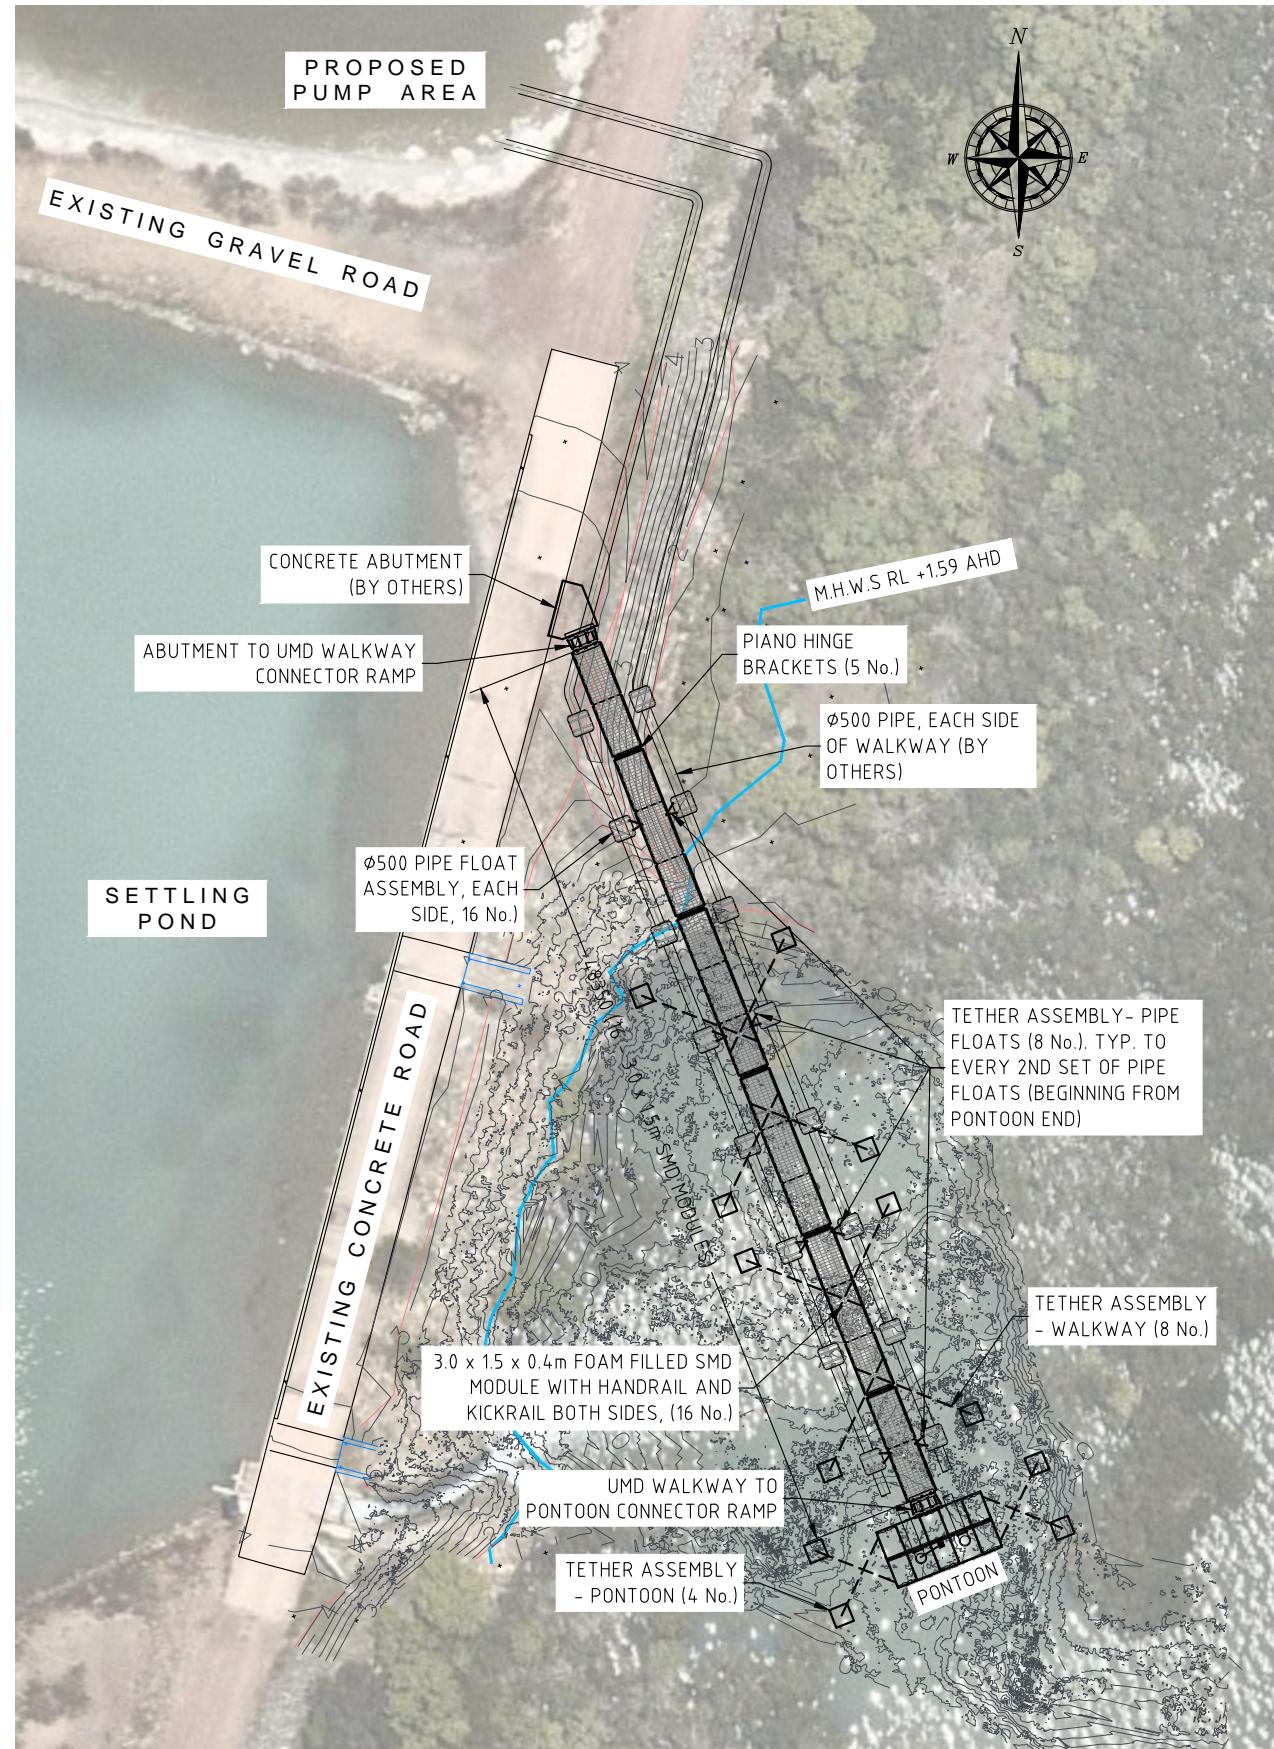


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TYPICAL SECTION SCALE 1 : 30



ELEVATION (INDICATIVE ONLY) SCALE 1 : 250

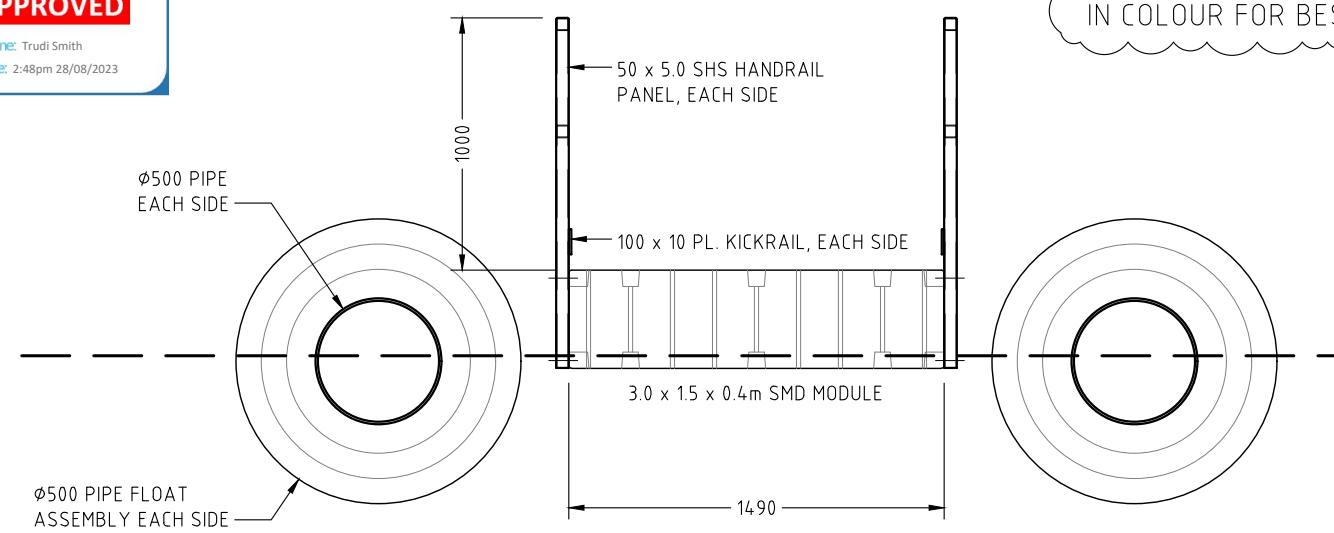NOTES:

- ALL CABLES TO BE 12mm 7x19 STAINLESS STEEL U.N.O. (WITH MIN. 100kN MBS)
- THE SUPERIOR TETHER SYSTEM MUST BE USED WITH EACH CABLE AND HEIGHT OF THE PONTOON SYSTEM IS ALWAYS REQUIRED TO BE MAINTAINED BASED ON THE ELASTIC LIMIT OF THE SUPERIOR TETHER SYSTEM, WHICH IS DESIGNED BY OTHERS.
- THE LENGTH OF THE CABLE VARIES ACCORDING TO WATER DEPTH.
- THE MAXIMUM LENGTH OF THE PONTOON WALKWAY SYSTEM IS 49.2m.
- THE FREEBOARD OF THE PONTOON WALKWAY NEEDS TO BE MAINTAINED AT 355mm.
- THE MAX. WIDTH OF THE PONTOON WALKWAY MUST BE 1.5m.
- STABILITY AND STRENGTH OF THE UMD MODULES CERTIFIED BY SUPERIOR JETTIES.
- THE DESIGN LIFE IS 20 YEARS.
- THE MAX. WAVE HEIGHT IS 0.3m AS PER AS3962.
- THE MAX. CURRENT VELOCITY IS 1m/s AS PER AS3962.
- ALL THE ALUMINIUM MUST BE 6005-T5 AND BOLTS MUST BE 316 MARINE GRADE WITH CLASS 80.
- ALL DISSIMILAR METALS ARE REQUIRED TO BE SEPARATED.
- MAXIMUM 2 PEOPLE ON WALKWAY AT ANY TIME.
- MAXIMUM WEIGHT OF DAVIT IS 60kg
- MAXIMUM OPERATIONAL WEIGHT OF DAVIT IS 300kg.
- MAXIMUM REACH OF DAVIT FROM ITS BASE IS 1.3m.
- ALL WALKWAY CONNECTIONS MUST HAVE M12-316 (CLASS 80) COMPONENTS / BOLTS U.N.O
- ALL STEEL MEMBERS / COMPONENTS MUST BE GALVANIZED AS PER AUSTRALIAN STANDARDS AND ALL STAINLESS STEEL MEMBERS MUST BE 316
- MAXIMUM 2 PEOPLE ON PUMP PONTOON AT ANY TIME.
- FRP DECKING SYSTEM OF THE PUMP PONTOON IS 38x38 STANDARD INDUSTRIAL ENVIROGRATE WITH 25mm DEPTH AND 12.9 kg/SQM MASS

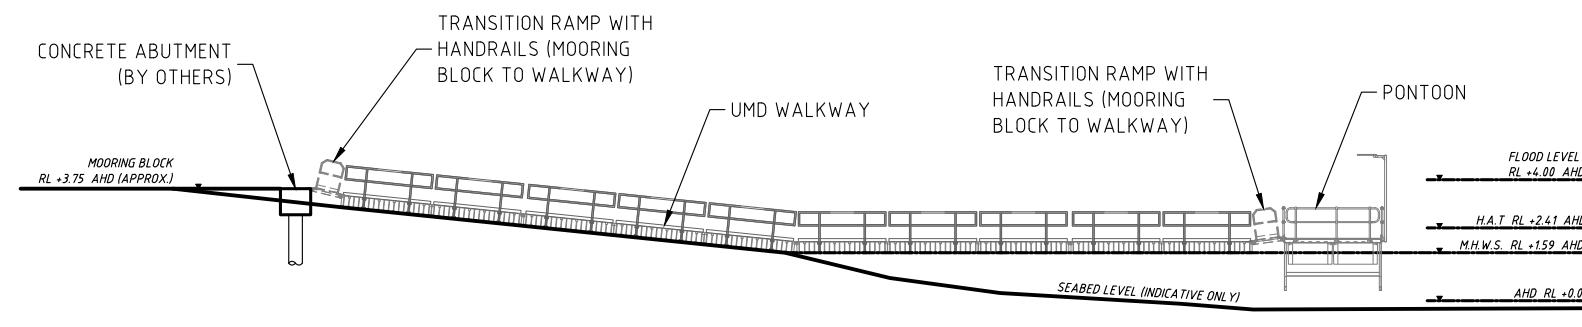No.	DATE	REVISION	DRAWN BY
A	24.11.22	BACKGROUND IMAGE REVISED	S.D.
B	31.05.23	RPEQ ENGINEER COMMENTS INCORPORATED	S.D.


KK BEST COST-EFFECTIVE SOLUTIONS FOR BUILDINGS, BRIDGES AND MARINAS
K and K Consulting Engineers Pty Ltd
BTP (Brisbane Technology Park)
1 Cluny Road, C1
Eight Mile Plains QLD 4113
Email: hp@knkengineers.com.au
Phone: (07) 3195 5692
Web: www.knkengineers.com.au

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Mail Address: P.O. Box 202 Labrador 4215
Ph: (07) 5594 8200
Email: info@superiorjetties.com


DATE
06/06/2022
DRAWING NO.
19441-D01
REVISION NO.
B

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CLIENT
ADDRESS
QAL
QAL WALKWAY
GLADSTONE
DRAWN BY
S.D.
DESIGNED
M.W.
CHECKED BY
PAPER SIZE
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SCALE
AS NOTED


CERTIFIED
Himenshu Nalindrajith
Praveen Moragaspitiya
RPEQ: 16451

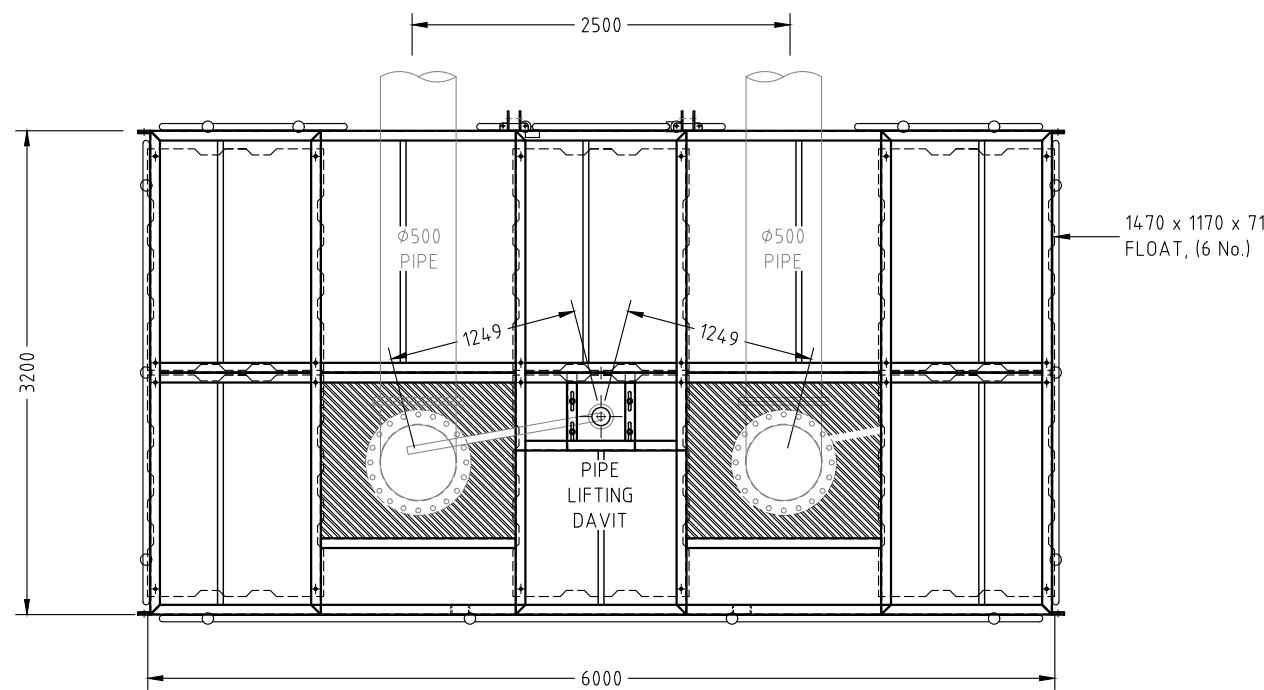


PLAN SCALE 1 : 50

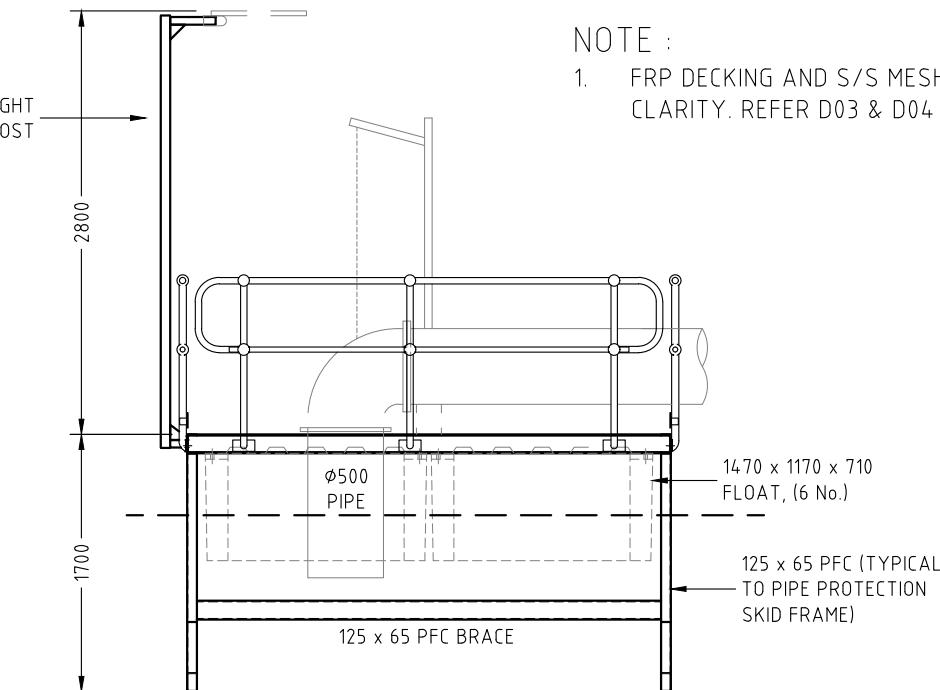

SIDE ELEVATION SCALE 1 : 50

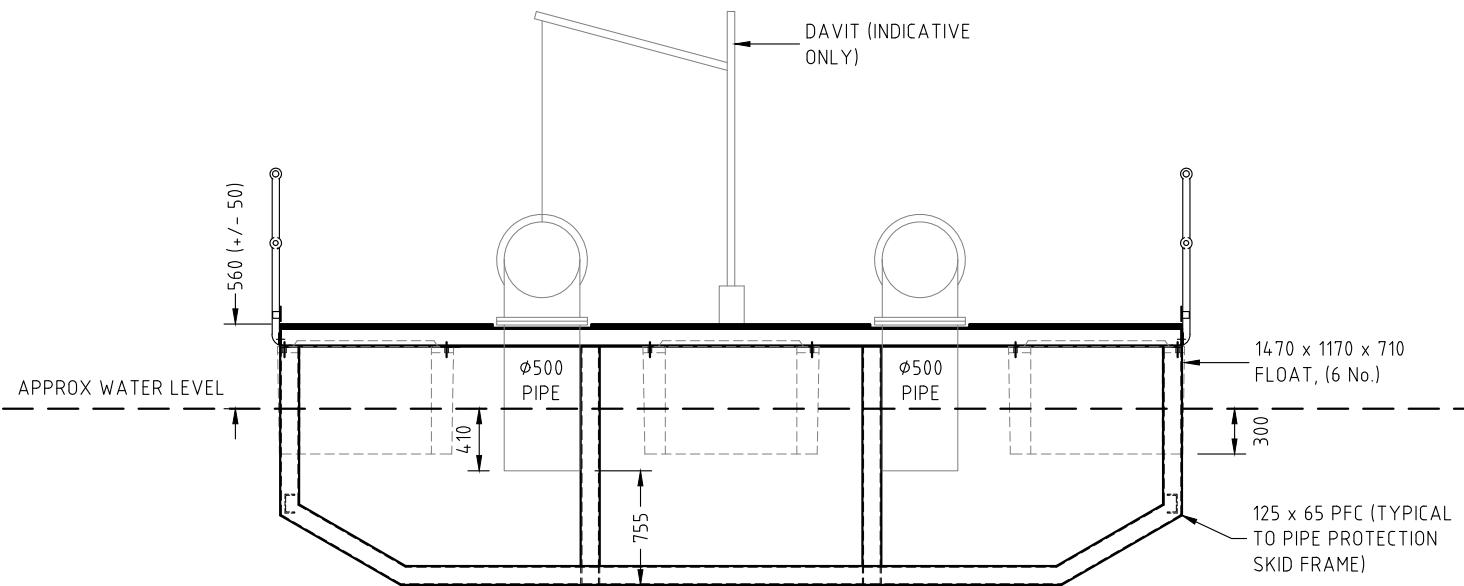

TYPICAL SECTION SCALE 1 : 50

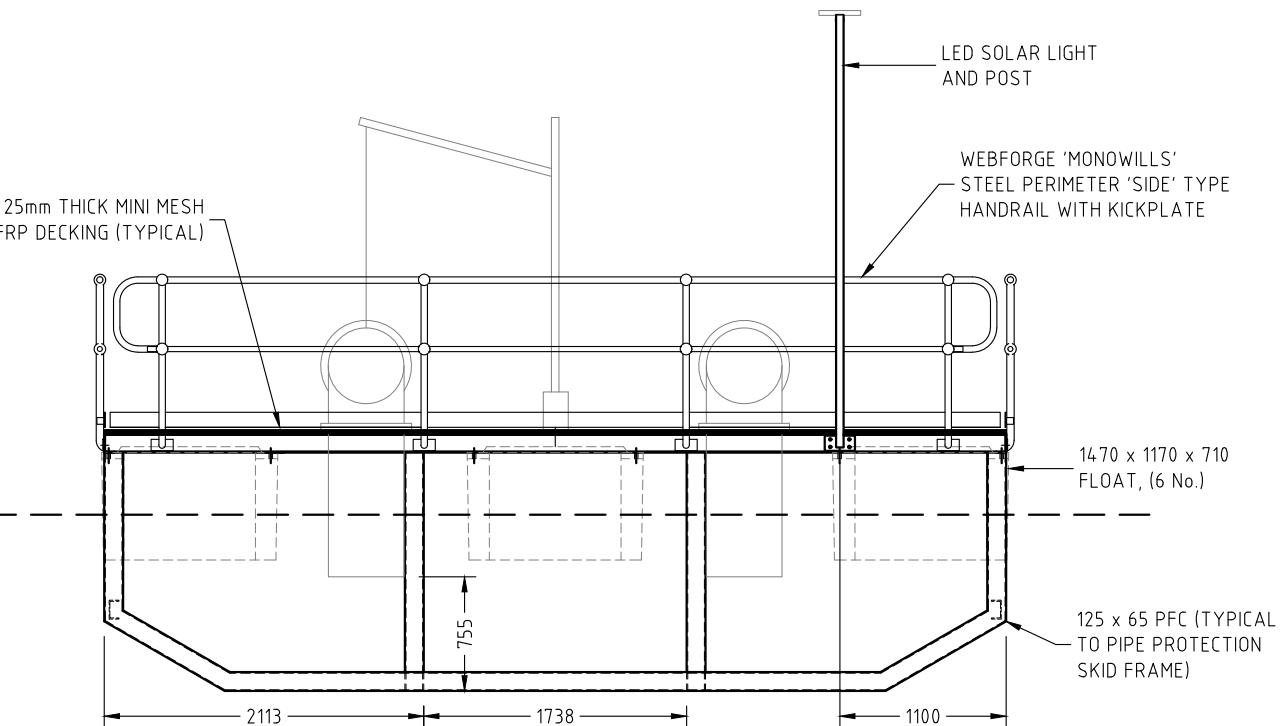

FRONT ELEVATION SCALE 1 : 50



NO.	DATE	REVISION	DRAWN BY

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BTP (Brisbane Technology Park)
1 Clunies Ross Ct,
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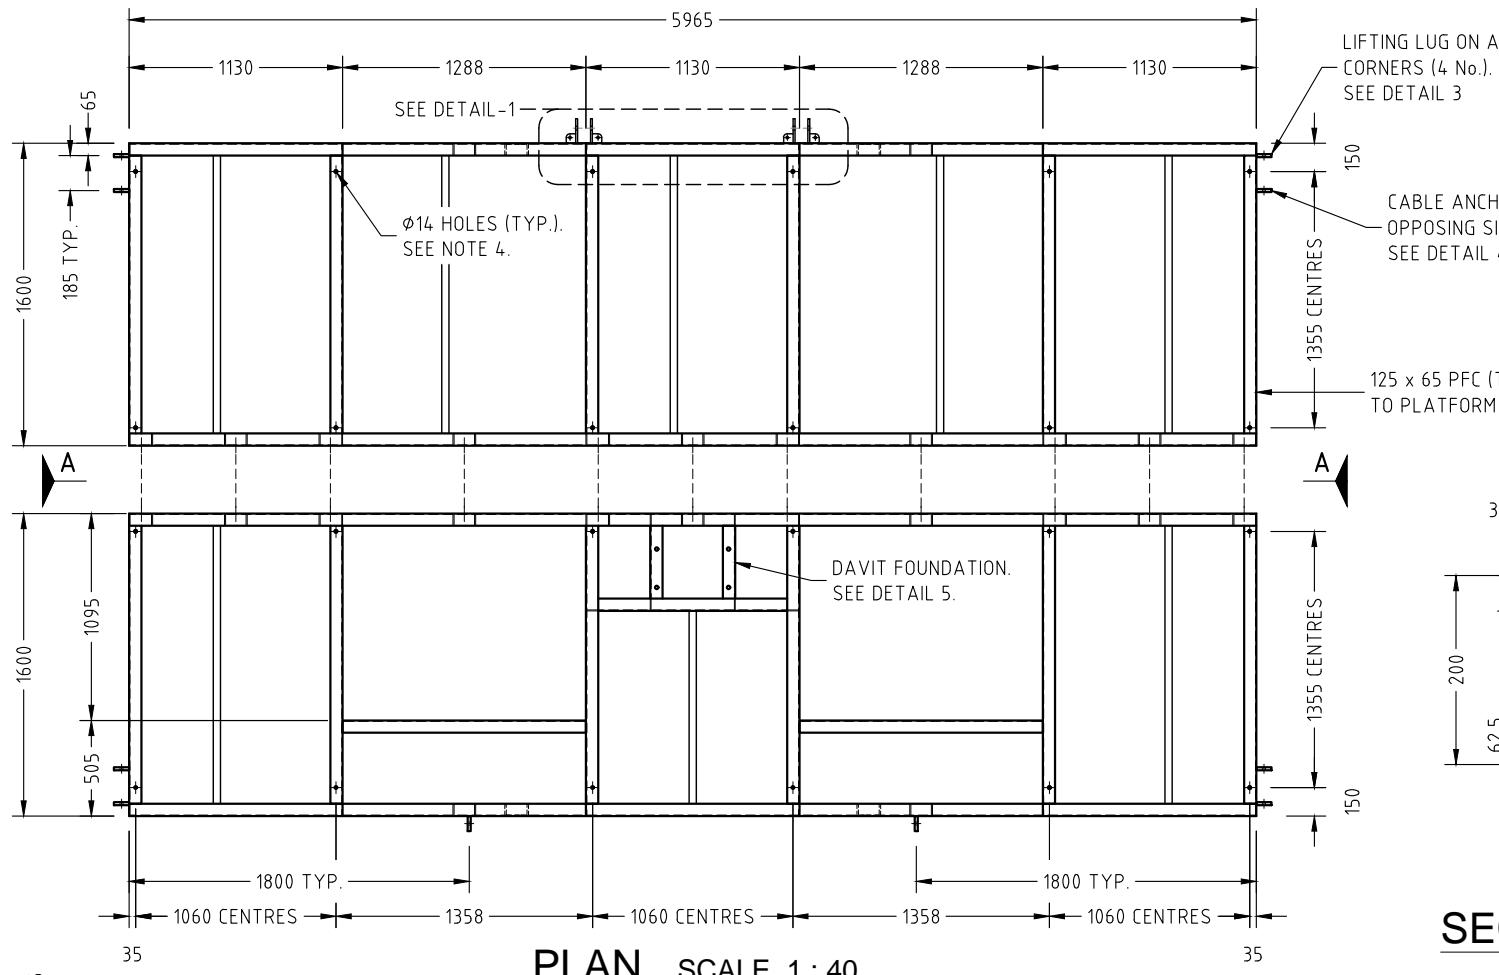
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Ph: (07) 5594 8200
Email: info@superiorjetties.com

DATE
06/06/2022
DRAWING NO.
19441-D02
REVISION NO.

PROJECT
PROPOSED PONTOON AND WALKWAY PONTOON GENERAL ARRANGEMENT
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CLIENT
QAL
ADDRESS
QAL WALKWAY GLADSTONE
DRAWN BY
S.D. DESIGNED
M.W. CHECKED BY
PAPER SIZE
A3 SCALE
AS NOTED

CERTIFIED
Himanshu Nalindrajith
Praveen Moragaspitiya
RPEQ: 16451





PLAN SCALE 1 : 40

NOTE :


- ALL PONTOONS MEMBER SHALL BE STEEL 125 PFC
- ALL MEMBERS TO BE WELDED WITH CONTINUOUS 6mm FILLET, TYP. U.N.O.
- ALL HOLE CENTRES TO BE VERIFIED AGAINST FLOAT MODULE FIXING HOLES PRIOR TO DRILLING.
- ALL FASTENERS TO BE 316 ST/S AND SECURED WITH LOCTITE THREADLOCKING ADHESIVE (OR SIMILAR).
- ALL DISSIMILAR METALS MUST BE SEPARATED USING ISOLATING WASHERS OR SLEEVES.
- FRP DECKING SYSTEM OF THE PUMP PONTOON IS 38x38 STANDARD INDUSTRIAL ENVIROGRATE WITH 25mm DEPTH AND 12.9 kg/SQM MASS

FRAME MASS = 1785kg

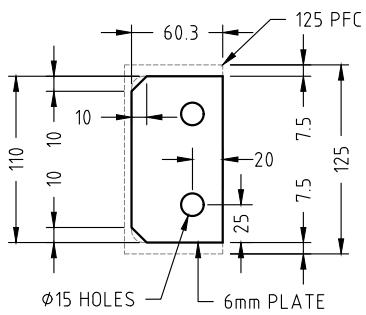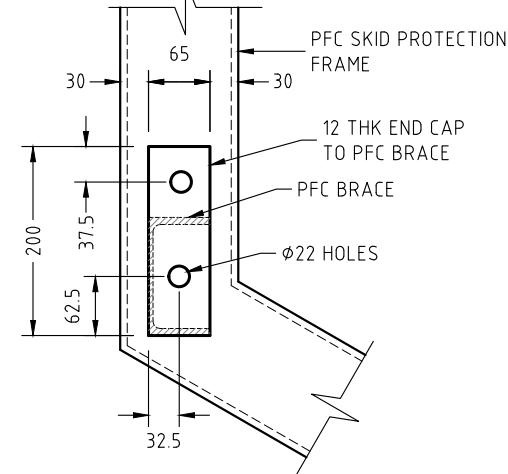


SECTION B-B SCALE 1 : 8


TYP. 6mm WEB STIFFENER
SCALE 1 : 5

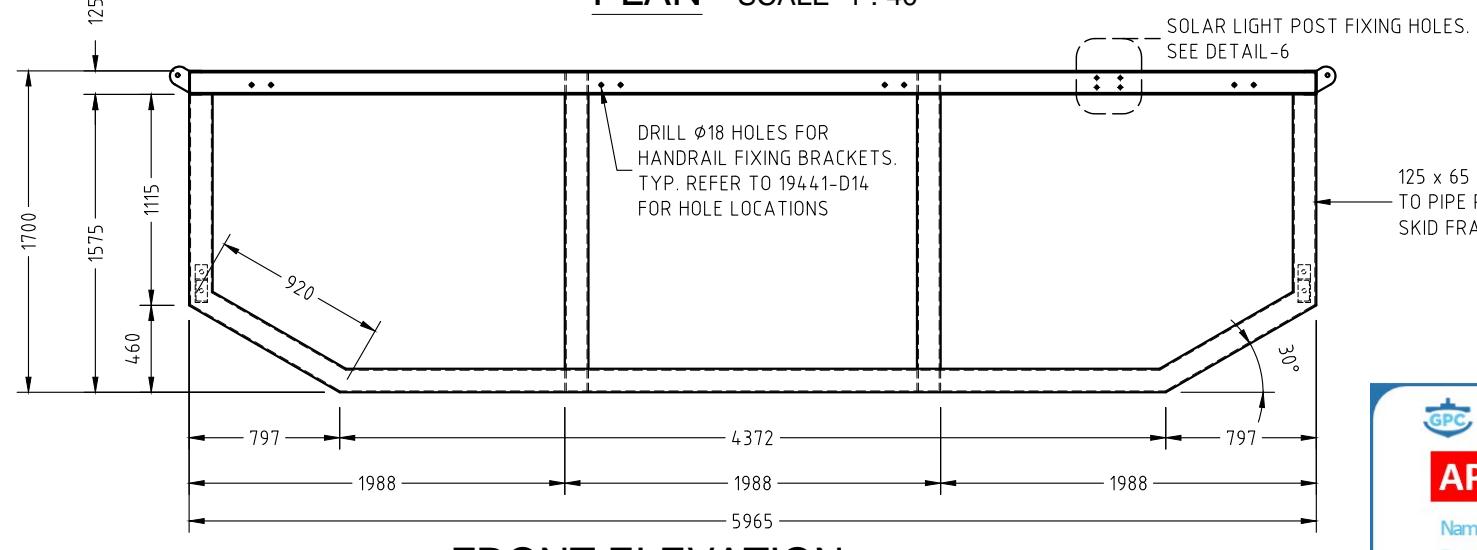

FRONT ELEVATION SCALE 1 : 40

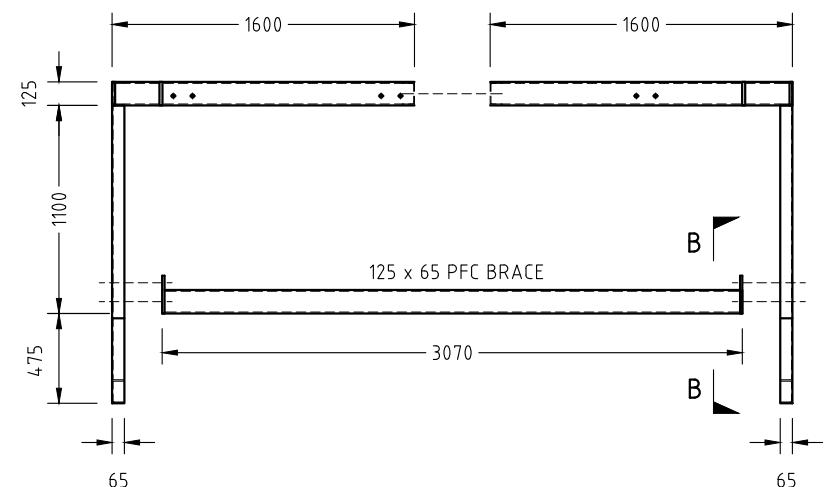

SIDE ELEVATION SCALE 1 : 40

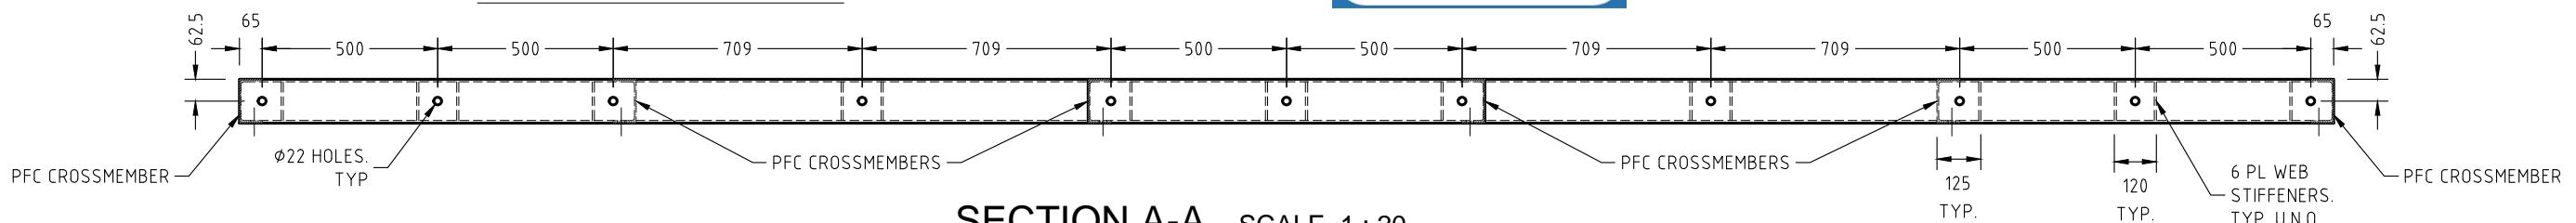

SECTION A-A SCALE 1 : 20


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A	28/07/2022	DAVIT FOUNDATION REVISED	S.D.
B	04/04/2023	FRP STIFFENER DETAILS ADDED - REFER D03.3	S.D.
C	11/05/2023	MESH PANEL DETAILS ADDED - REFER D03.4 & D03.5	S.D.
D	31/05/2023	RREQ ENGINEER COMMENTS INCORPORATED	S.D.




DATE	06/06/2022
DRAWING NO.	19441-D03.1
REVISION NO.	D

PROJECT	PROPOSED PONTOON AND WALKWAY PONTOON FRAME CONSTRUCTION DETAILS		
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CLIENT	QAL		
ADDRESS	QAL WALKWAY GLADSTONE		
DRAWN BY	SD.	DESIGNED	CHECKED BY
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			A3
			SCALE AS NOTED


CERTIFIED	Himanshu Nalindrajith
	Praveen Moragaspitiya
	RREQ: 16451

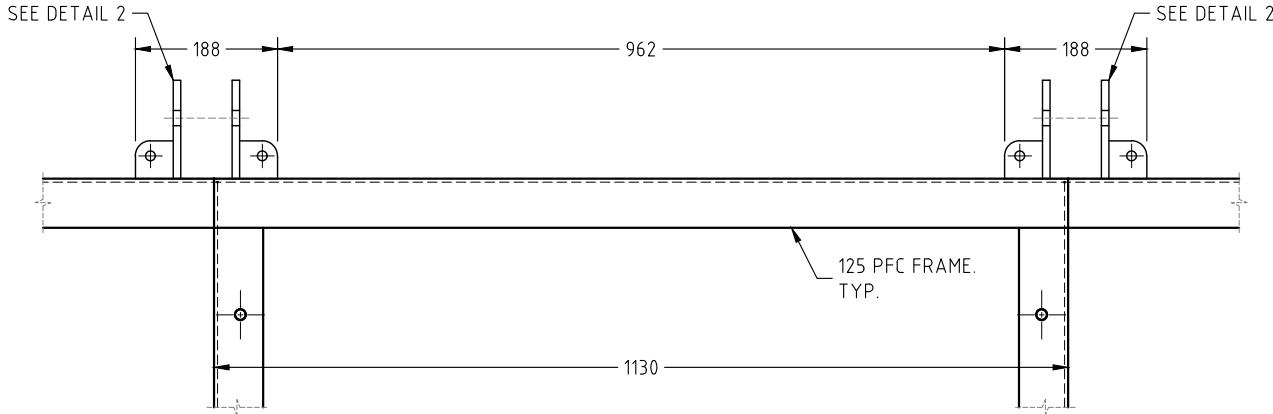

DETAIL - 1 SCALE 1: 10

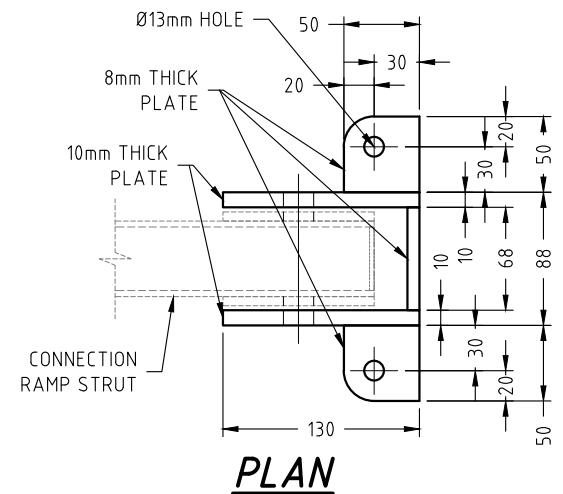

PLAN

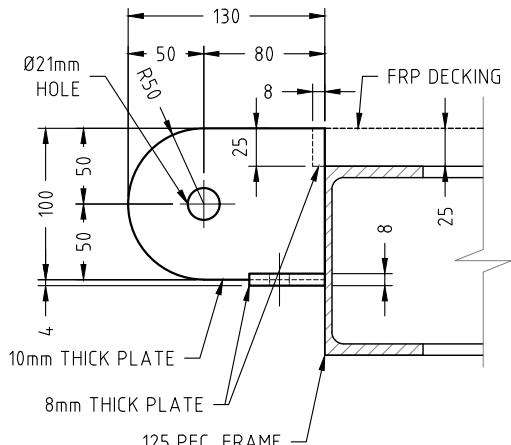


ELEVATION

DETAIL 2 - CONNECTION RAMP BRACKET

DETAIL - PONTOON END


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125 PFC JOINT DETAIL - TYPICAL

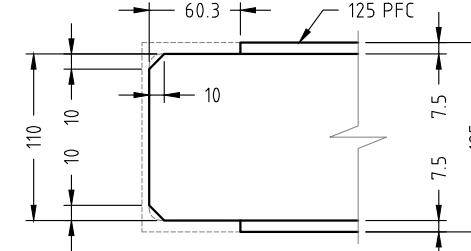
SCALE 1: 5

- NOTE :**
1. ALL PONTOONS MEMBER SHALL BE STEEL 125 PFC
 2. ALL MEMBERS TO BE WELDED WITH CONTINUOUS 6mm FILLET, TYP. U.N.O.
 3. ALL HOLE CENTRES TO BE VERIFIED AGAINST FLOAT MODULE FIXING HOLES PRIOR TO DRILLING.
 4. ALL FASTENERS TO BE 316 ST/S AND SECURED WITH LOCTITE THREADLOCKING ADHESIVE (OR SIMILAR).
 5. ALL DISSIMILAR METALS MUST BE SEPARATED USING ISOLATING WASHERS OR SLEEVES.
 6. FRP DECKING SYSTEM OF THE PUMP PONTOON IS 38x38 STANDARD INDUSTRIAL ENVIROGRATE WITH 25mm DEPTH AND 12.9 kg/SQM MASS




DETAIL 3 - LIFTING PLATE

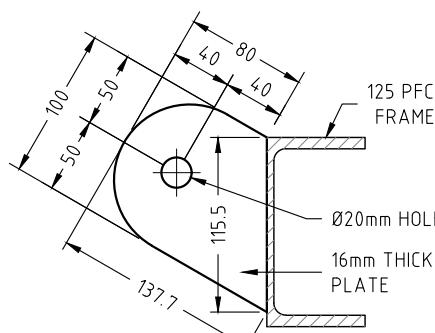SCALE 1: 5 (4 ONLY REQUIRED)

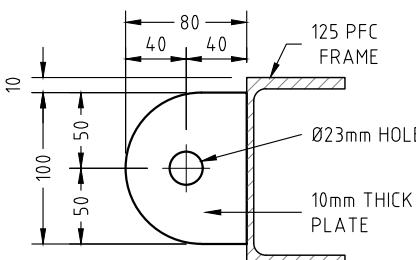


**DETAIL 4 - CABLE
ANCHOR PLATE**

SCALE 1: 5 (4 ONLY REQUIRED)

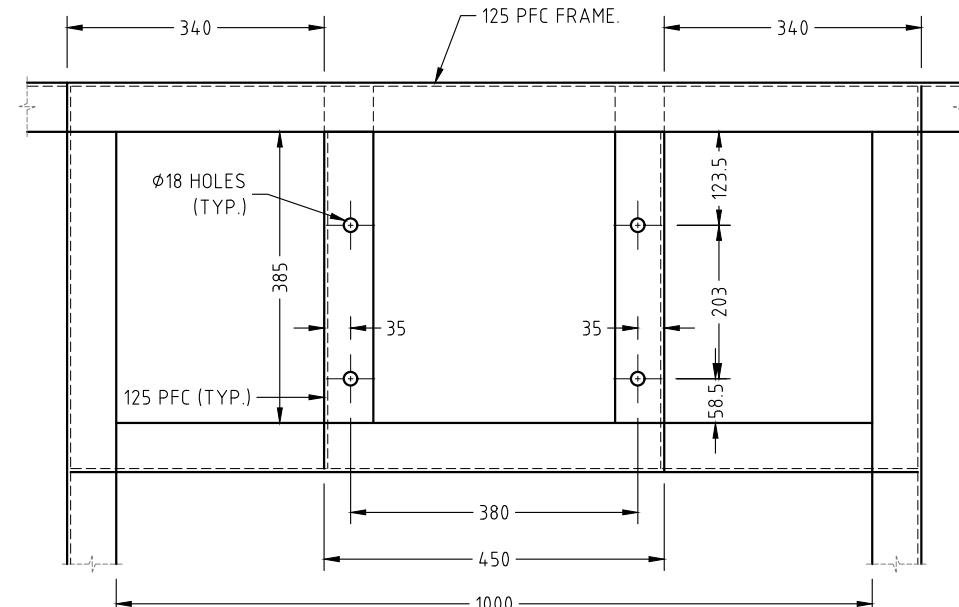

DETAIL 5 - DAVIT FOUNDATION

SCALE 1: 10

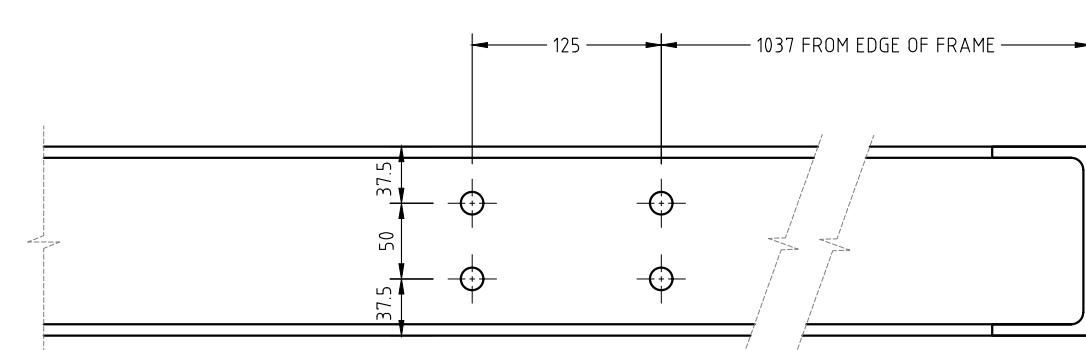

DETAIL 5 - SOLAR LIGHT POST FIXING HOLES

SCALE 1: 5



No.	DATE	REVISION	DRAWN BY
A	28/07/2022	DAVIT FOUNDATION REVISED	S.D.
B	31/05/2023	RPEQ ENGINEER COMMENTS INCORPORATED	S.D.

KK BEST COST-EFFECTIVE
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BUILDINGS, BRIDGES AND
MARINAS

K and K Consulting Engineers Pty Ltd
BTP (Brisbane Technology Park)
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Eight Mile Plains, QLD 4113
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Phone: (07) 3195 5692
Web: www.knkengineers.com.au

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Mail Address: P.O. Box 202 Labrador 4215
Ph: (07) 5594 8200
Email: info@superiorjetties.com

DATE
06/06/2022

DRAWING NO.
19441-D03.2

REVISION NO.
B

PROJECT
PROPOSED PONTOON AND WALKWAY
PONTOON FRAME CONSTRUCTION DETAILS


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QAL

CLIENT
ADDRESS
QAL WALKWAY
GLADSTONE

DRAWN BY
S.D.
DESIGNED
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CHECKED BY
PAPER SIZE
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SCALE
AS NOTED


CERTIFIED
Himanshu Nalindrajith
Praveen Moragaspitiya

RPEQ: 16451

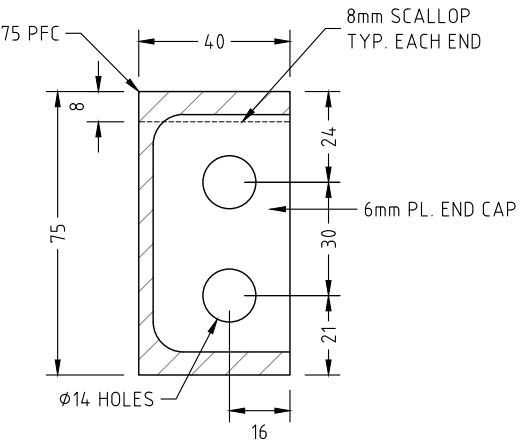


SECCION A-A

SCALE 1:2

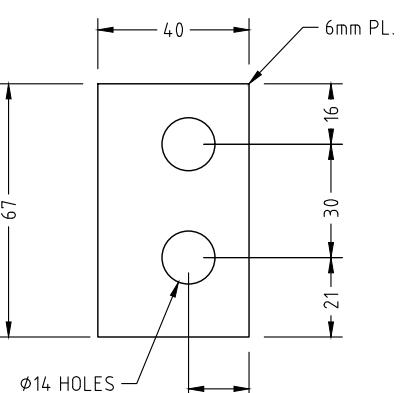


END CAP (16 IN TOTAL)

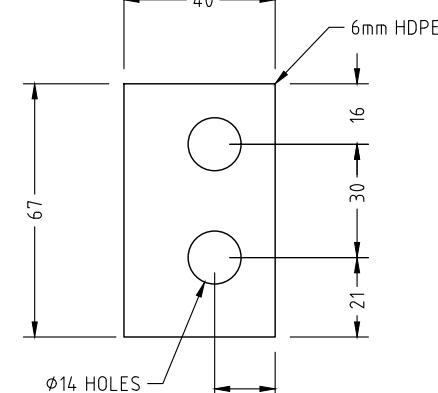

HDPE SHEET (16 IN TOTAL)




Name: Trudi Smith
Date: 2:49pm 28/08/2023

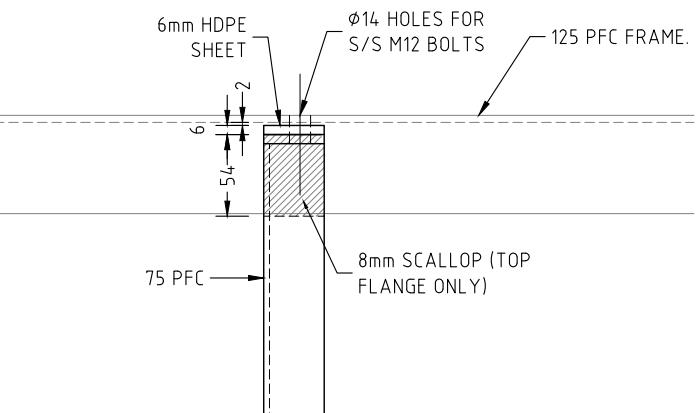

DETAIL A (TYP. 15 PLACES)


SCALE 1:5

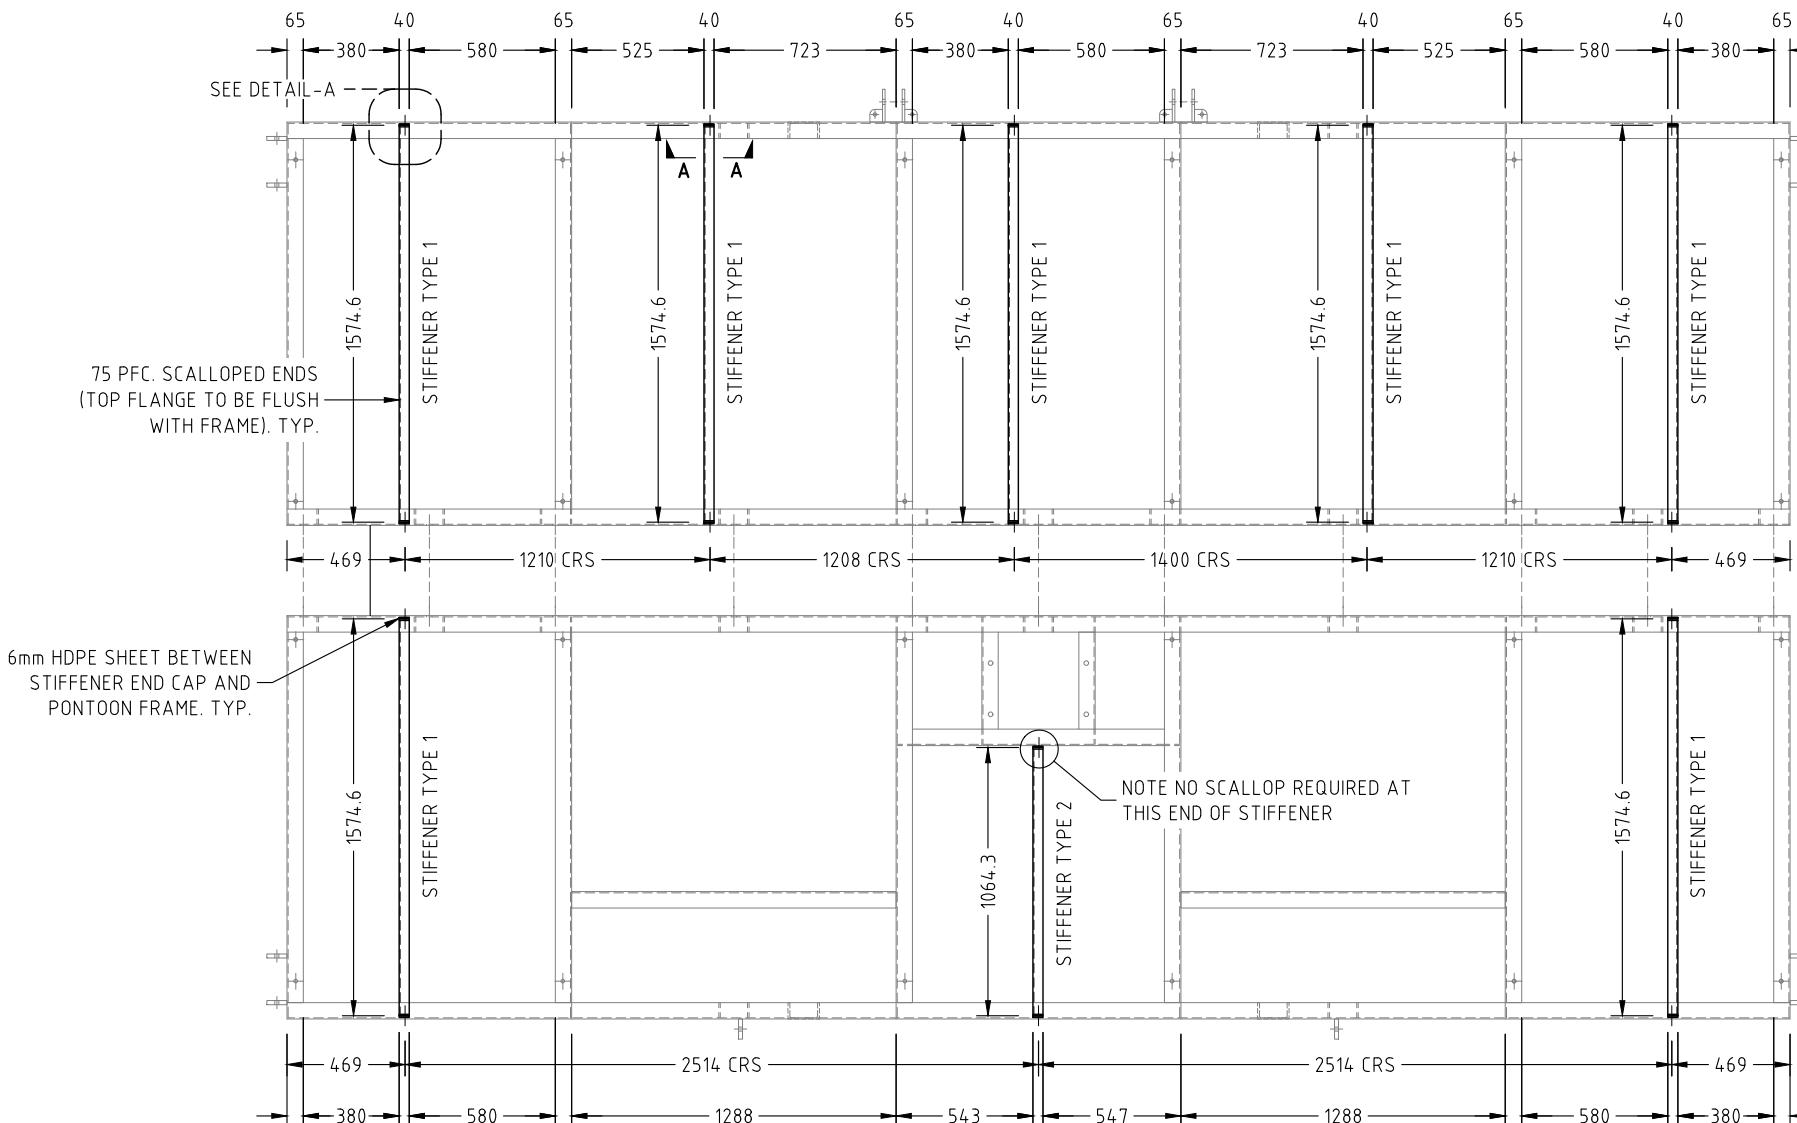

PLAN SCALE 1:40


NOTE :

1. ALL STIFFENERS SHALL BE STEEL 75 PFC
2. ALL STIFFENERS SHALL BE PAINTED TO MATCH PONTOON FRAME
3. ALL MEMBERS TO BE WELDED WITH CONTINUOUS 6mm FILLET, TYP. U.N.O.
4. ALL HOLE CENTRES TO BE VERIFIED AGAINST EXISTING PONTOON FRAME PRIOR TO DRILLING.
5. ALL FASTENERS TO BE 316 ST/S AND SECURED WITH LOCTITE THREADLOCKING ADHESIVE (OR SIMILAR).
6. ALL DISSIMILAR METALS MUST BE SEPARATED USING ISOLATING WASHERS OR SLEEVES.
7. FRP DECKING SYSTEM OF THE PUMP PONTOON IS 38x38 STANDARD INDUSTRIAL ENVIROGRATE WITH 25mm DEPTH AND 12.9 kg/SQM MASS

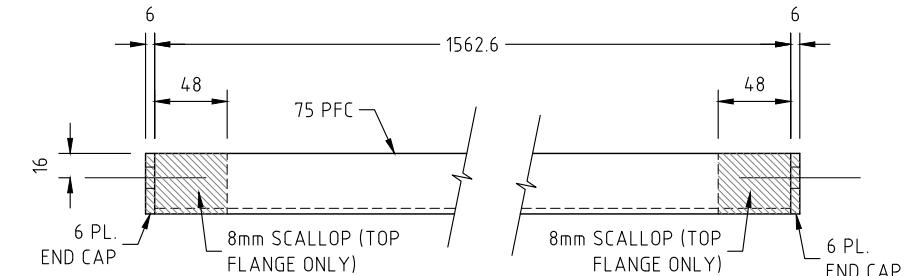

STIFFENER TYPE 1 - PLAN (7 IN TOTAL)

SCALE 1:5

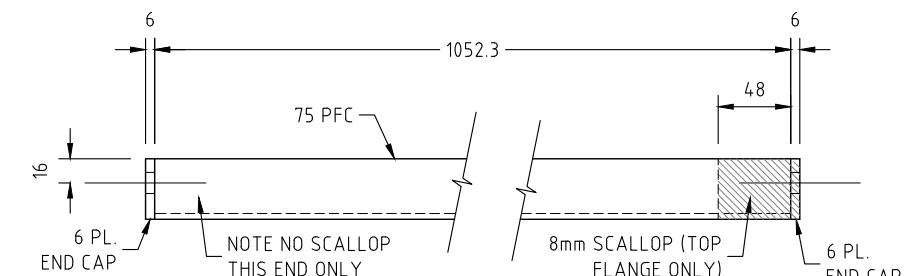

STIFFENER TYPE 2 - PLAN (1 IN TOTAL)

SCALE 1:5

NO.	DATE	REVISION	DRAWN BY
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B	31/05/2023	RREQ ENGINEER COMMENTS INCORPORATED	S.D.


KK BEST COST-EFFECTIVE SOLUTIONS FOR BUILDINGS, BRIDGES AND MARINAS
K and K Consulting Engineers Pty Ltd
BTP (Brisbane Technology Park)
1 Cluny Road, C1
Eight Mile Plains, QLD 4113
Email: hp@knkengineers.com.au
Phone: (07) 3195 5692
Web: www.knkengineers.com.au

SUPERIOR
Mail Address: P.O. Box 202 Labrador 4215
Ph: (07) 5594 8200
Email: info@superiorjetties.com

DATE
17/03/2023
DRAWING NO.
19441-D03.3
REVISION NO.
B

PROJECT
PROPOSED PONTOON AND WALKWAY MODIFICATION - ADDITION OF FRP STIFFENERS
DRG. TITLE
CLIENT
QAL
ADDRESS
QAL WALKWAY GLADSTONE
DRAWN BY
S.D. DESIGNED
M.W. CHECKED BY
PAPER SIZE
A3 SCALE
AS NOTED



CERTIFIED
Himanshu Nalindrajith
Praveen Moragaspitiya
RREQ: 16451

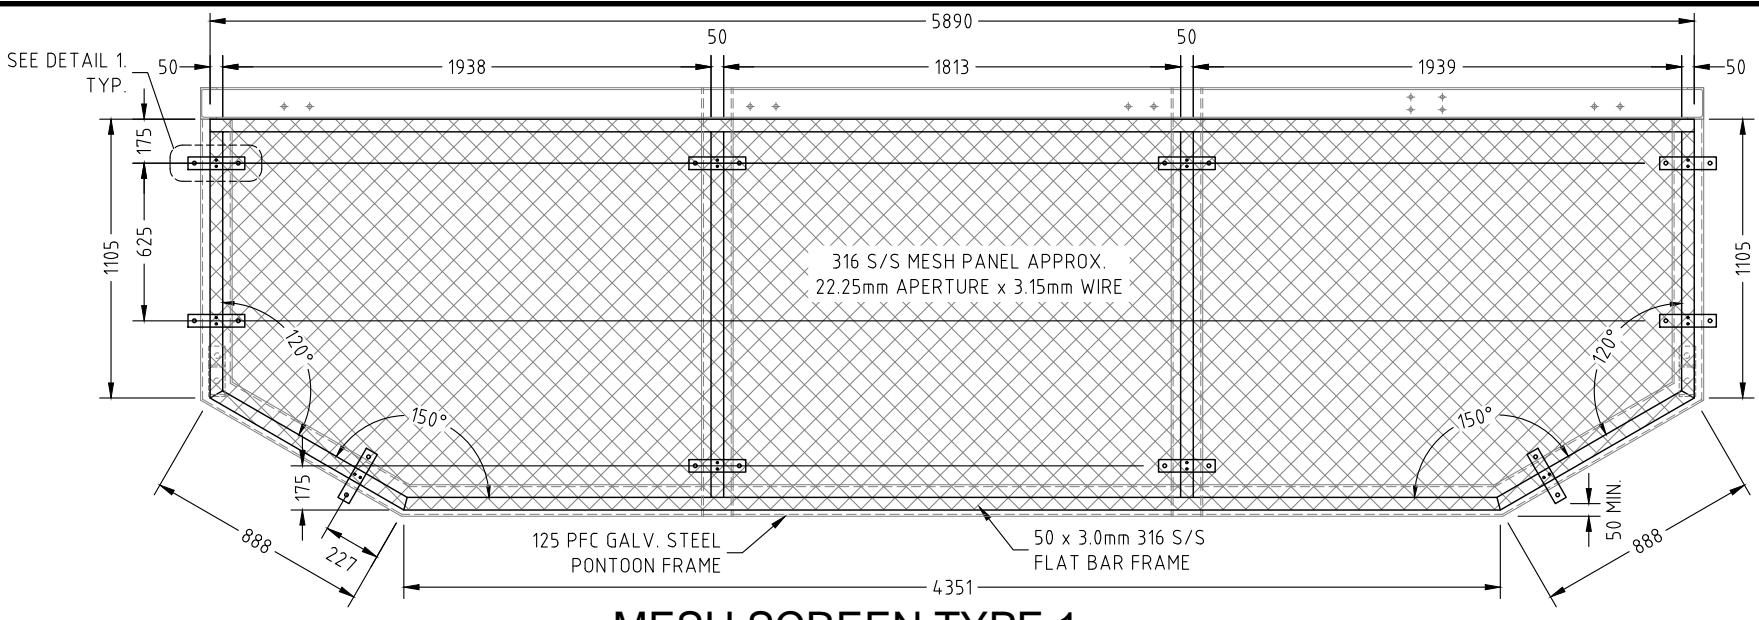


MESH SCREEN TYPE 1 SCALE 1 : 40
2 ONLY REQUIRED

NOTE :

1. ALL MESH SCREEN FRAME MEMBERS SHALL BE STAINLESS STEEL, GRADE 316, 50x3.0 FLAT BAR
2. ALL MEMBERS TO BE WELDED WITH CONTINUOUS 6mm FILLET, TYP. U.N.O.
3. ALL FASTENERS TO BE 316 ST/S AND SECURED WITH LOCTITE THREADLOCKING ADHESIVE (OR SIMILAR).
4. ALL DISSIMILAR METALS MUST BE SEPARATED USING ISOLATING WASHERS OR SLEEVES.

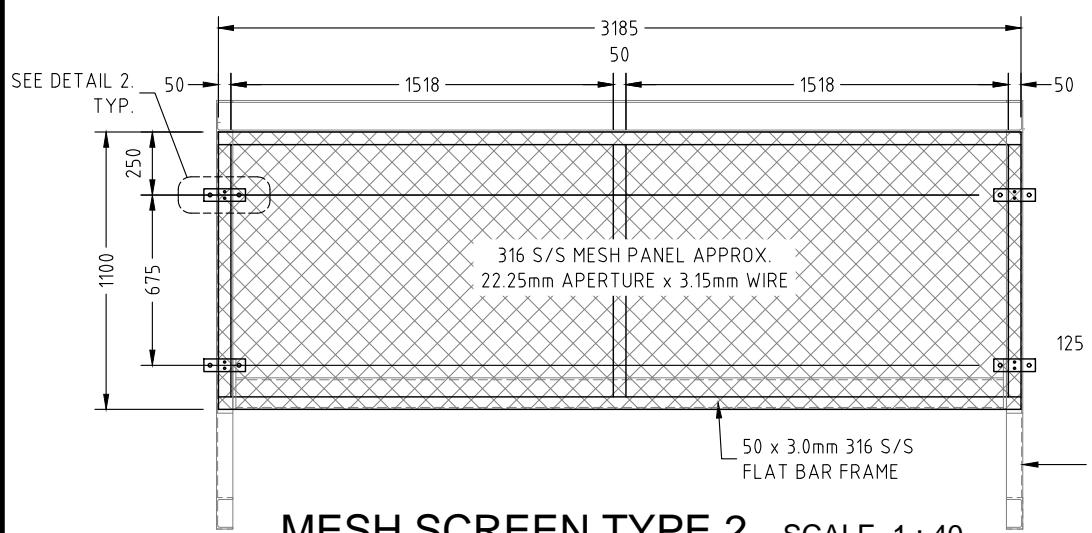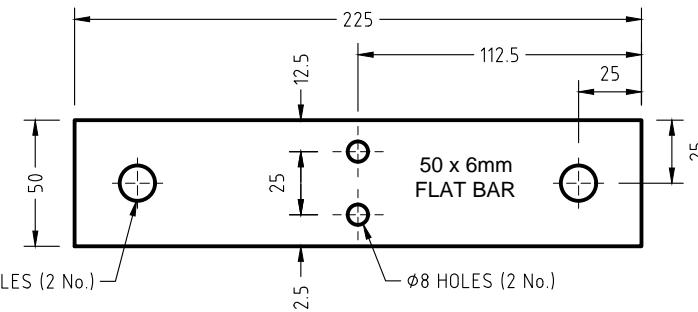


MESH SCREEN TYPE 2 SCALE 1 : 40
2 ONLY REQUIRED

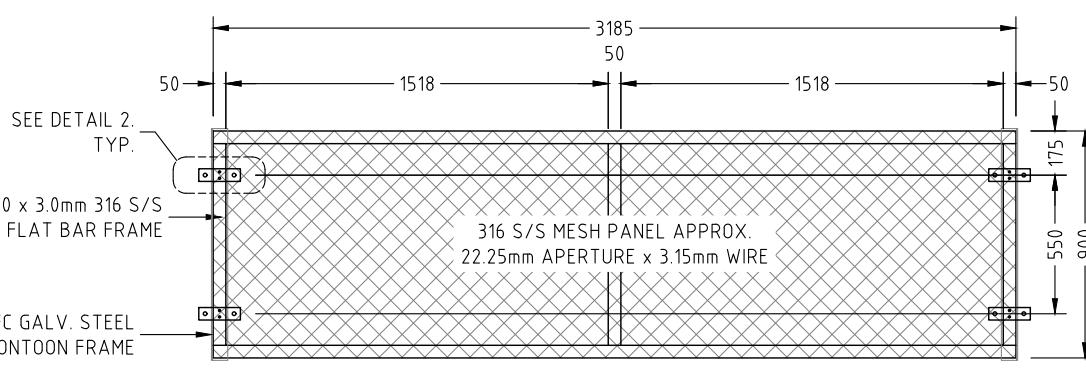


MESH SCREEN TYPE 3 SCALE 1 : 40
2 ONLY REQUIRED


S/S PLATE TYPE 1 SCALE 1 : 3
40 ONLY REQUIRED

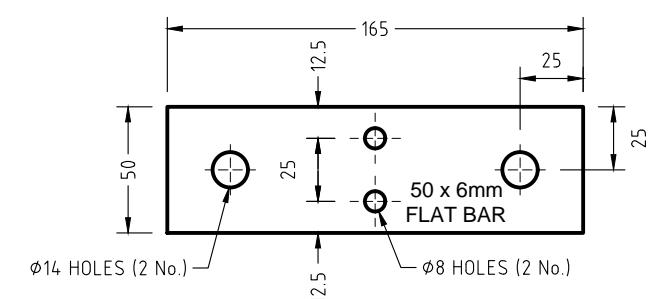

S/S PLATE TYPE 2 SCALE 1 : 3
32 ONLY REQUIRED

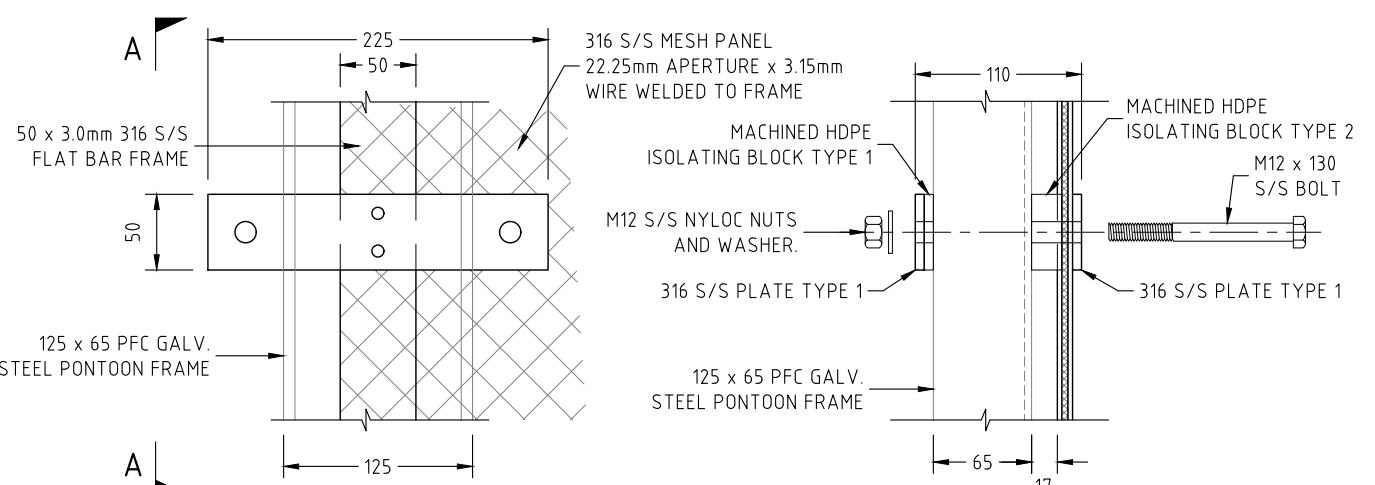

DETAIL 1 SCALE 1 : 5

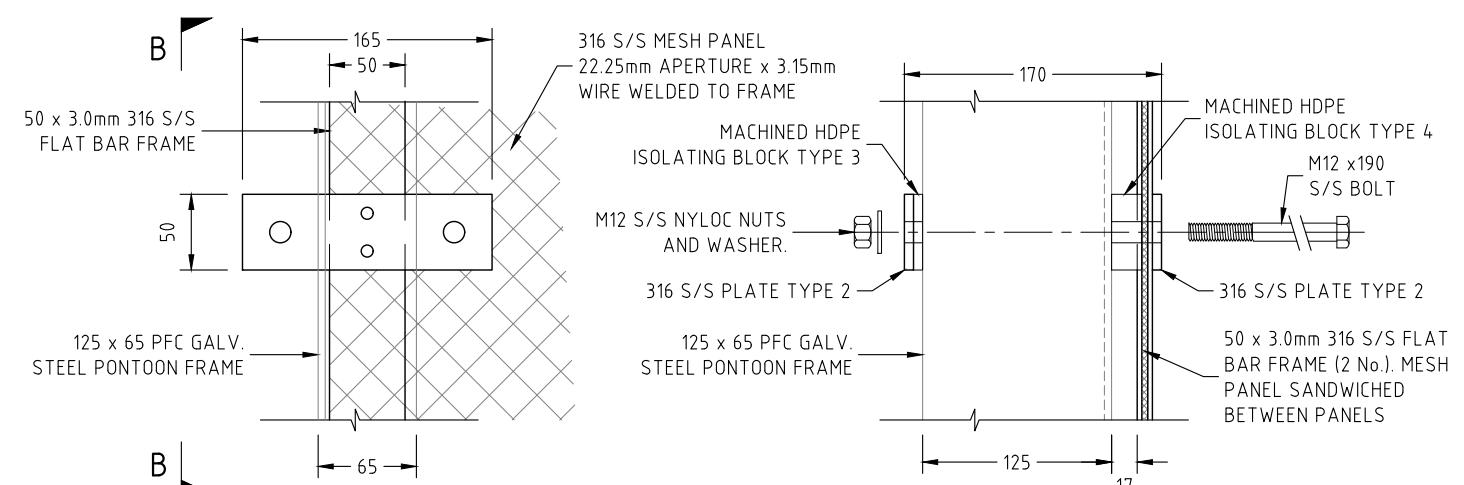

SECTION B-B SCALE 1 : 5

NO.	DATE	REVISION	DRAWN BY
A	31/05/2023	RPEQ ENGINEER COMMENTS INCORPORATED	S.D.

KK BEST COST-EFFECTIVE SOLUTIONS FOR BUILDINGS, BRIDGES AND MARINAS
K and K Consulting Engineers Pty Ltd
BTP (Brisbane Technology Park)
1 Clarendon Road, C1
Eight Mile Plains, QLD 4113
Email: hp@knkengineers.com.au
Phone: (07) 3195 5692
Web: www.knkengineers.com.au

SUPERIOR
Mail Address: P.O. Box 202 Labrador 4215
Ph: (07) 5594 8200
Email: info@superiorjetties.com


DATE
11/04/2023
DRAWING NO.
19441-D03.4
REVISION NO.
A

PROJECT
PROPOSED PONTOON AND WALKWAY
PONTOON FRAME MESH PANEL DETAILS
DRG. TITLE
CLIENT
QAL
ADDRESS
QAL WALKWAY
GLADSTONE
DRAWN BY
S.D.
DESIGNED
M.W.
CHECKED BY
PAPER SIZE
A3
SCALE
AS NOTED

CERTIFIED
Himanshu Nalindrajith
Praveen Moragaspitiya
RPEQ: 16451


APPROVED

Name: Trudi Smith
Date: 2:50pm 28/08/2023

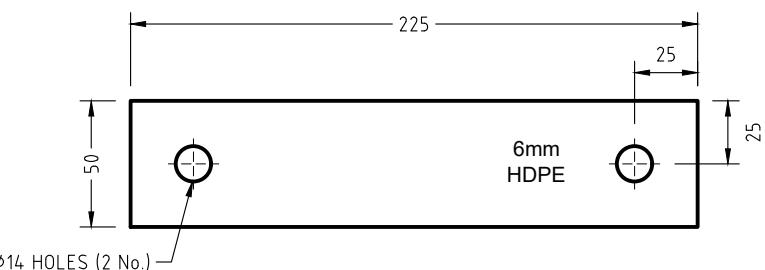


HDPE ISOLATING BLOCK TYPE 1

SCALE 1 : 3
20 ONLY REQUIRED

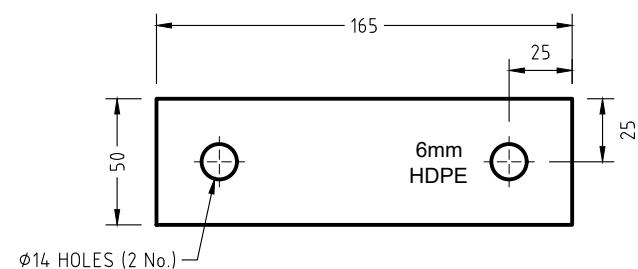


HDPE ISOLATING BLOCK TYPE 3

SCALE 1 : 3
16 ONLY REQUIRED

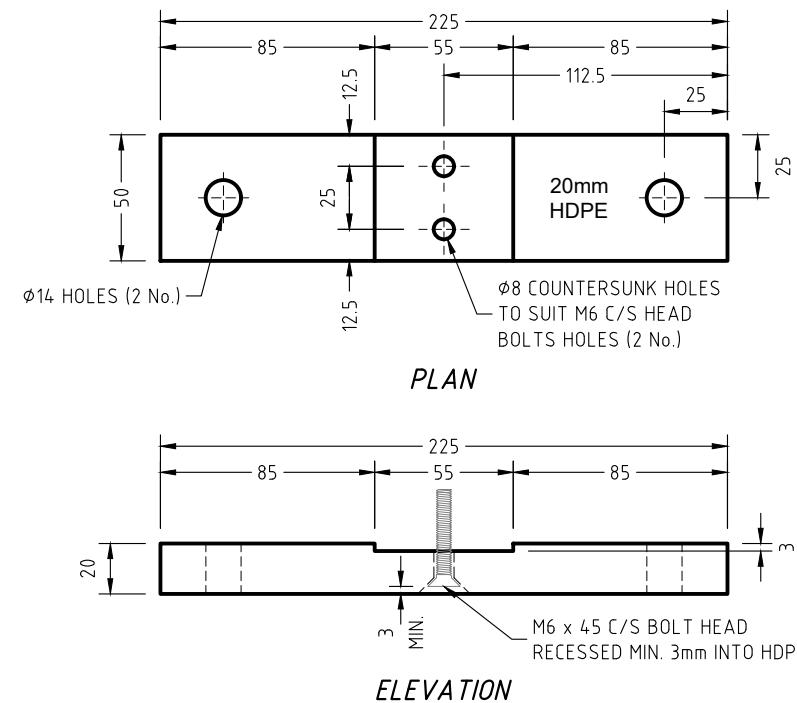


HDPE ISOLATING BLOCK TYPE 2

SCALE 1 : 3
20 ONLY REQUIRED

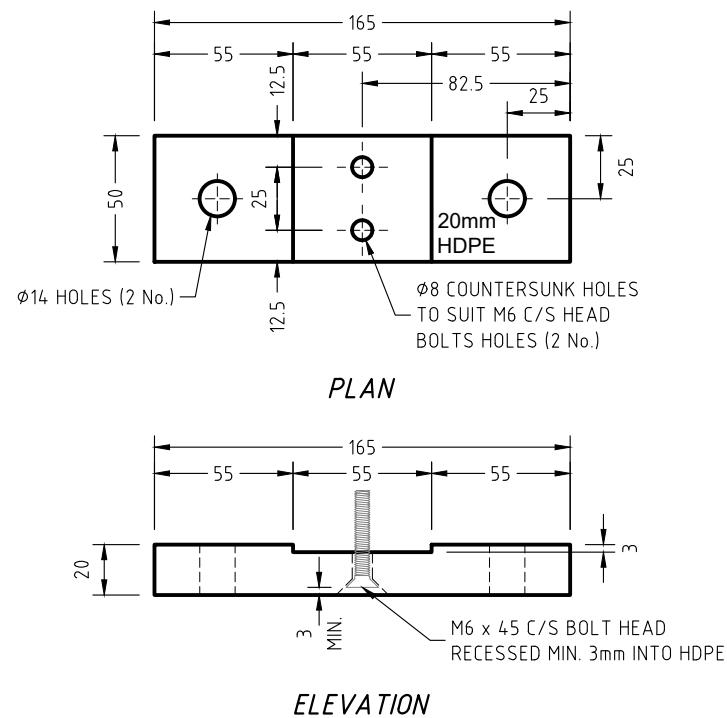


HDPE ISOLATING BLOCK TYPE 4

SCALE 1 : 3
16 ONLY REQUIRED

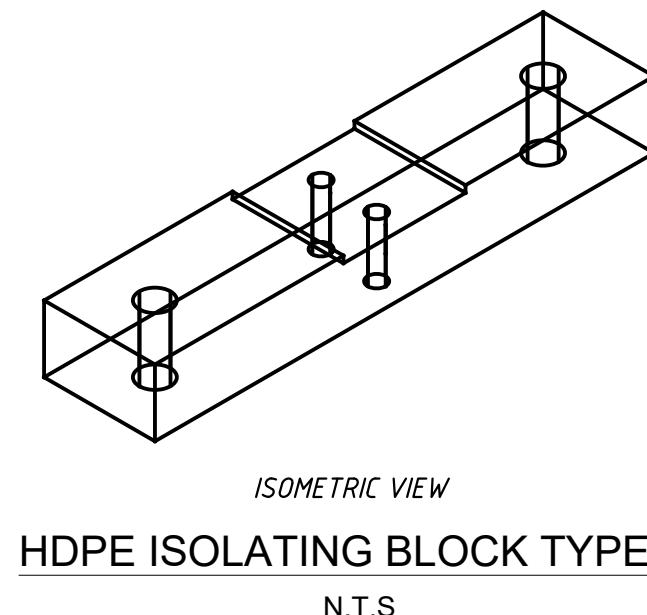

HDPE ISOLATING BLOCK TYPE 2

N.T.S

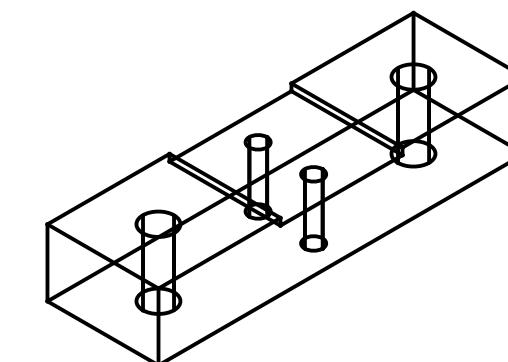

ISOMETRIC VIEW

HDPE ISOLATING BLOCK TYPE 4

N.T.S

No.	DATE	REVISION	DRAWN BY


KK BEST COST-EFFECTIVE SOLUTIONS FOR BUILDINGS, BRIDGES AND MARINAS
K and K Consulting Engineers Pty Ltd
BTP (Brisbane Technology Park)
1 Clunies Ross Ct,
Eight Mile Plains QLD 4113
Email: hp@knkengineers.com.au
Phone: (07) 3195 5692
Web: www.knkengineers.com.au

SUPERIOR
Mail Address: P.O. Box 202 Labrador 4215
Ph: (07) 5594 8200
Email: info@superiorjetties.com

DATE
11/04/2023
DRAWING NO.
19441-D03.5
REVISION NO.

PROJECT
PROPOSED PONTOON AND WALKWAY
DRG. TITLE
PONTOON FRAME HDPE ISOLATING BLOCK DETAILS
CLIENT
QAL
ADDRESS
QAL WALKWAY
GLADSTONE
DRAWN BY
S.D.
DESIGNED
M.W.
CHECKED BY
PAPER SIZE
A3
SCALE
AS NOTED

CERTIFIED
Himenshu Nalindrajith
Praveen Moragaspitiya
RPEQ: 16451

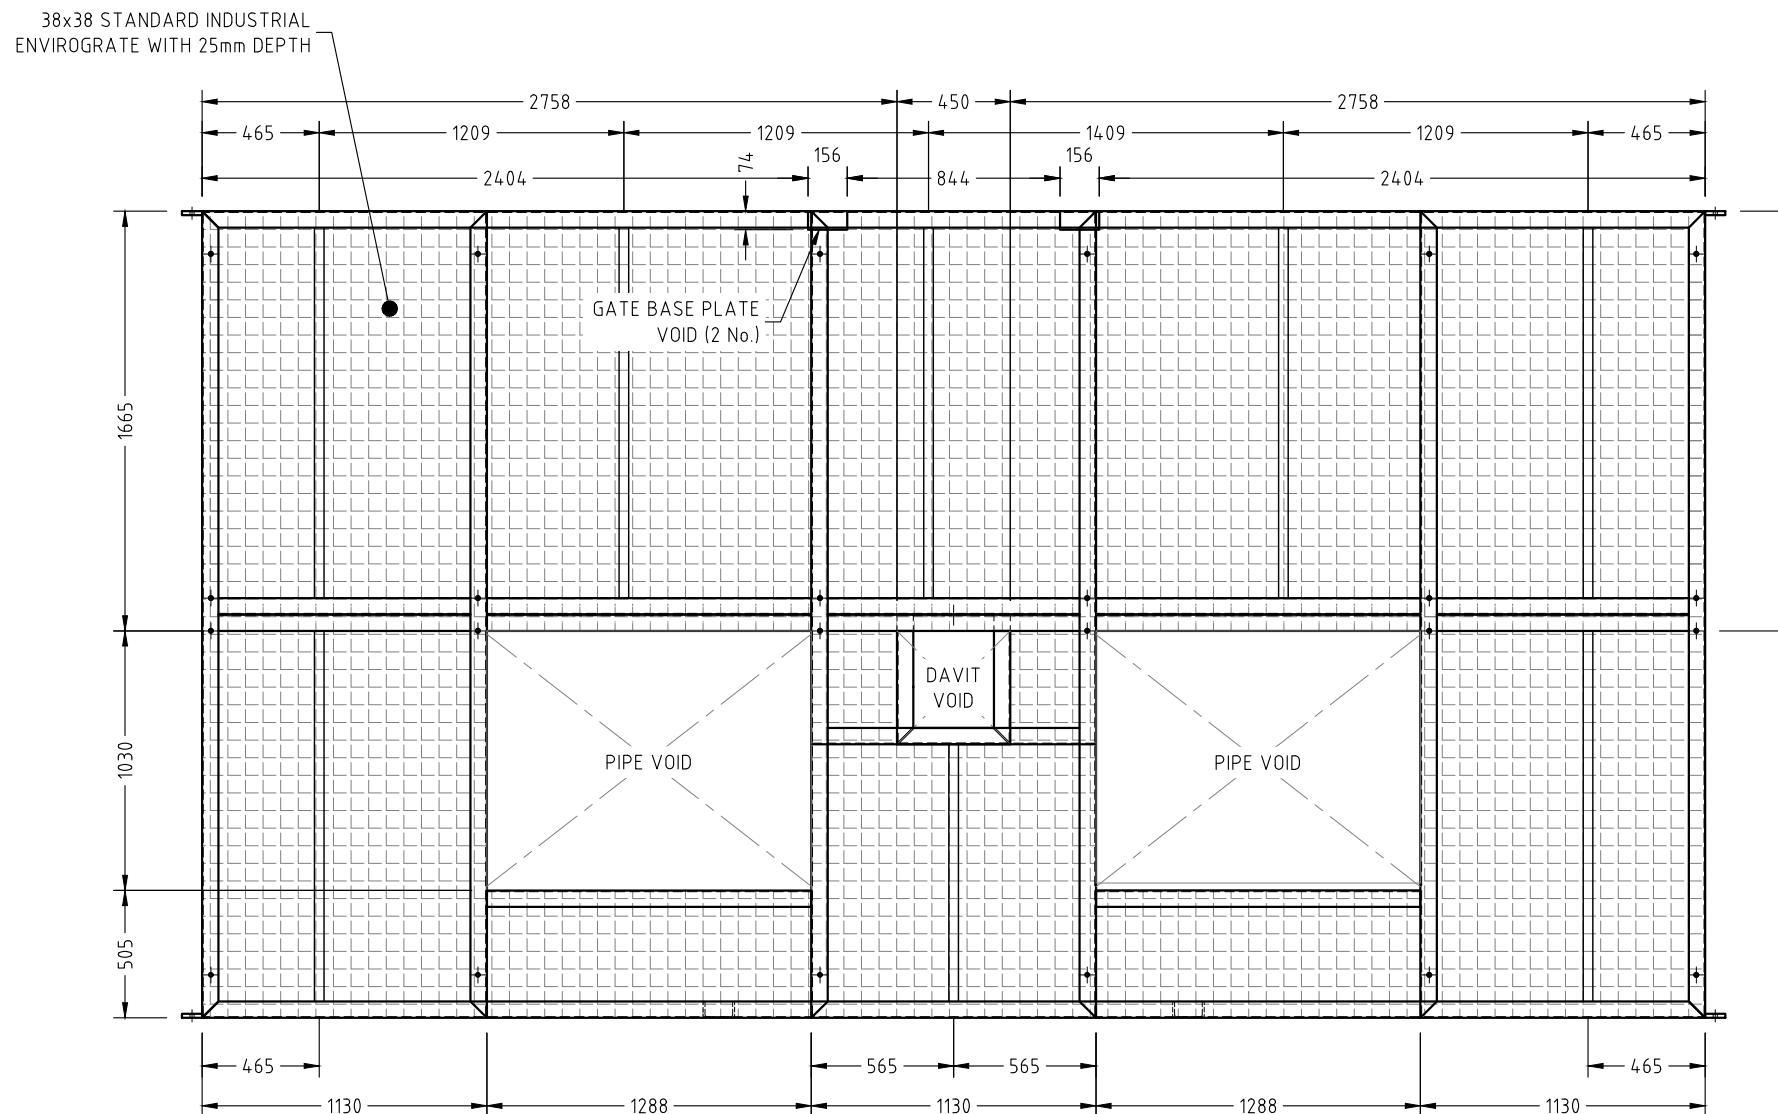APPROVEDName: Trudi Smith
Date: 2:50pm 28/08/2023**PLAN** SCALE 1 : 30**NOTE :**

- FRP DECKING SYSTEM OF THE PUMP PONTOON IS 38x38 STANDARD INDUSTRIAL ENVIROGRATE WITH 25mm DEPTH AND 12.9 kg/SQM MASS

No.	DATE	REVISION	DRAWN BY
A	04/04/2023	FRP STIFFENERS ADDED TO FRAME	S.D.
B	31/05/2023	RPEQ ENGINEER COMMENTS INCORPORATED	S.D.






DATE
06/06/2022
DRAWING NO.
19441-D04

REVISION NO:
B

PROJECT	PROPOSED PONTOON AND WALKWAY PONTOON DECKING PLAN		
DRG. TITLE			
CLIENT	QAL		
ADDRESS	QAL WALKWAY GLADSTONE		
DRAWN BY S.D.	DESIGNED M.W.	CHECKED BY	PAPER SIZE A3 SCALE AS NOTED

CERTIFIED
Himenshu Nalindrajith Praveen Moragaspitiya


RPEQ: 16451

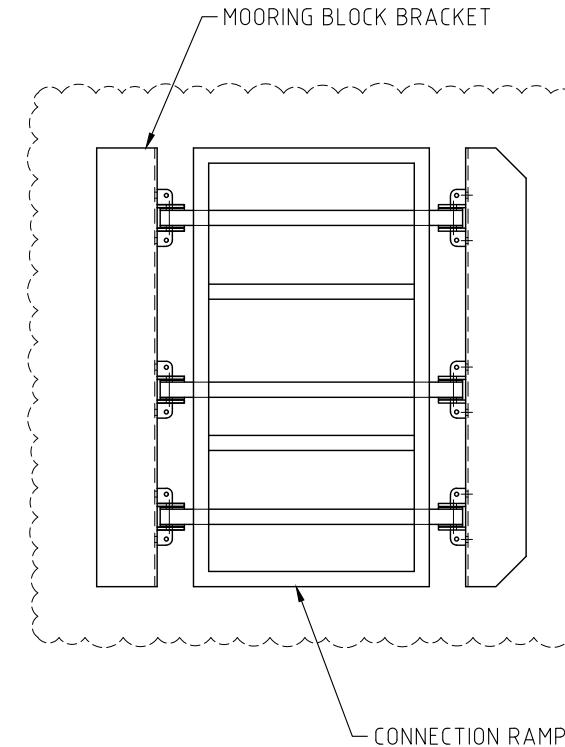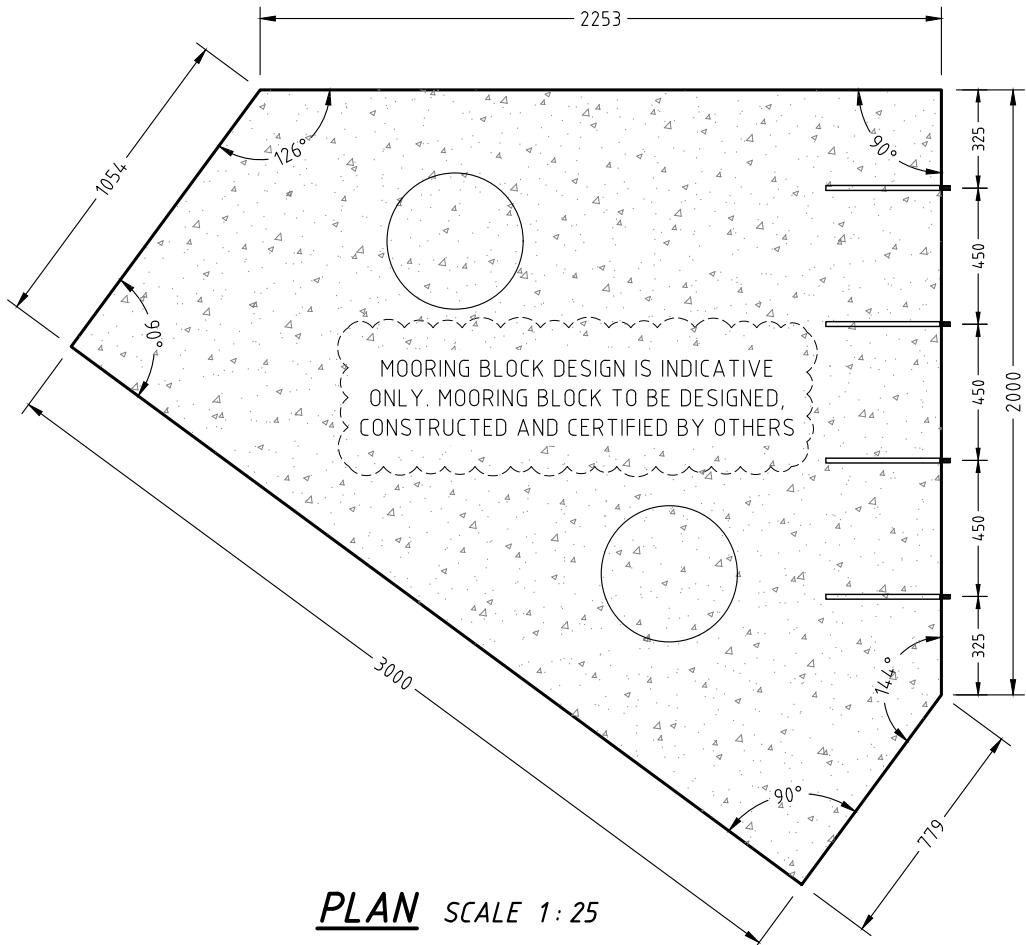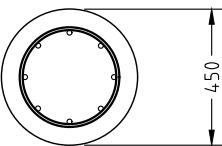APPROVEDName: Trudi Smith
Date: 2:50pm 28/08/2023SEE DRAWING 19441-D06
FOR FURTHER DETAILS

6N12 VERTICAL BARS (LAP LENGTH 600 U.N.O.) WITH R10 HELICAL TIE AT 225 PITCH, TYP.
SPIRAL OVERLAP IN PILES –
12N12 VERTICAL BARS IN PILES

CONCRETE TO BE N50 U.N.O.

CONCRETE COVER TO BE 65 U.N.O.

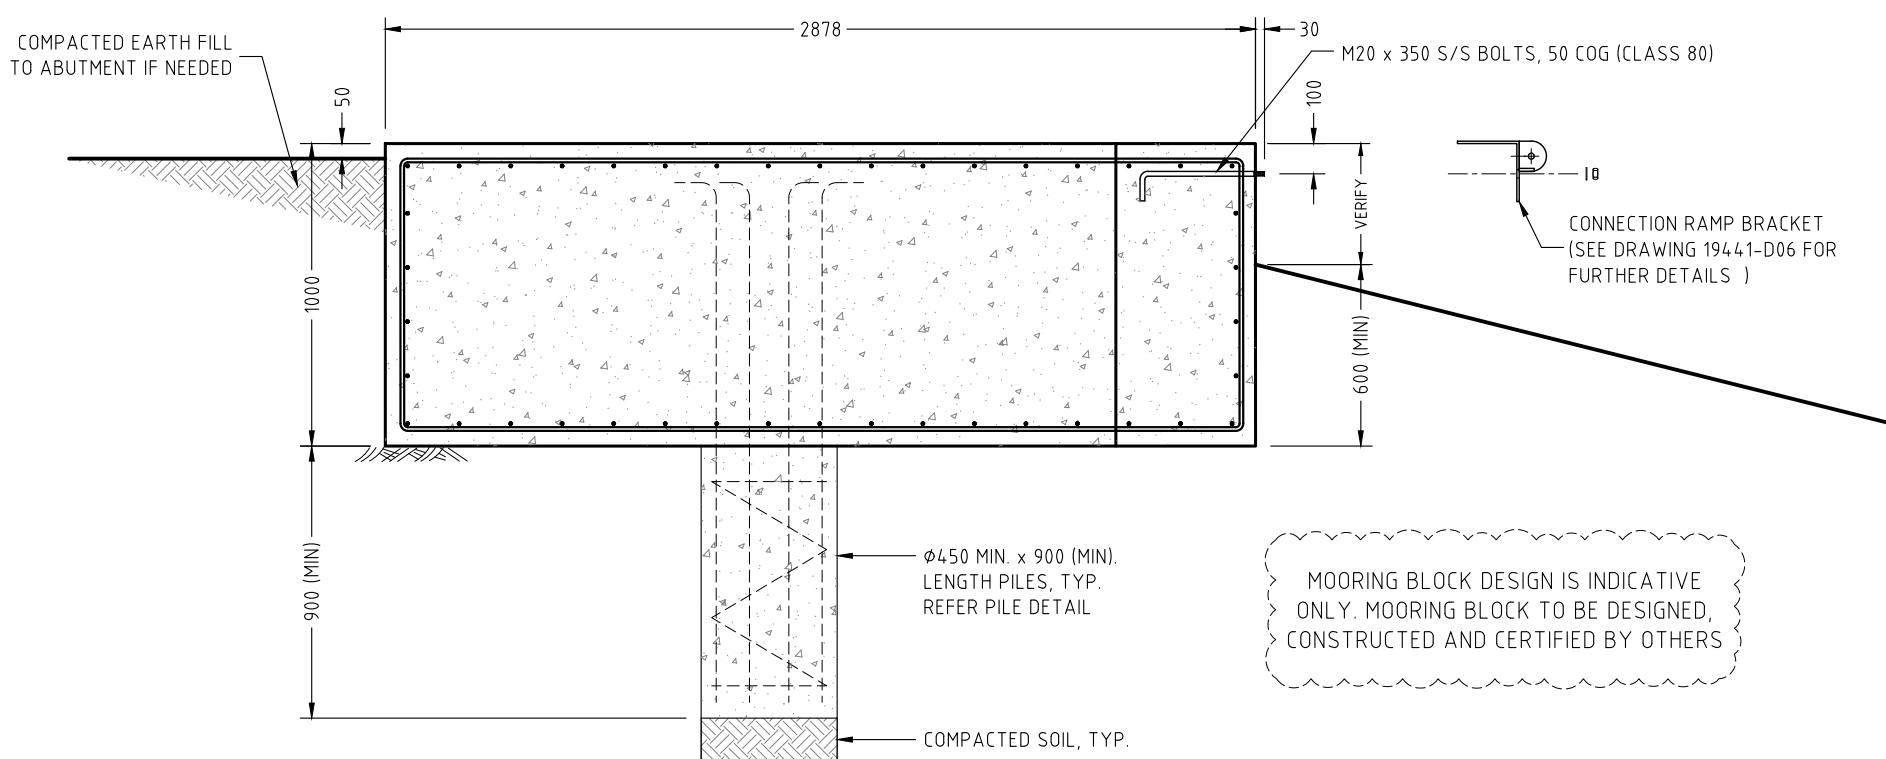**TYPICAL PILE DETAIL** SCALE 1:25**NOTES:**

- UNDERSIDE OF FOOTINGS TO BE POURED ON 200mm COMPACTED SOIL LAYER WITH A MINIMUM BEARING CAPACITY OF 100kPa, TYP. (WHICH IS DETERMINED BY RELEVANT PROFESSIONALS)
- IT IS THE CONTRACTOR'S RESPONSIBILITY TO PROVIDE ADEQUATE SYSTEMS BASED ON RELEVANT PROFESSIONAL RECOMMENDATIONS TO PROTECT THE FOUNDATION SYSTEMS FROM SOIL EROSION AND SETTLEMENT.
- THE MAXIMUM SETTLEMENT OF THE FOUNDATION S AT ANY TIME IS 5mm U.N.O.
- ALL THE ALUMINIUM MUST BE 6005-T5 AND BOLTS MUST BE 316 MARINE GRADE WITH CLASS 80.
- ALL DISSIMILAR MATERIALS REQUIRED TO BE SEPARATED.




NO.	DATE	REVISION	DRAWN BY






DATE	06/06/2022
DRAWING NO.	19441-D05
REVISION NO.	

PROJECT DRG. TITLE	PROPOSED PONTOON AND WALKWAY MOORING BLOCK DETAILS		
CLIENT	QAL		
ADDRESS	QAL WALKWAY GLADSTONE		
DRAWN BY S.D.	DESIGNED M.W.	CHECKED BY	PAPER SIZE A3
SCALE AS NOTED			

CERTIFIED	
Himenshu Nalindrajith	
Praveen Moragaspitiya	
RPEQ: 16451	

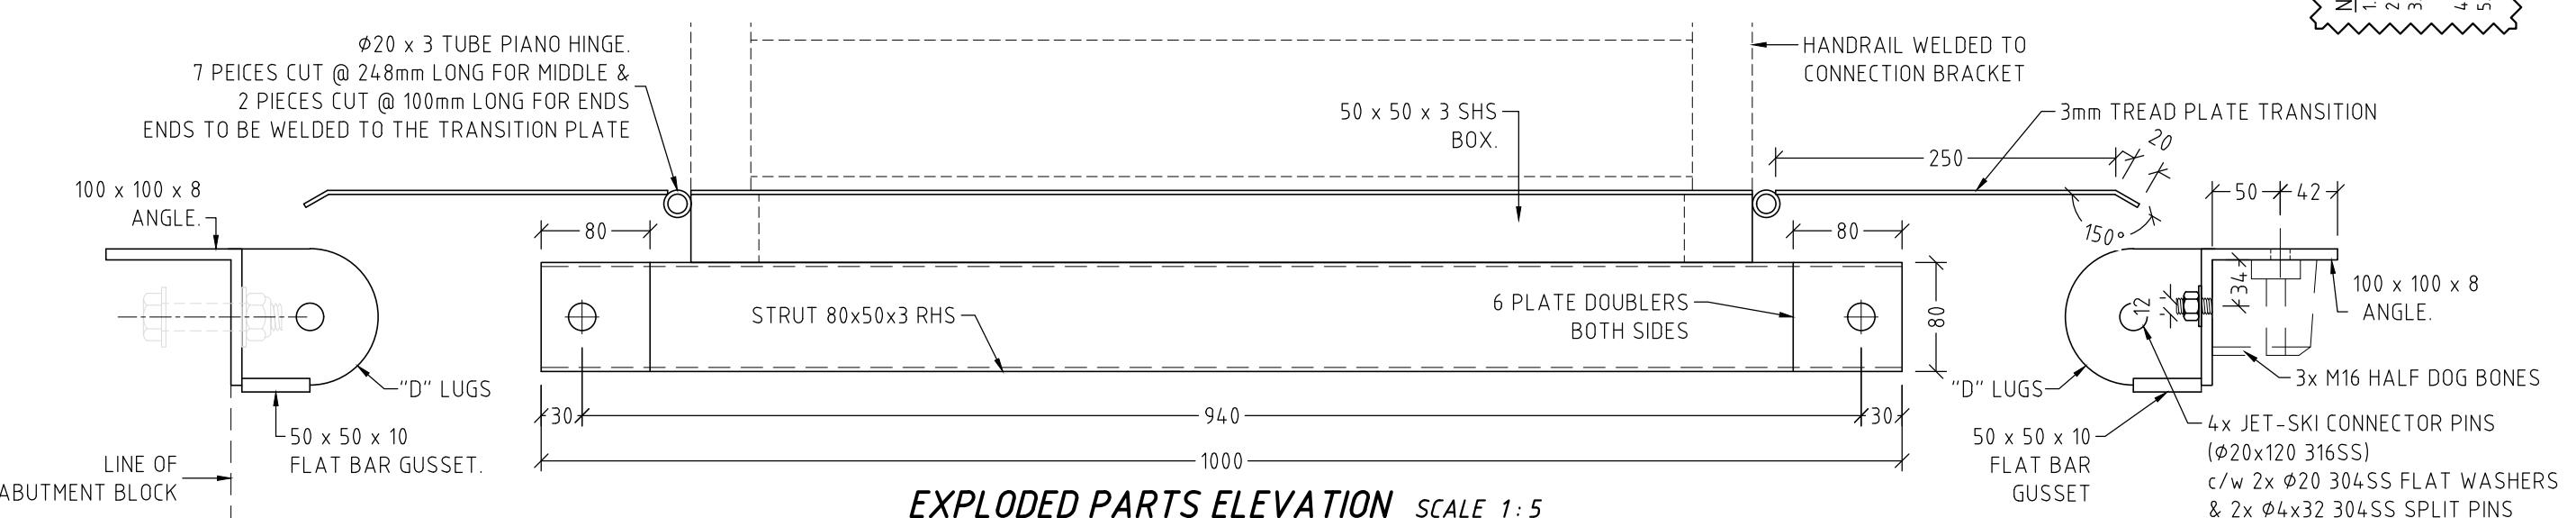
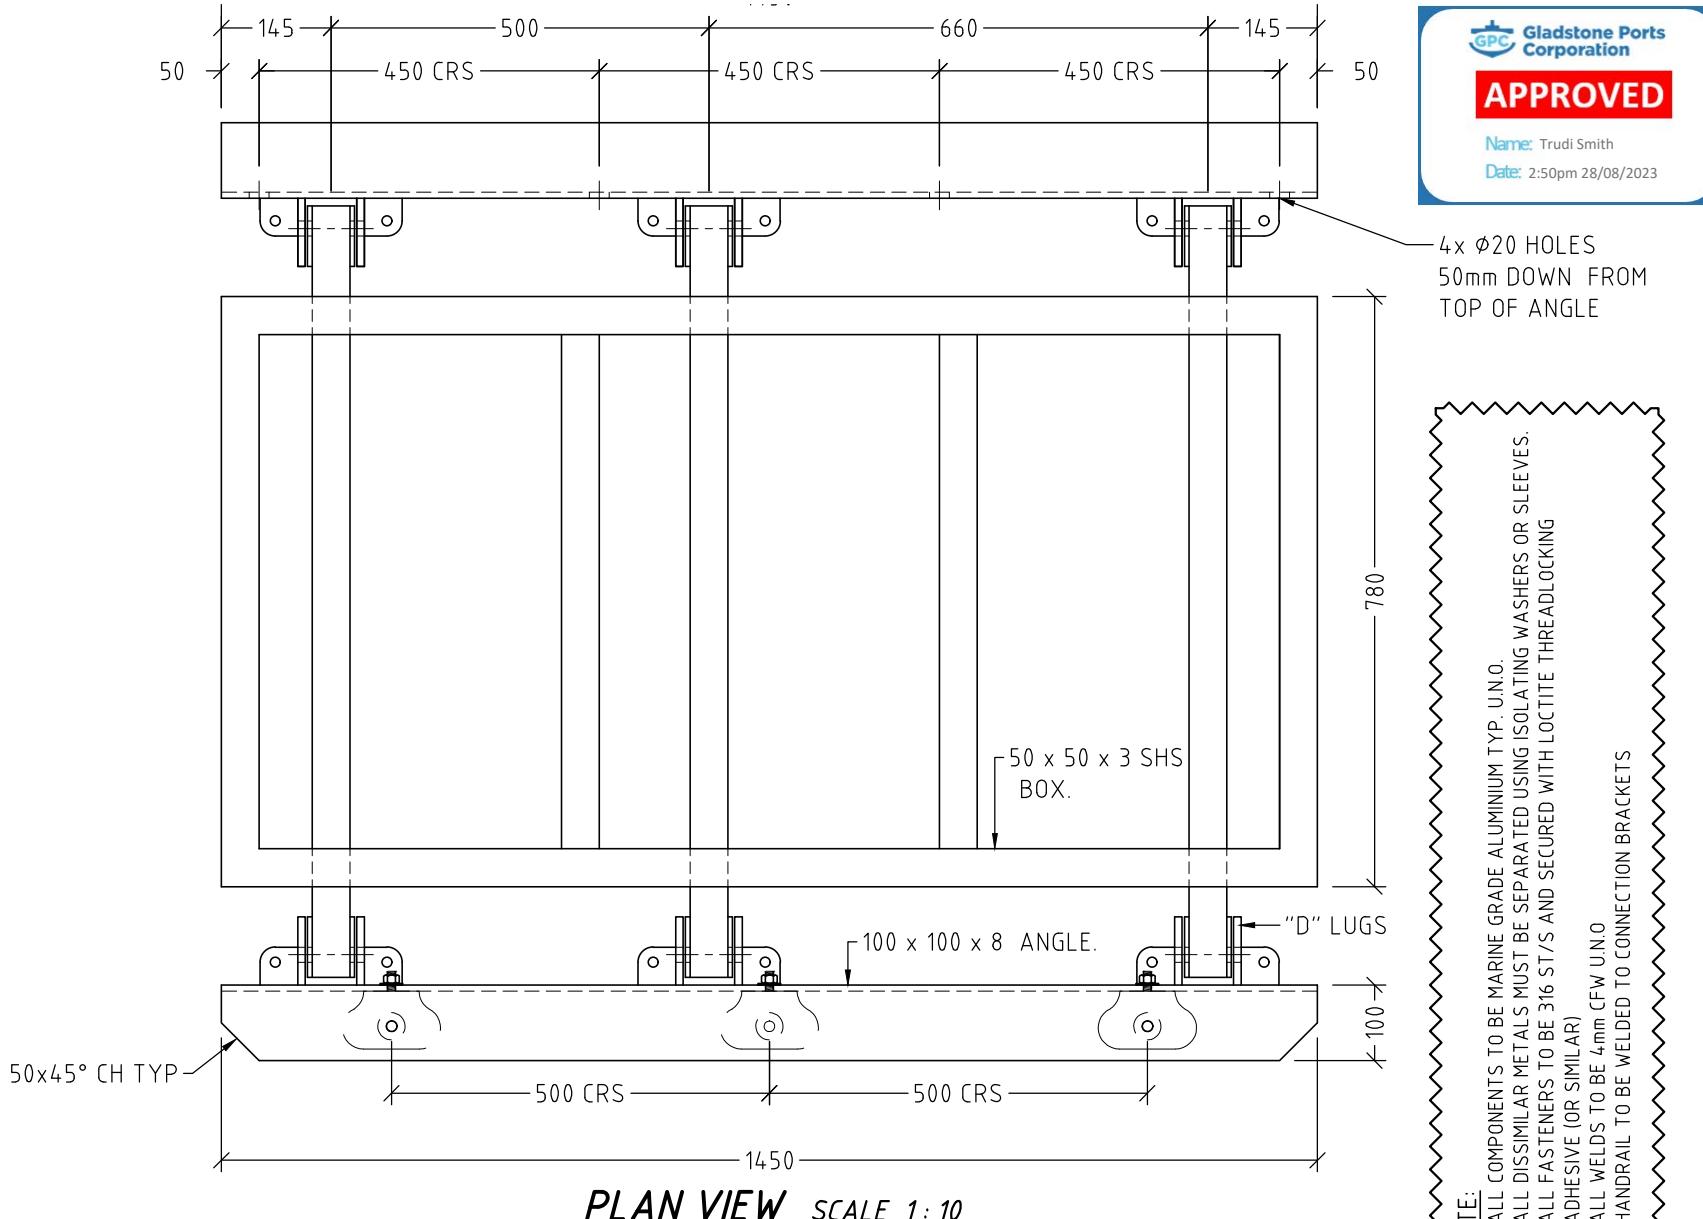
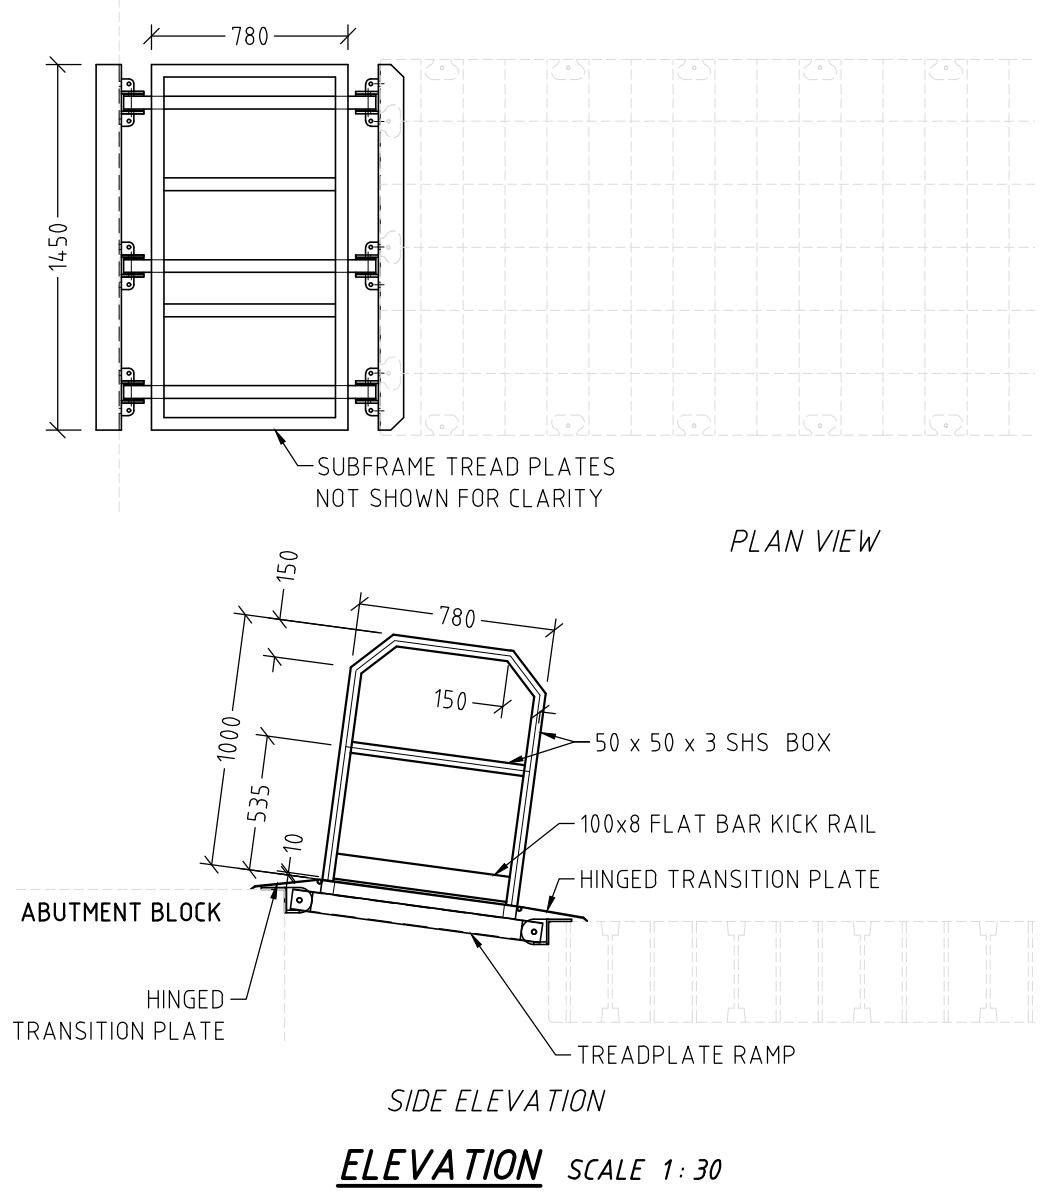
APPROVEDName: Trudi Smith
Date: 2:50pm 28/08/2023

NO:	DATE	REVISION	DRAWN BY

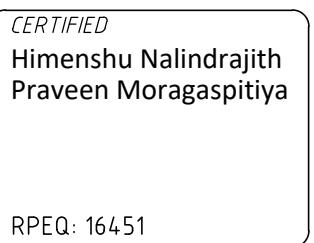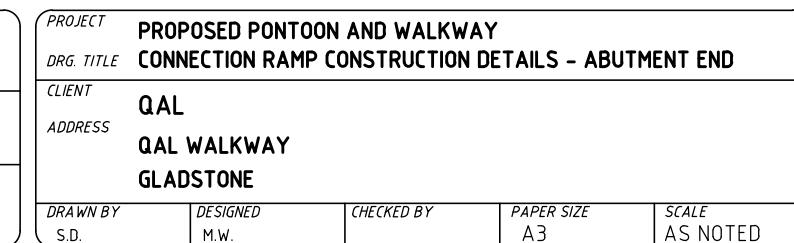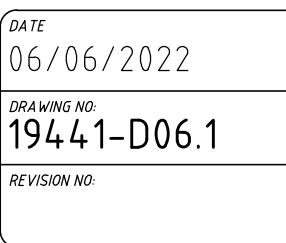


APPROVED

Name: Trudi Smith
Date: 2:51pm 28/08/2023

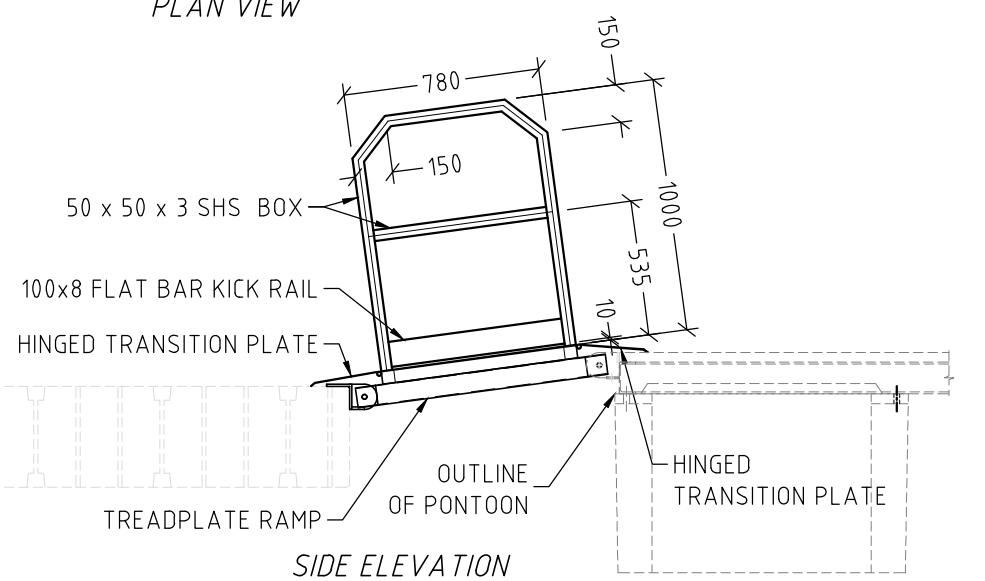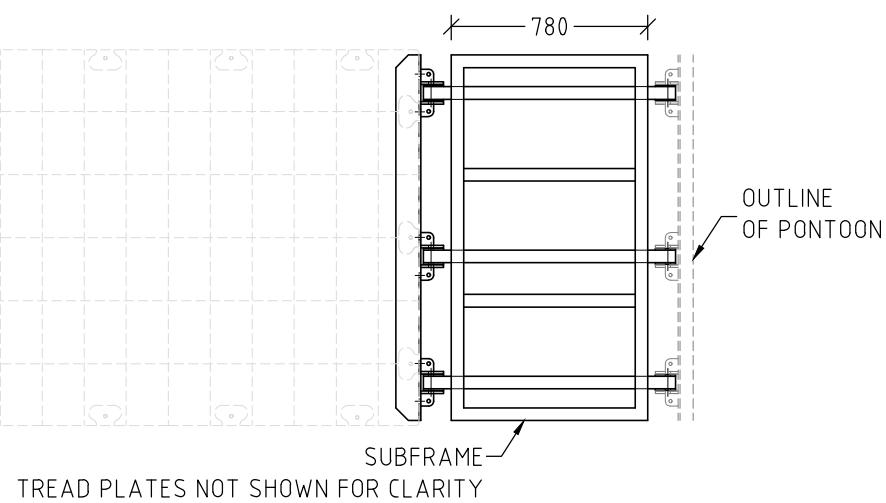
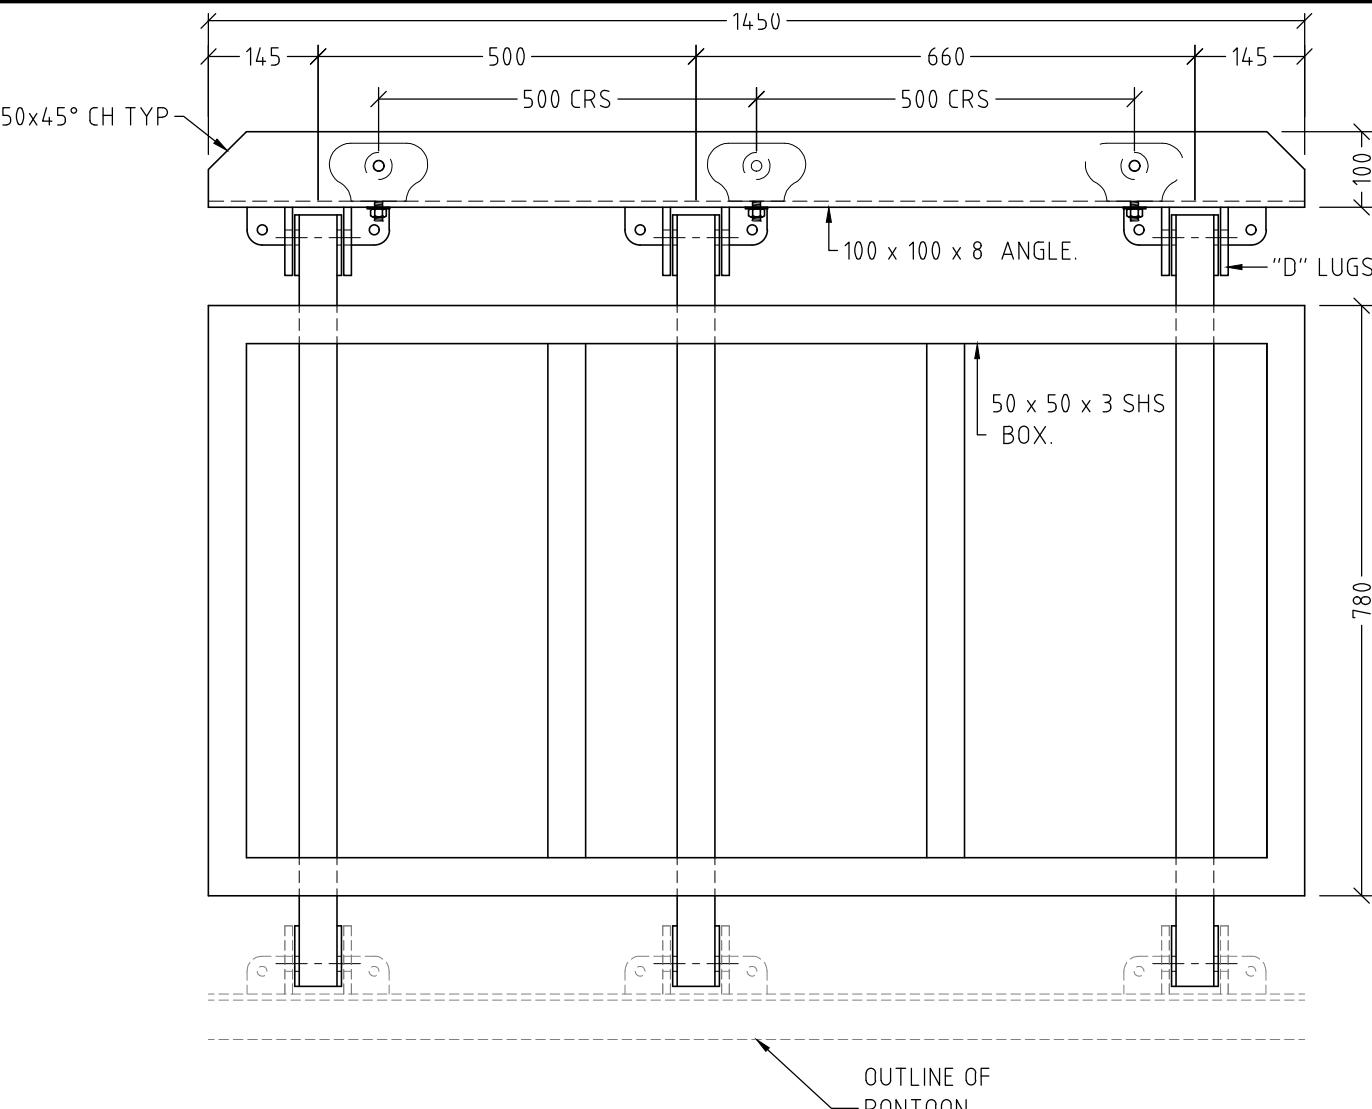
**ELEVATION** SCALE 1:30


NOTE:

1. ALL COMPONENTS TO BE MARINE GRADE ALUMINIUM TYP. U NO.
2. ALL DISSIMILAR METALS MUST BE SEPARATED USING ISOLATING WASHERS OR SLEEVES.
3. ALL FASTENERS TO BE 316 ST/S AND SECURED WITH LOCTITE THREADLOCKING ADHESIVE (OR SIMILAR)
4. ALL WELDS TO BE 4mm CFW U NO
5. HANDRAIL TO BE WELDED TO CONNECTION BRACKETS

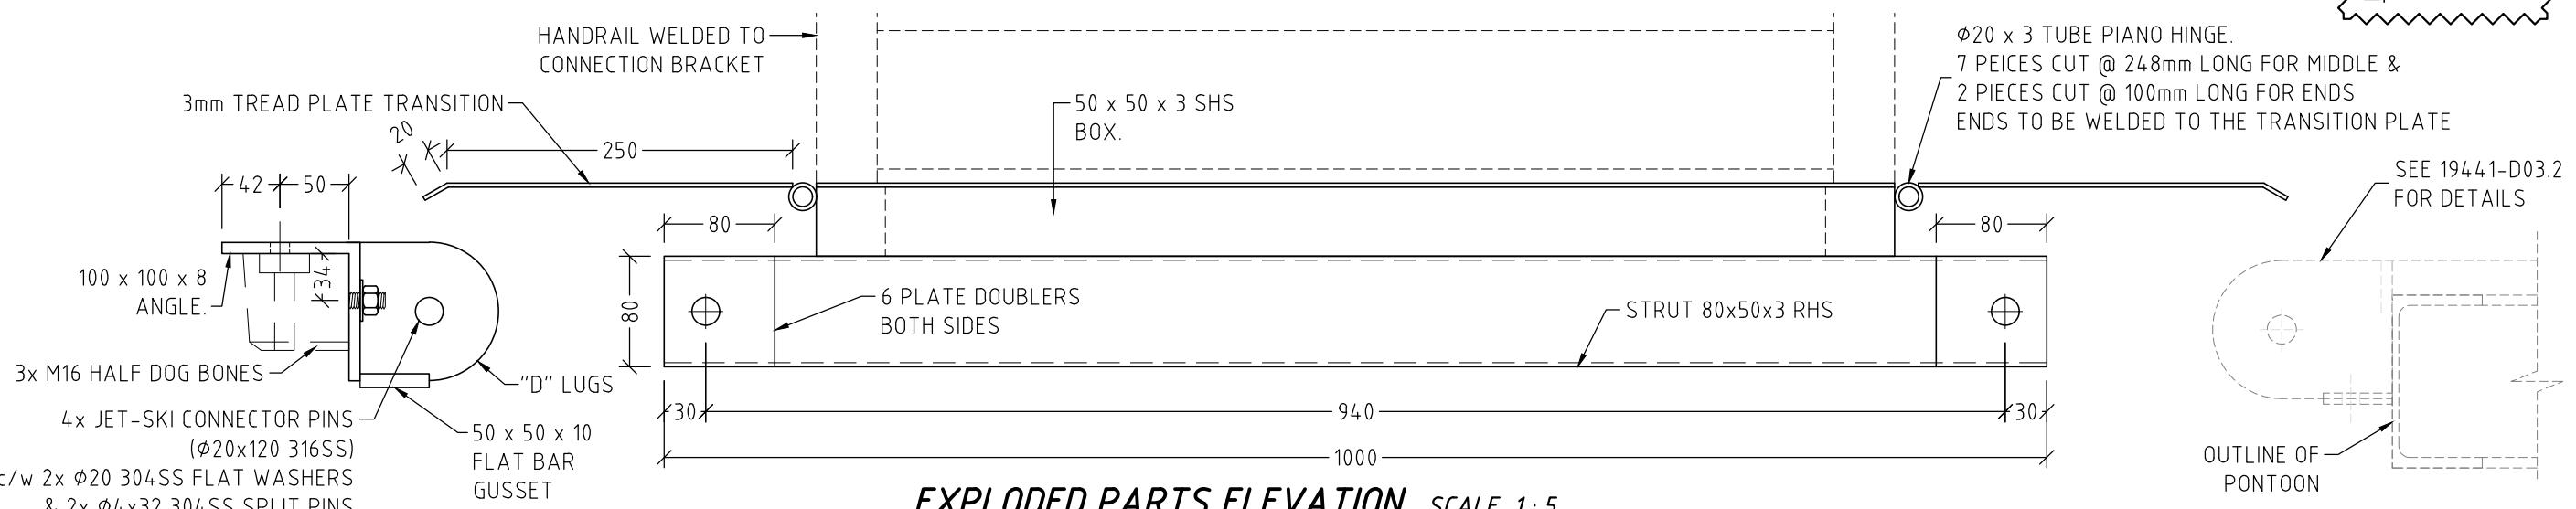


NO:	DATE	REVISION	DRAWN BY

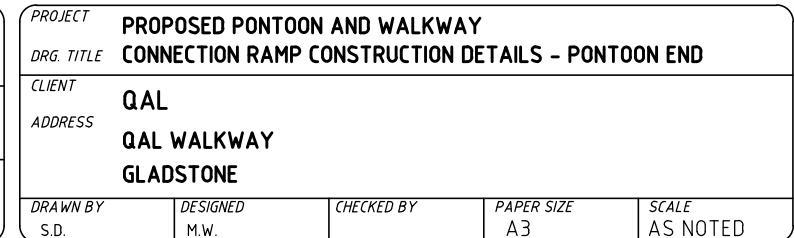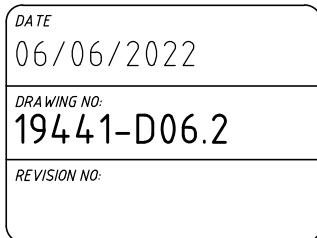


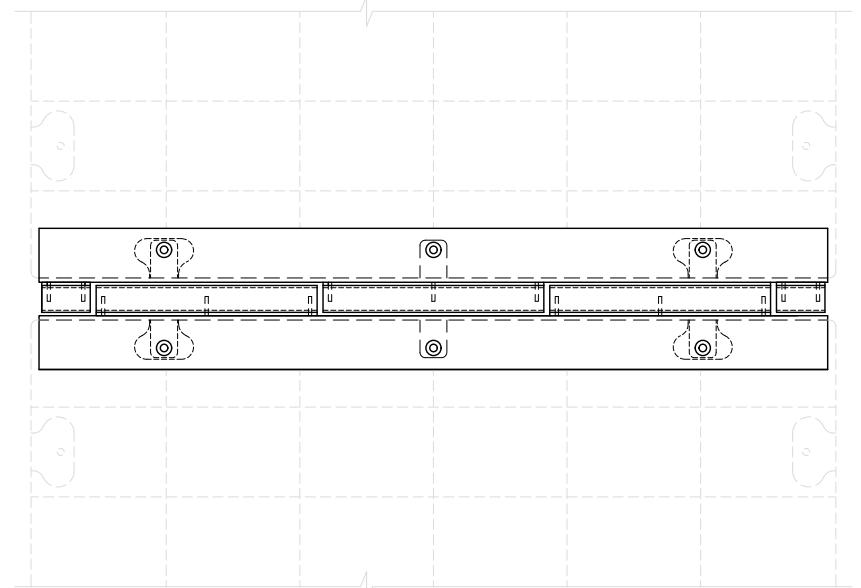

PLAN ASSEMBLED SCALE 1: 15

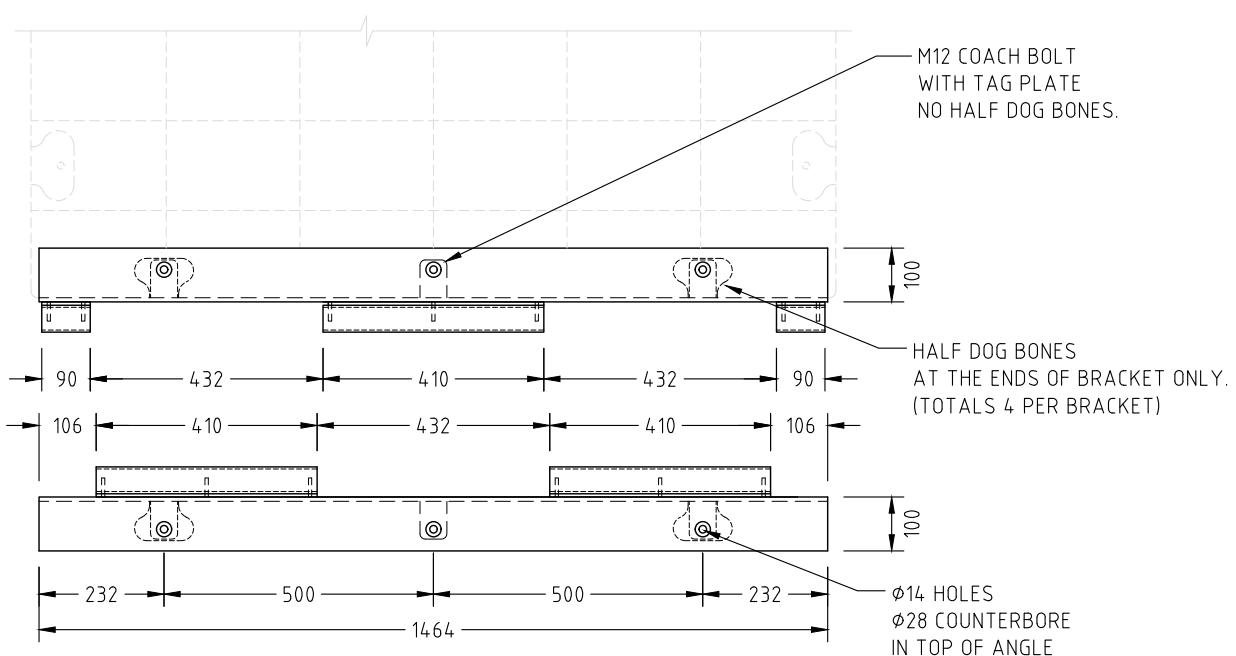


PLAN ASSEMBLED SCALE 1: 15

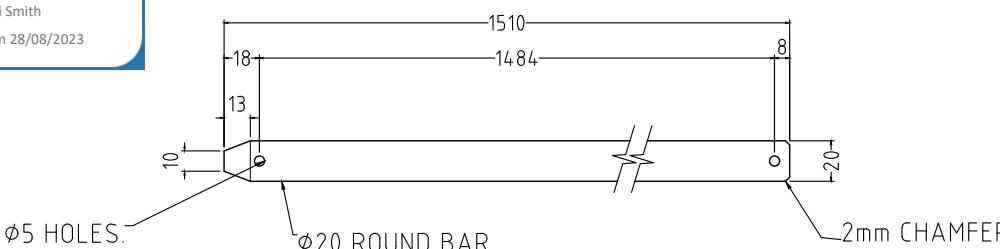


BAR PIN DETAIL SCALE 1: 2


5 ONLY REQUIRED

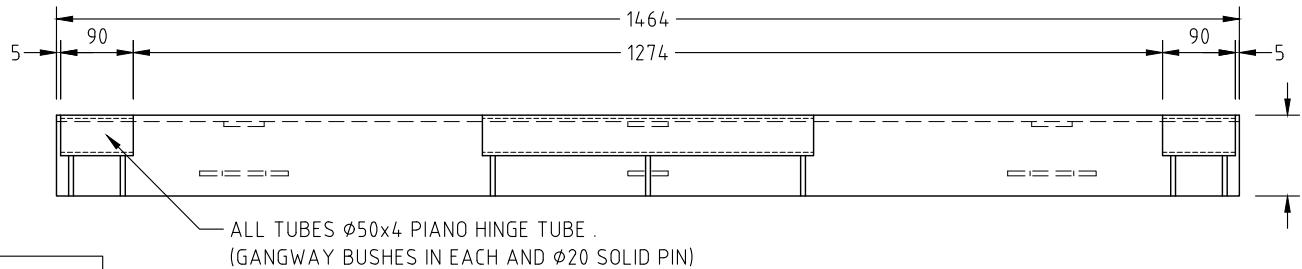


FRONT ELEVATION (1 SIDE) SCALE 1: 10

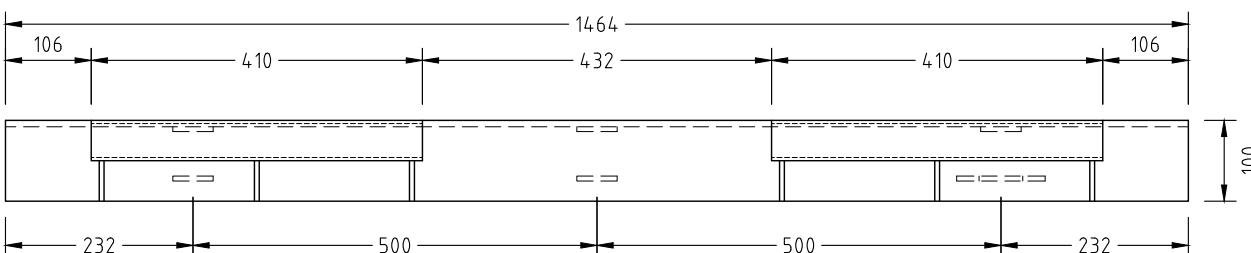


FRONT ELEVATION (OTHER SIDE) SCALE 1: 10

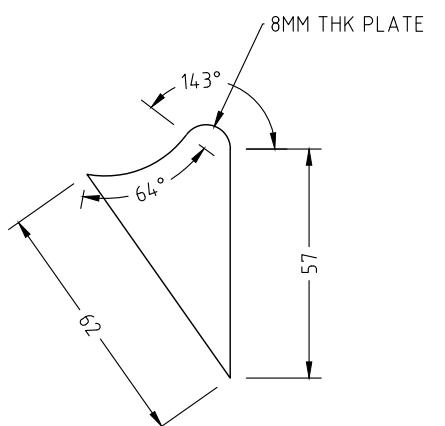


DETAIL 1 - GUSSET SCALE 1: 2

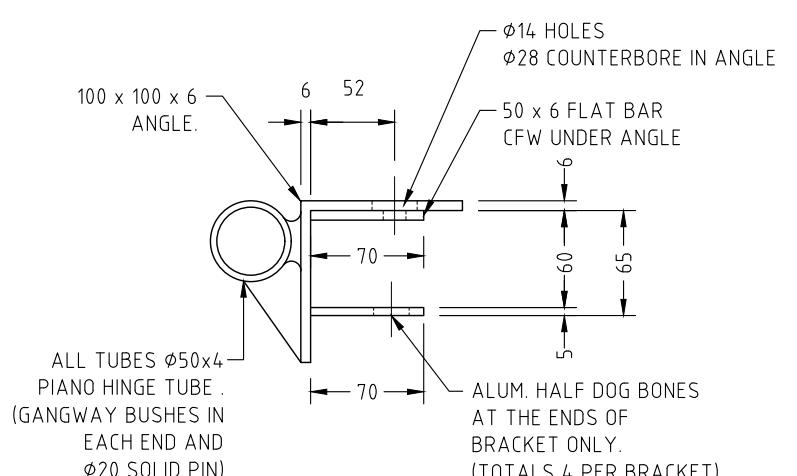

END ELEVATION SCALE 1: 5

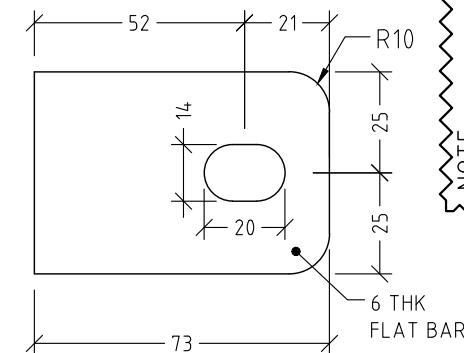

TAG PLATES SCALE 1: 2

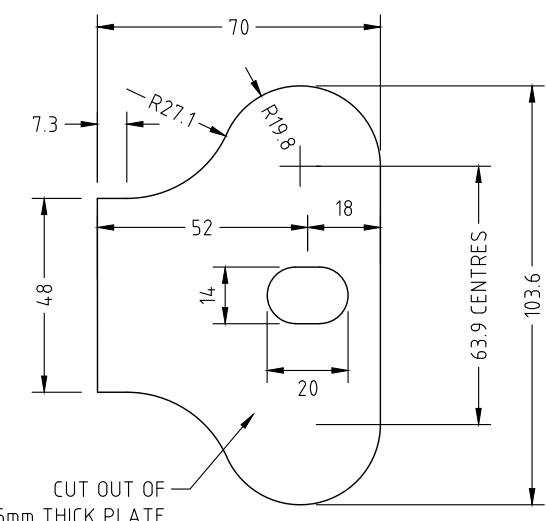

ALL Y HALF DOG BONES SCALE 1: 2

NOTE:

1. ALL COMPONENTS TO BE MARINE GRADE ALUMINUM TYP. U.N.O.
2. ALL DISSIMILAR METALS MUST BE SEPARATED USING ISOLATING WASHERS OR SLEEVES.
3. ALL FASTENERS TO BE 316 ST/S AND SECURED WITH LOCTITE THREADLOCK ADHESIVE (OR SIMILAR).
4. ALL MEMBERS TO BE WELDED WITH CONTINUOUS FILLET, TYP. U.N.O.





APPROVED

Name: Trudi Smith
Date: 2:51pm 28/08/2023

NOTE:

1. ALL COMPONENTS TO BE MARINE GRADE ALUMINIUM TYP. U.N.O.
2. ALL DISSIMILAR METALS MUST BE SEPARATED USING ISOLATING WASHERS OR SLEEVES.
3. ALL MEMBERS TO BE WELDED WITH CONTINUOUS FILLET, TYP. U.N.O.

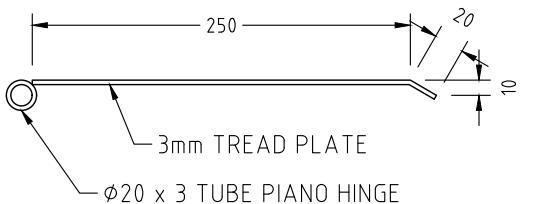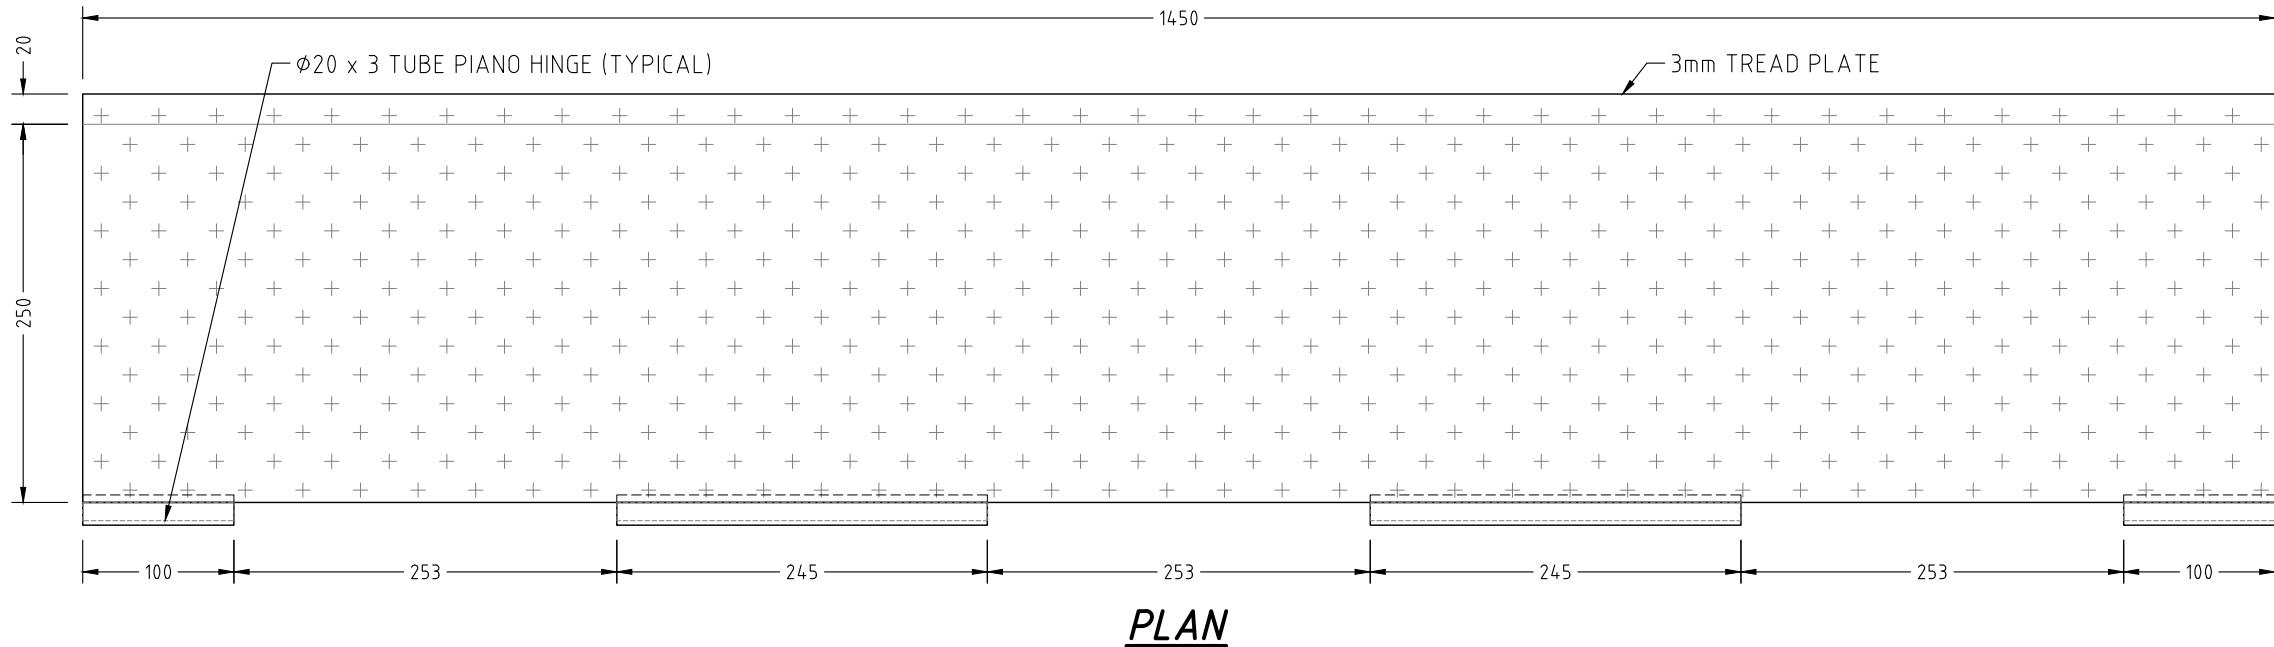


TRANSITION PLATE DETAIL

SCALE 1:5



No:	DATE	REVISION	DRAWN BY

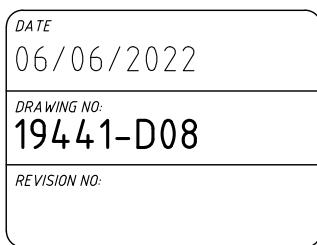


DRAWN BY S.D.	DESIGNED M.W.	CHECKED BY	PAPER SIZE A3	SCALE AS NOTED
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4 ONLY REQUIRED


CERTIFIED
Himenshu Nalindrajith
Praveen Moragaspitiya

RPEQ: 16451


8 ONLY REQUIRED

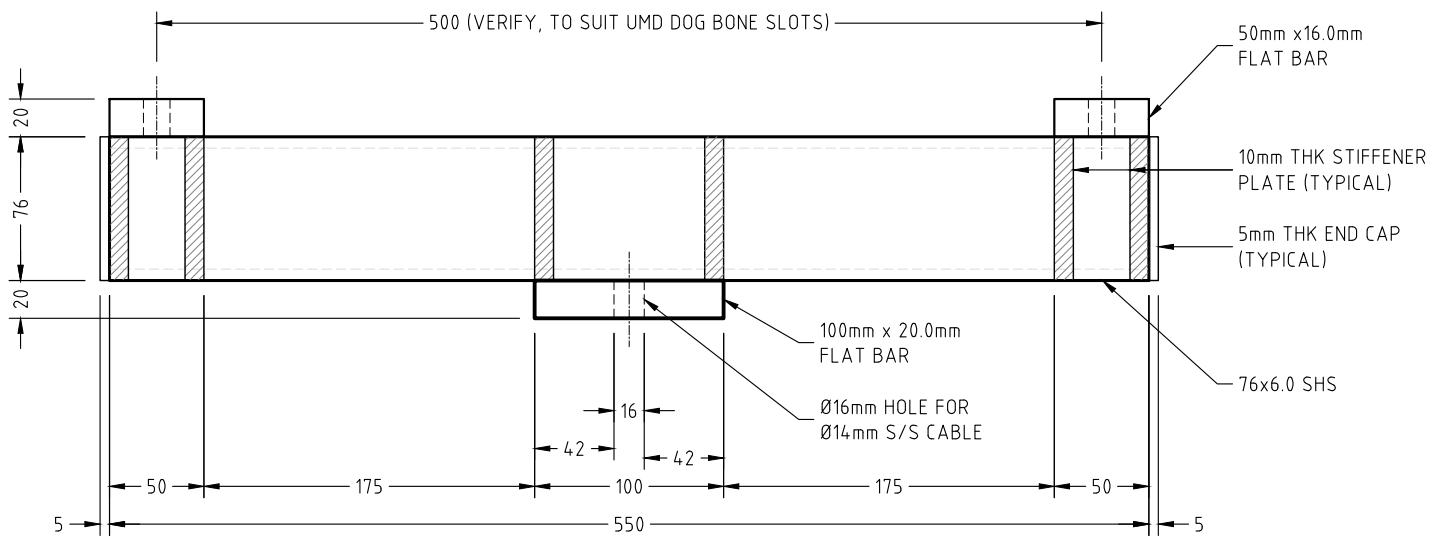

PLAN SCALE 1:4

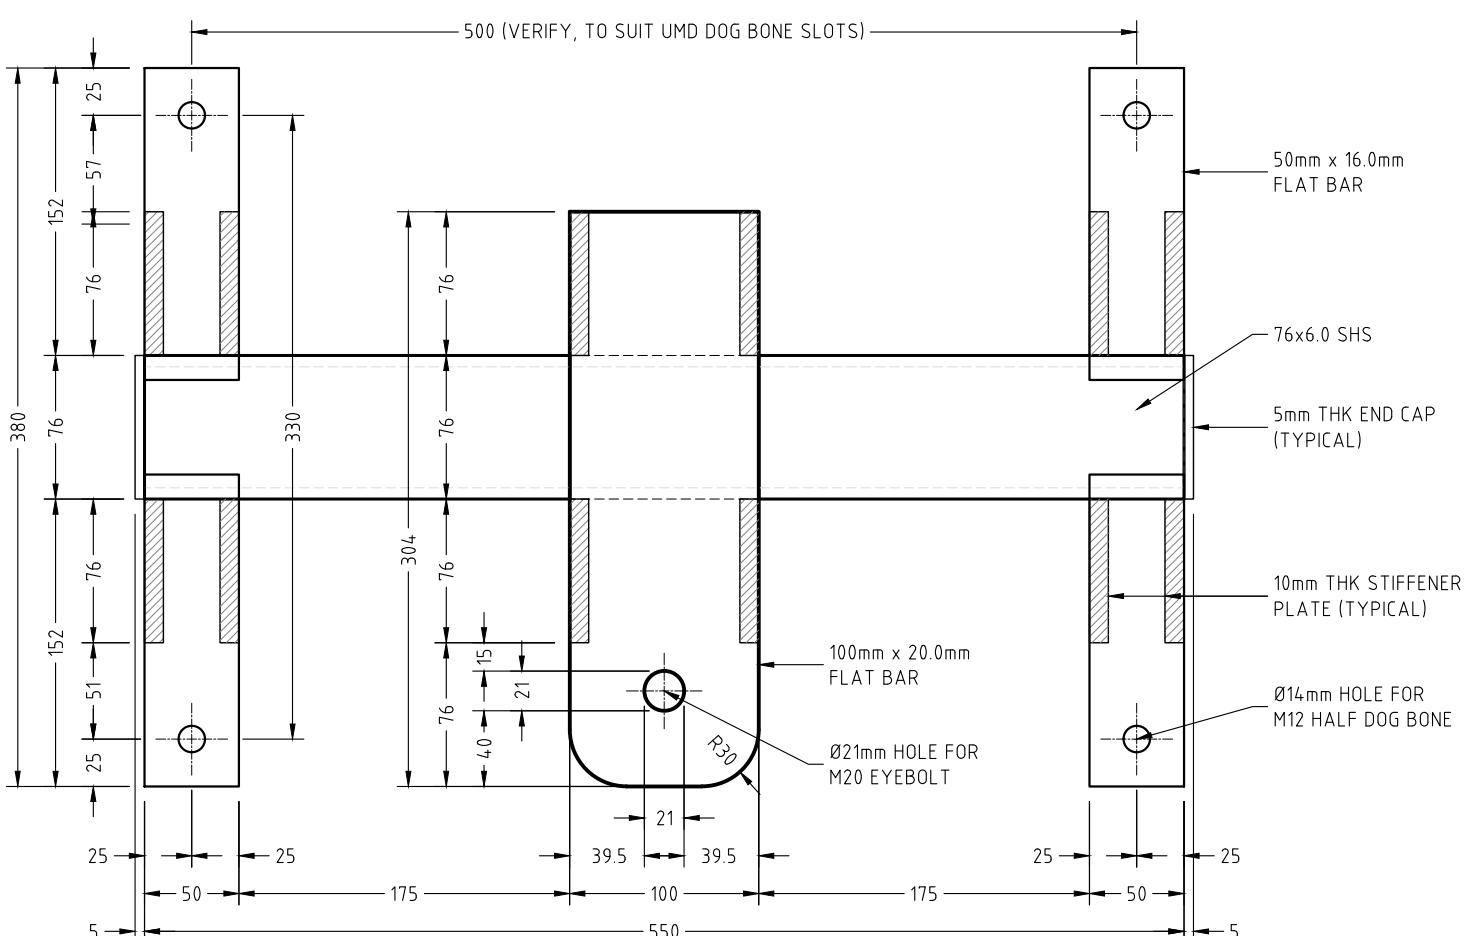

FRONT VIEW SCALE 1:4



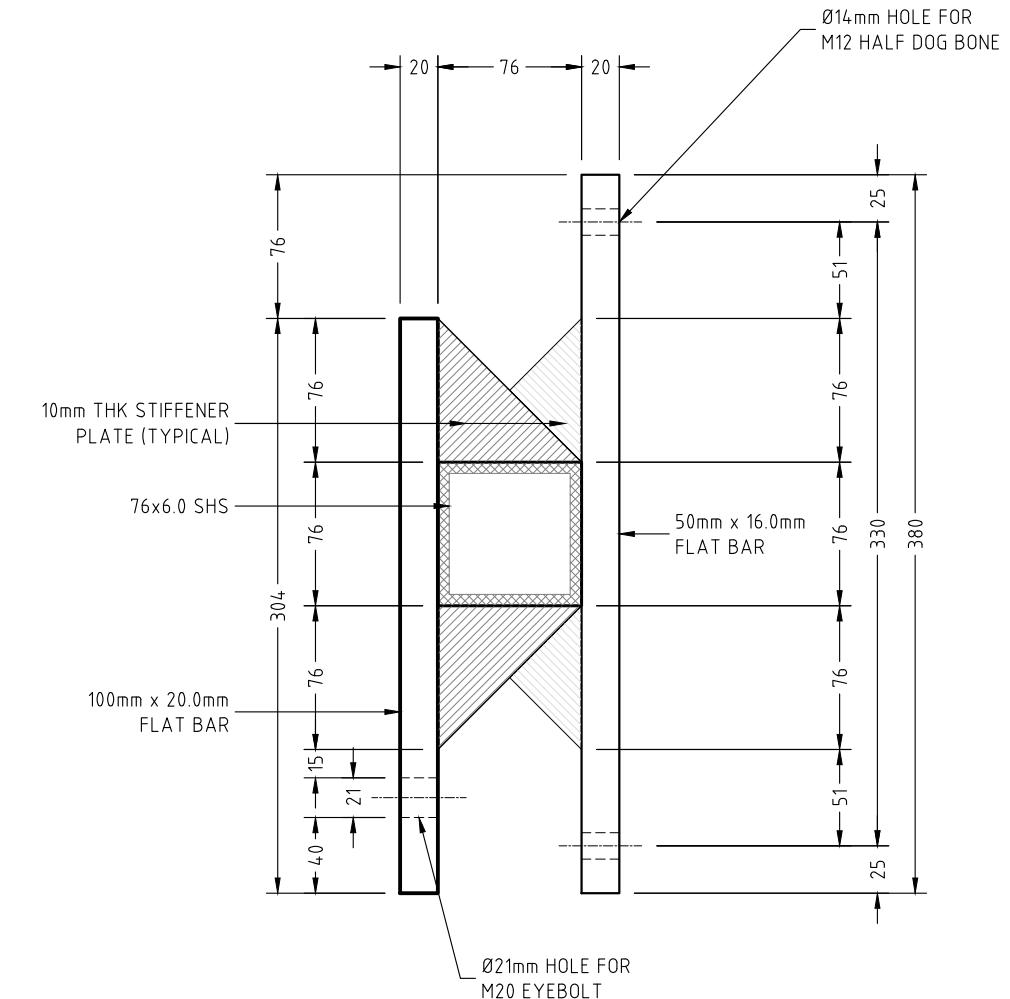



END VIEW SCALE 1:4






- NOTE:**
1. ALL COMPONENTS TO BE MARINE GRADE ALUMINIUM TYP. U.N.O.
 2. ALL DISSIMILAR METALS MUST BE SEPARATED USING ISOLATING WASHERS OR SLEEVES.
 3. ALL FASTENERS TO BE 316 ST/S AND SECURED WITH LOCTITE THREADLOCKING ADHESIVE (OR SIMILAR)
 4. ALL WELDS SHALL BE TYPE 5356


NO:	DATE	REVISION	DRAWN BY

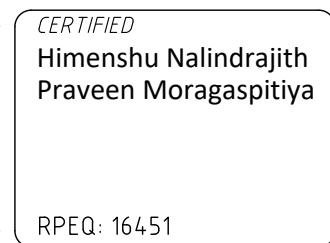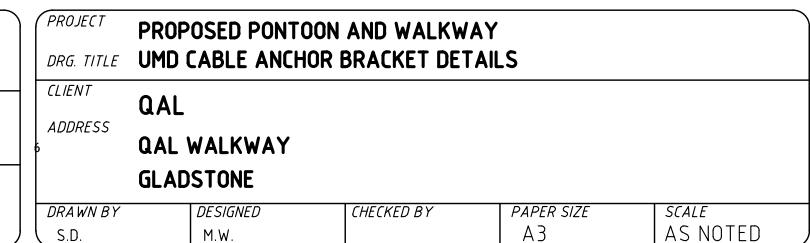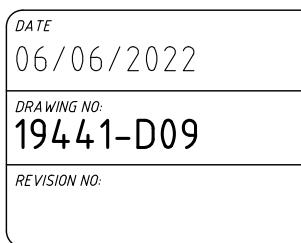

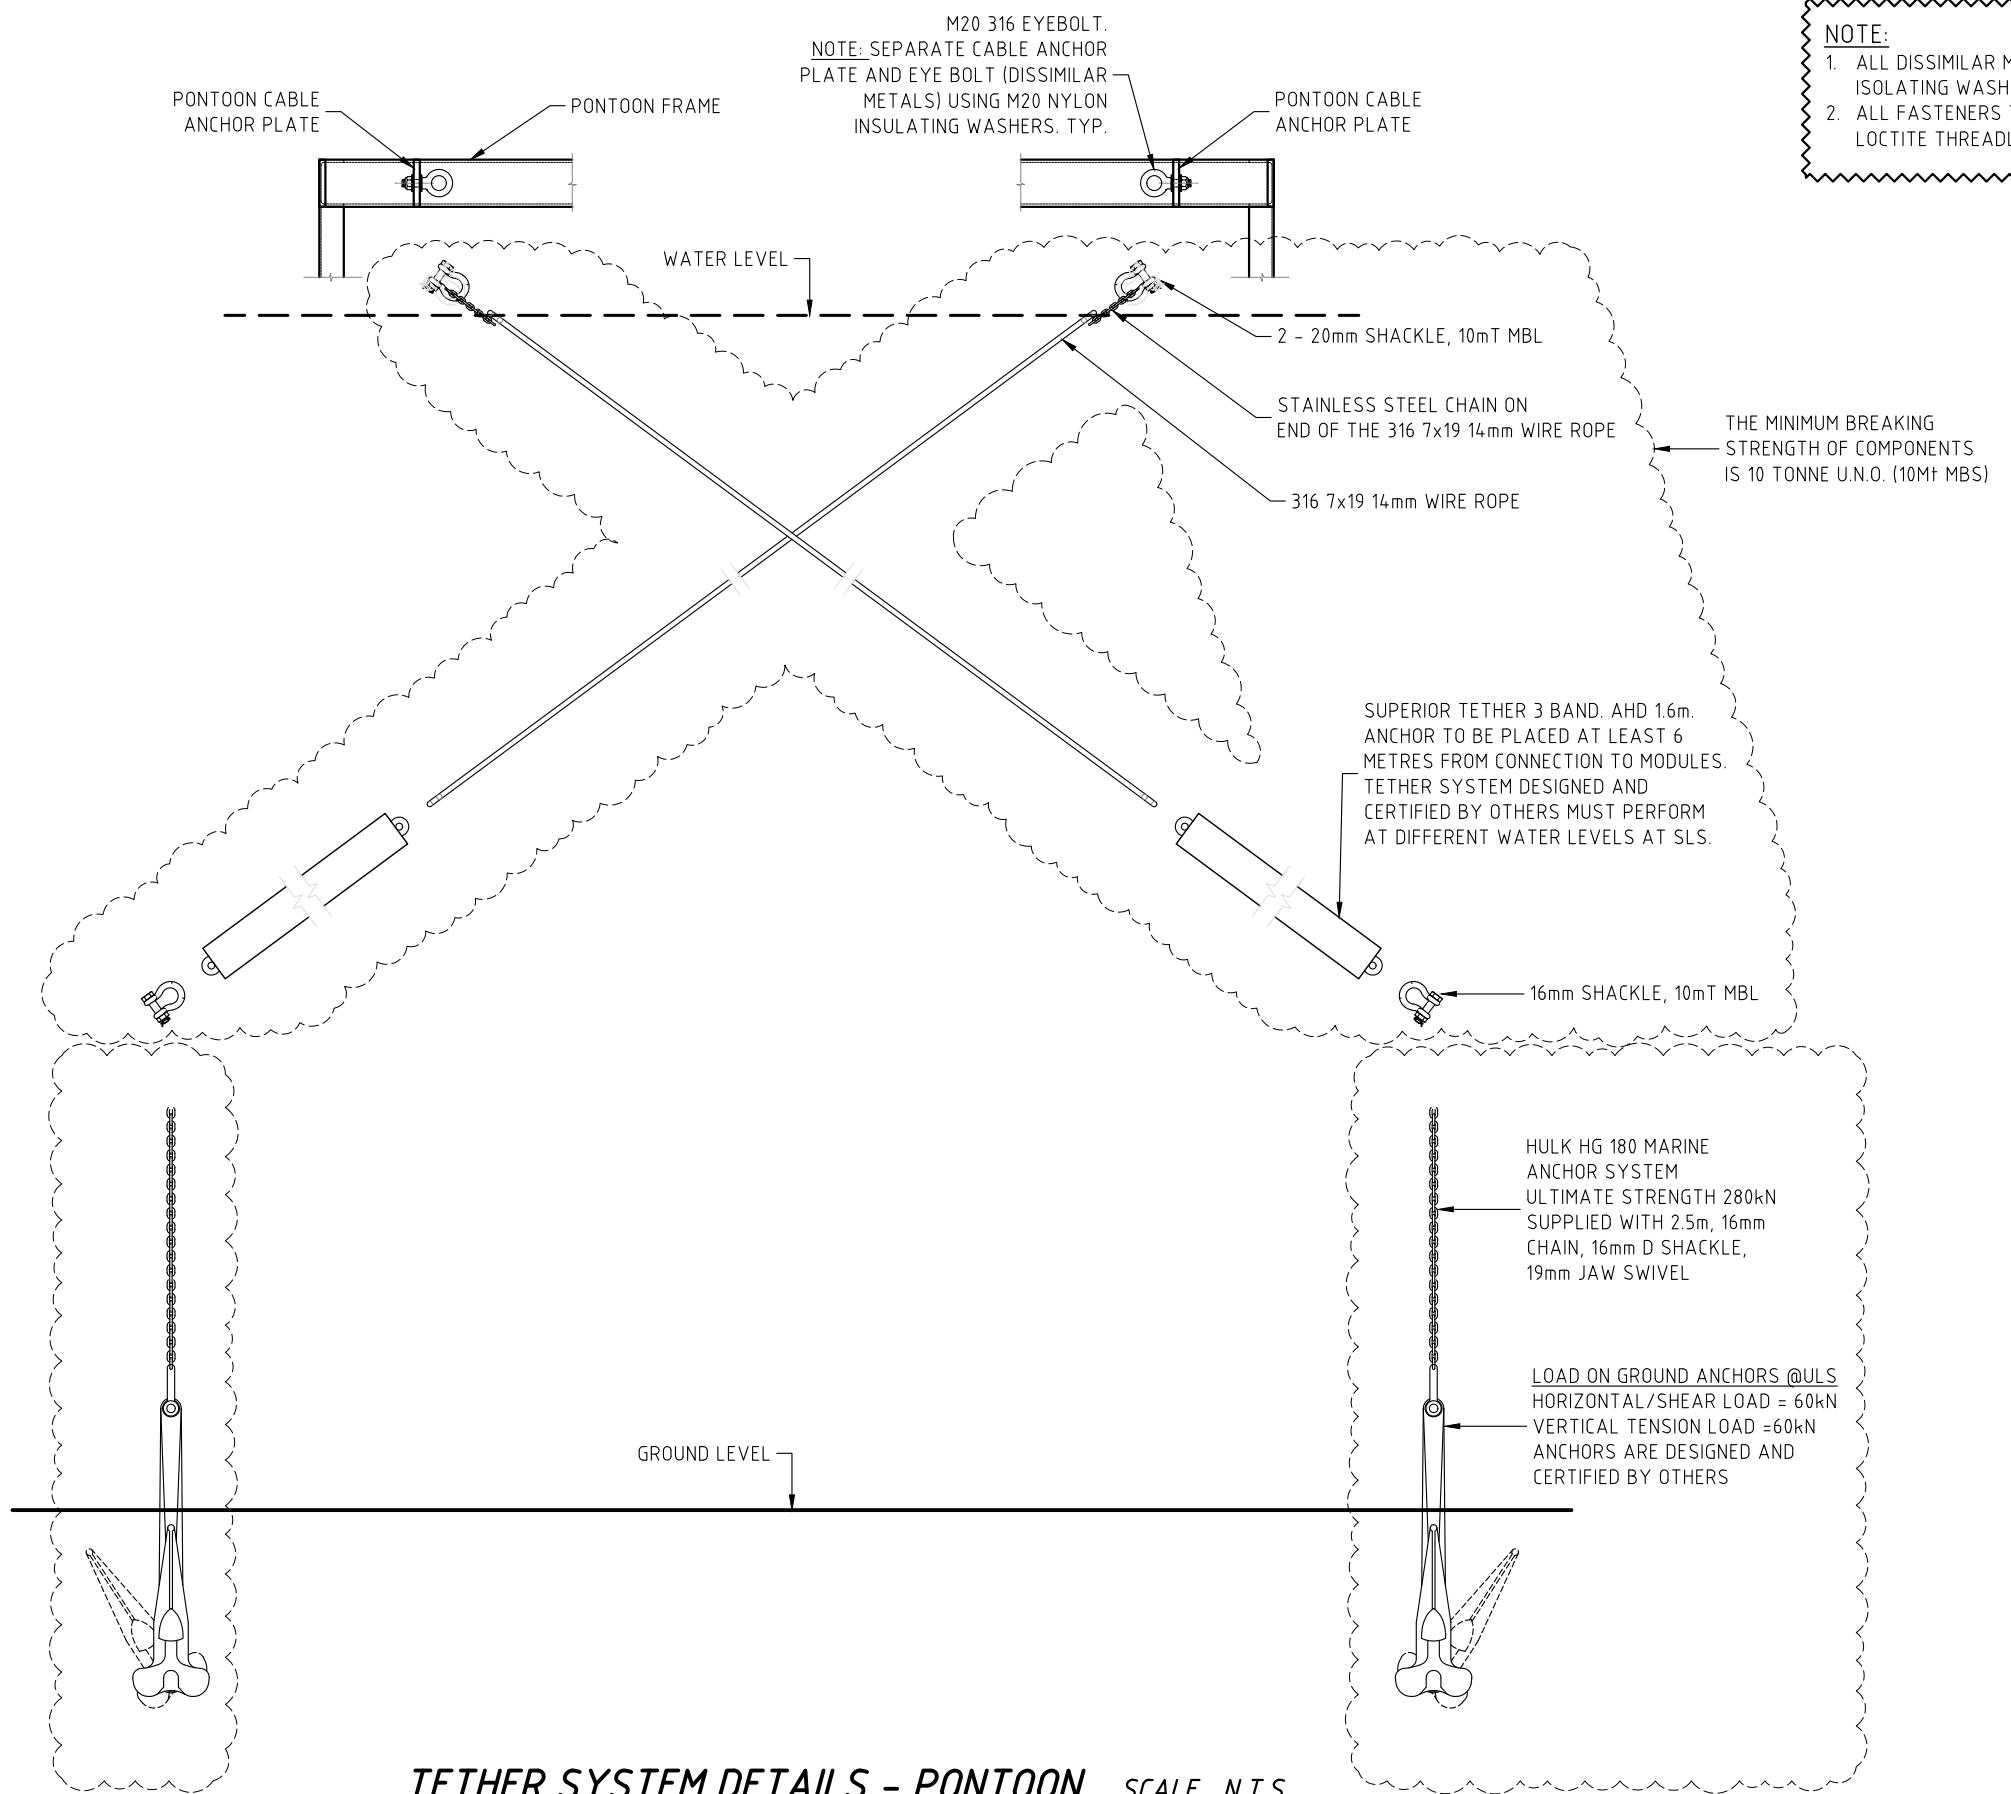


No:	DATE	REVISION	DRAWN BY

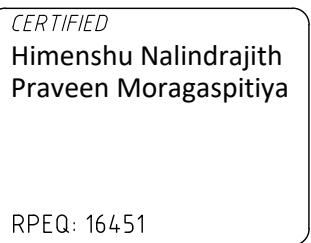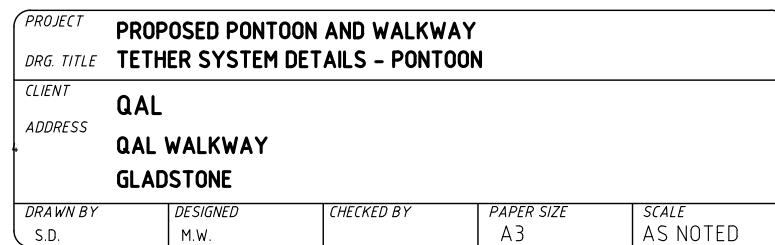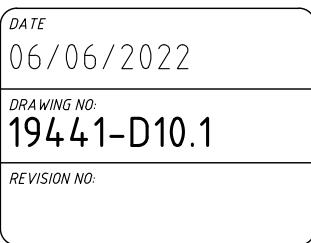

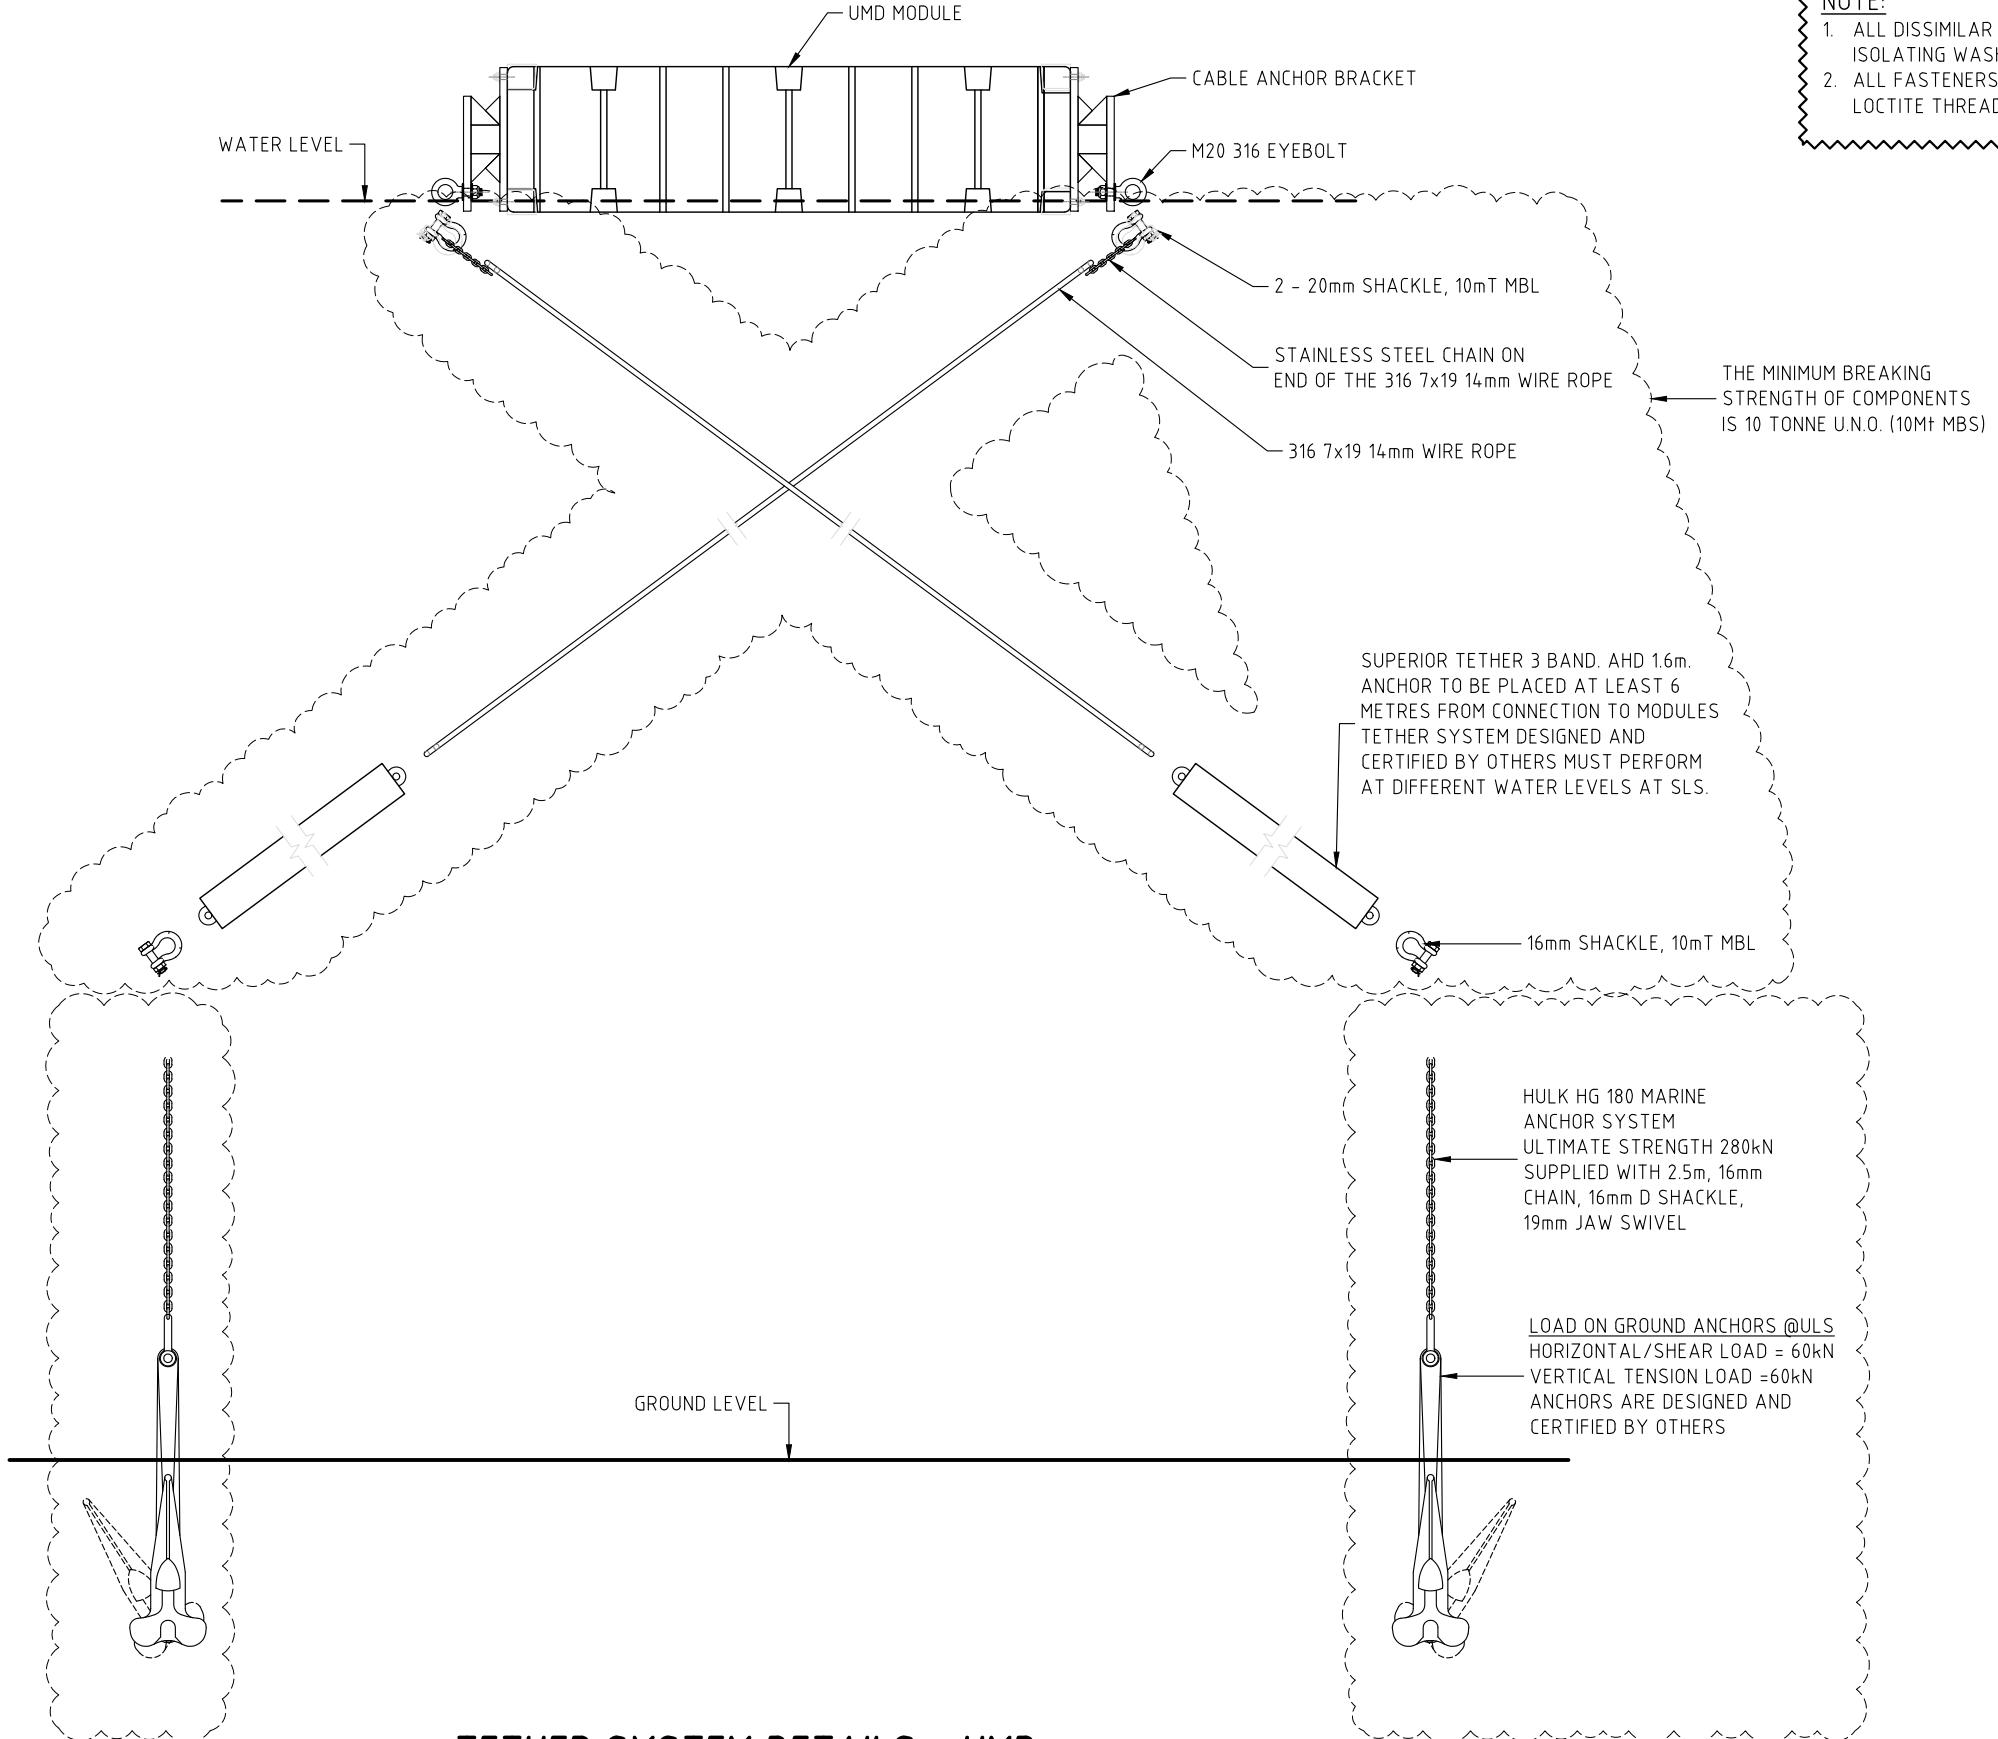

TETHER SYSTEM DETAILS - UMD SCALE N.T.S.

No:	DATE	REVISION	DRAWN BY

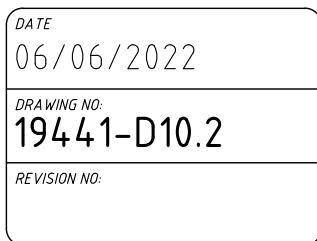

PROJECT DRG. TITLE PROPOSED PONTOON AND WALKWAY TETHER SYSTEM DETAILS - UMD

CLIENT ADDRESS QAL
QAL WALKWAY
GLADSTONE

DRAWN BY S.D.	DESIGNED M.W.	CHECKED BY	PAPER SIZE A3	SCALE AS NOTED
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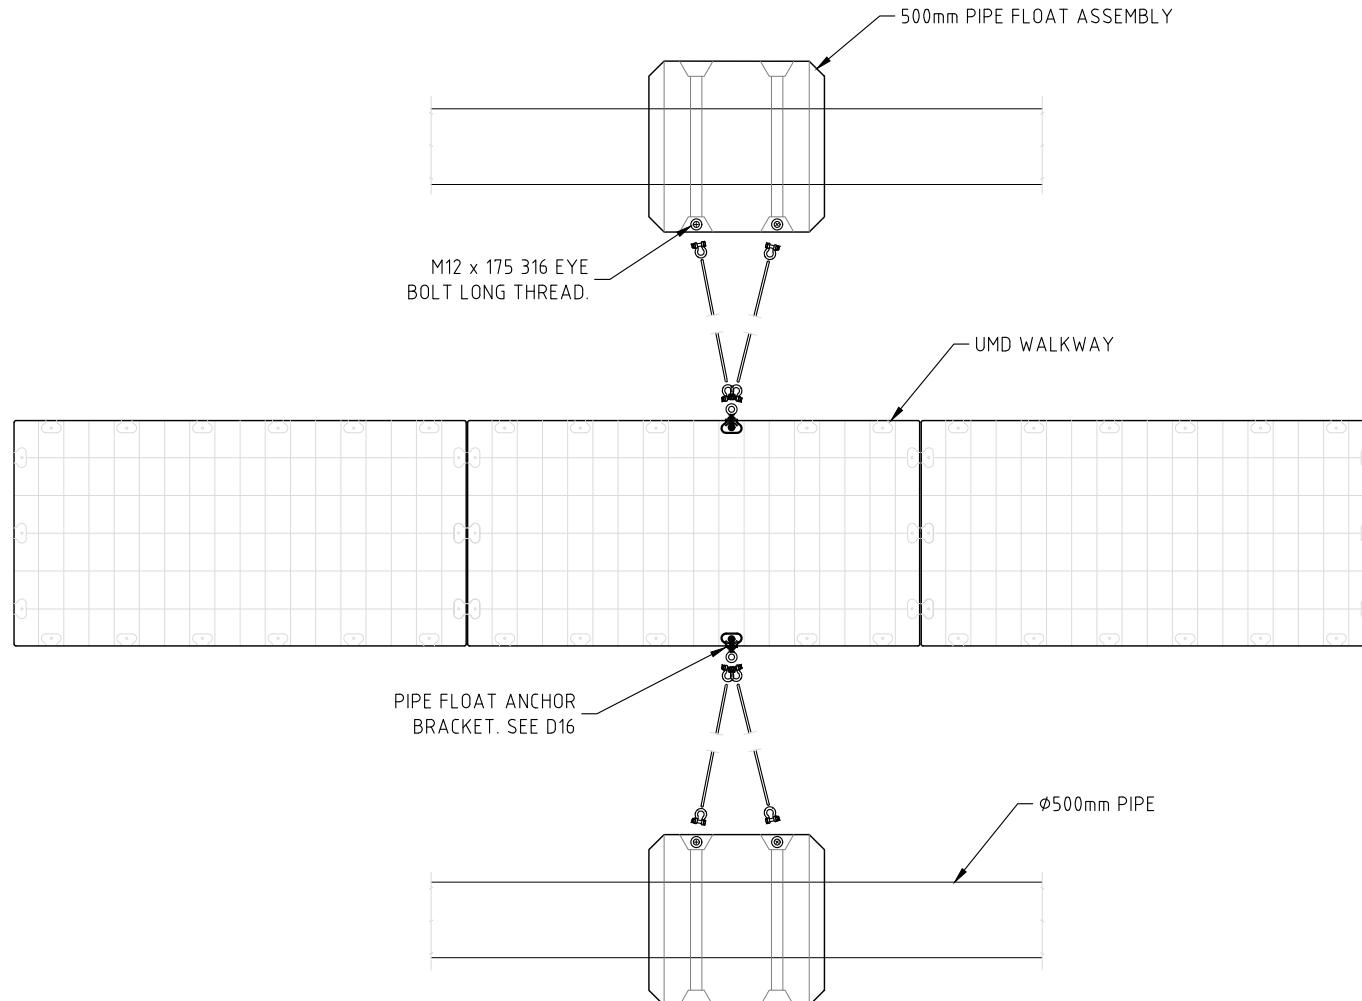
CERTIFIED
Himenshu Nalindrajith
Praveen Moragaspitiya

RPEQ: 16451



APPROVED


Name: Trudi Smith
Date: 2:52pm 28/08/2023



NOTE:

1. ALL DISSIMILAR METALS MUST BE SEPARATED USING ISOLATING WASHERS OR SLEEVES.
2. ALL FASTENERS TO BE 316 ST/S AND SECURED WITH LOCTITE THREADLOCKING ADHESIVE (OR SIMILAR)



PLAN SCALE 1:50

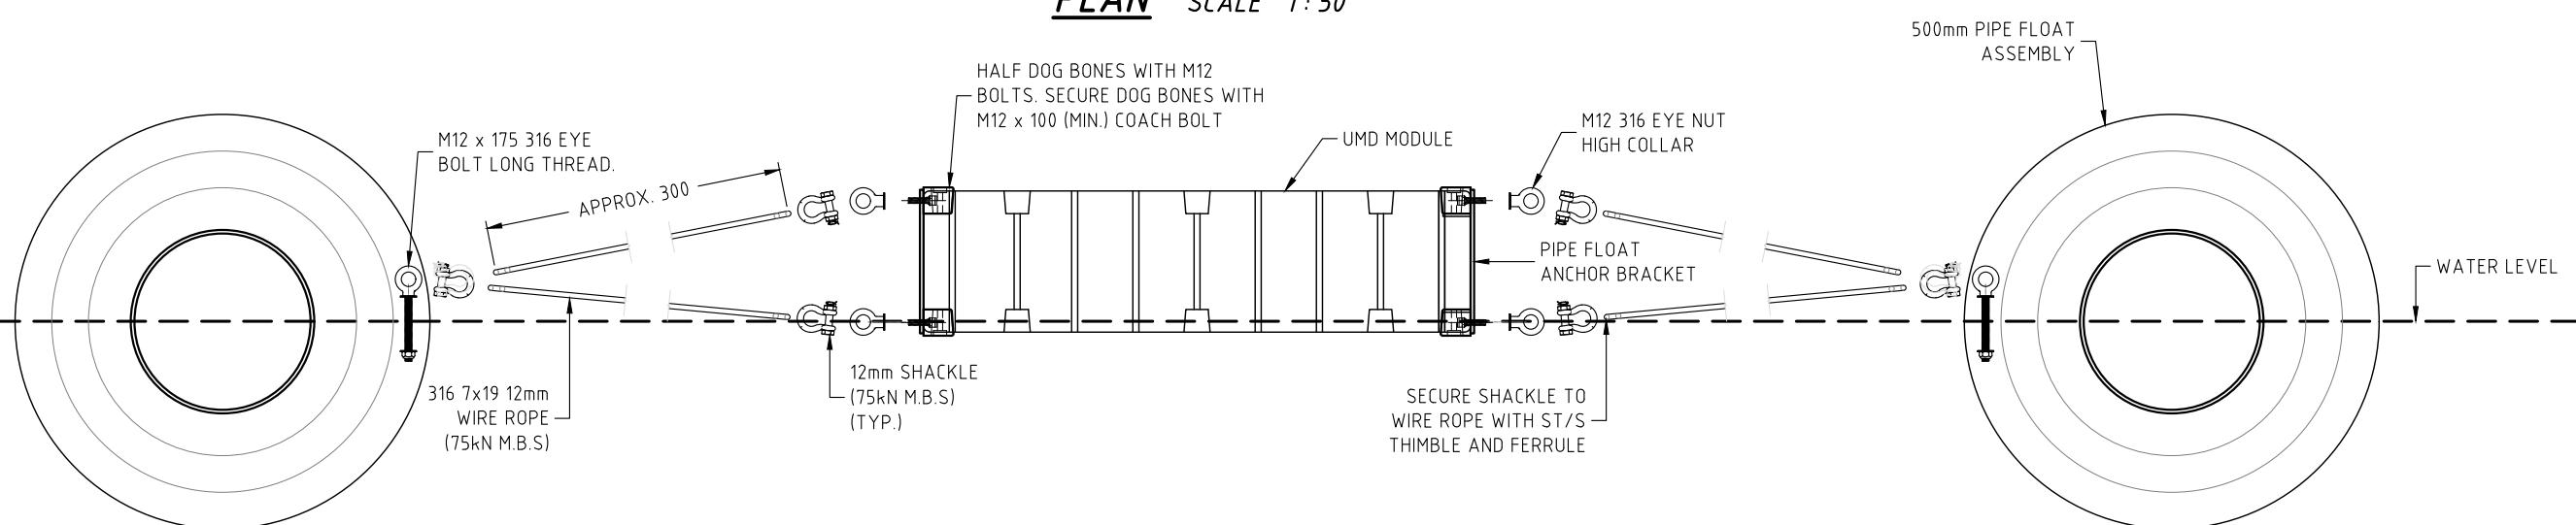





ELEVATION SCALE 1:20

TYPICAL TETHER SYSTEM DETAILS (EXPLODED VIEW) - PIPE FLOAT

No:	DATE	REVISION	DRAWN BY

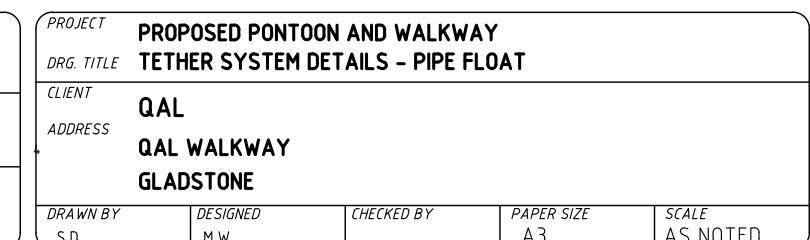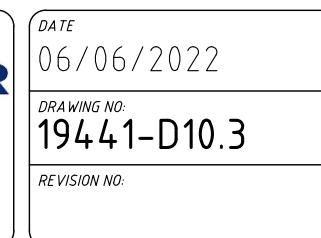



6 ONLY REQUIRED

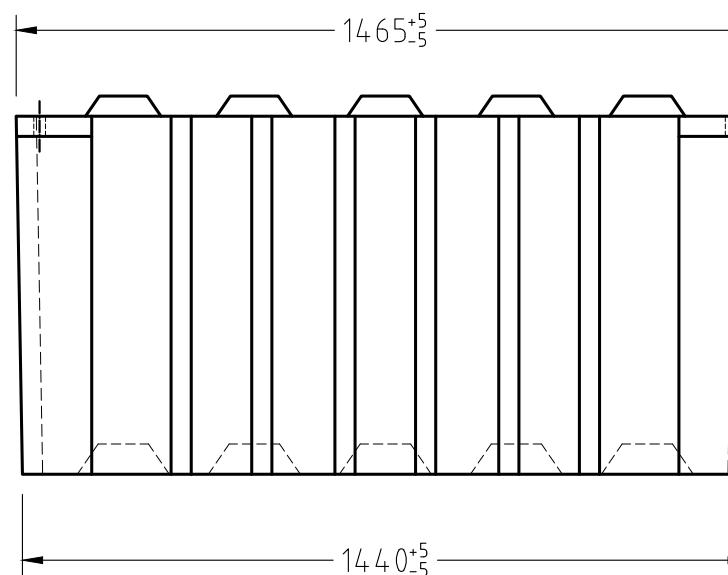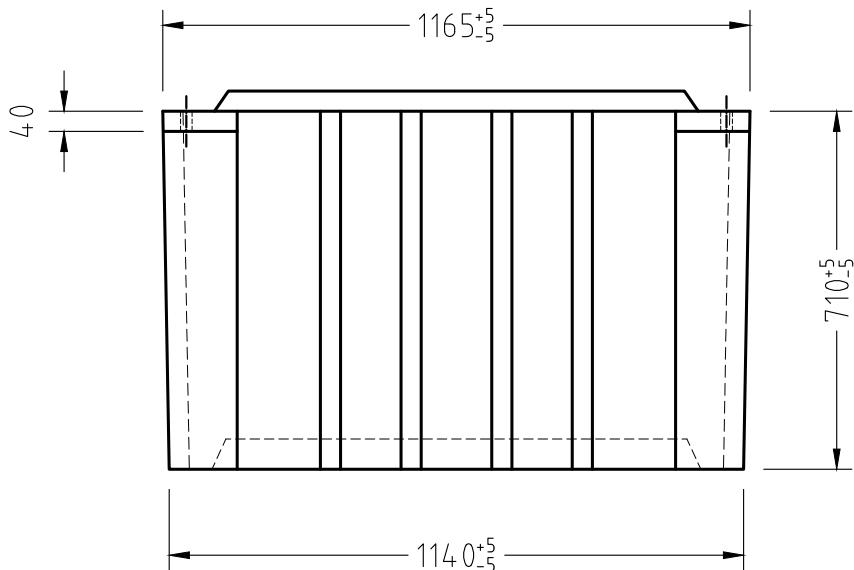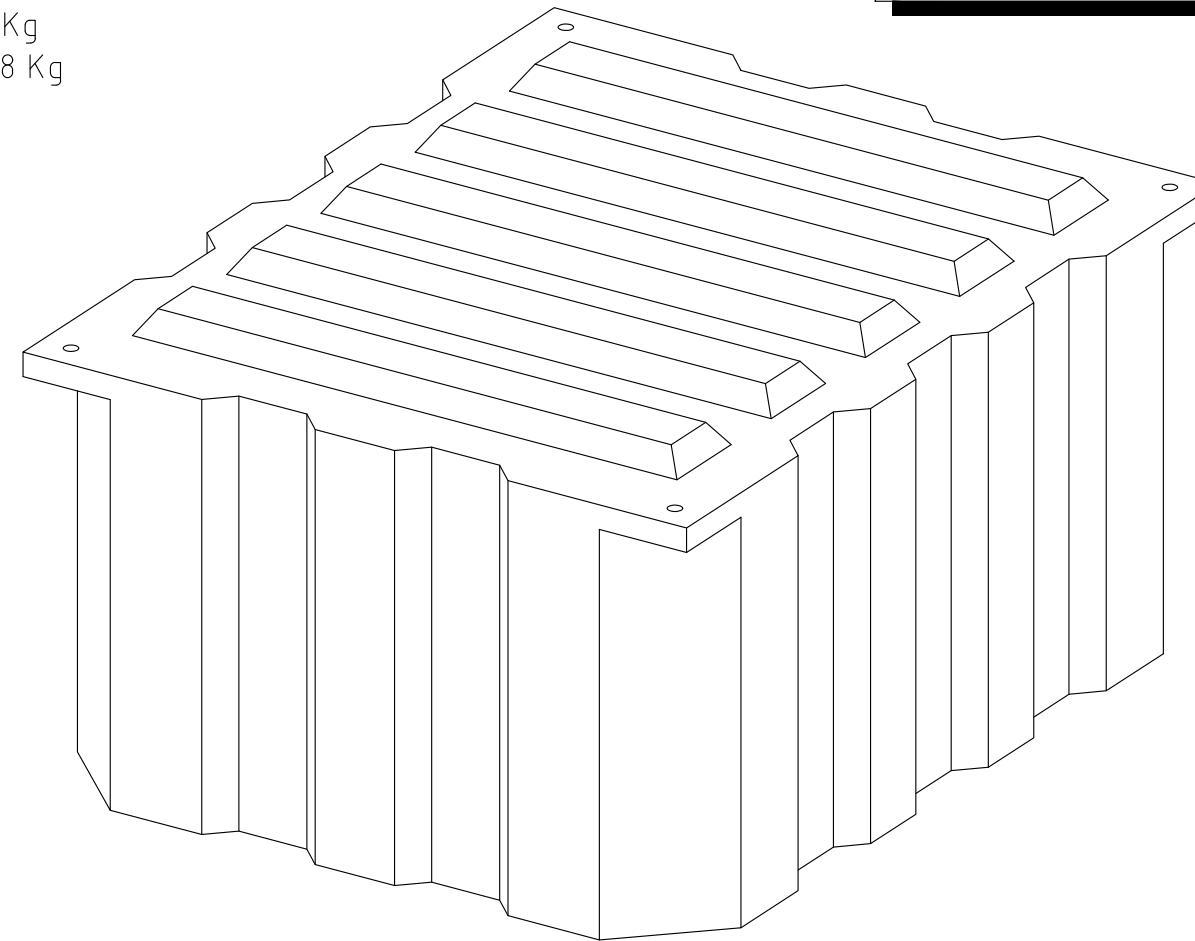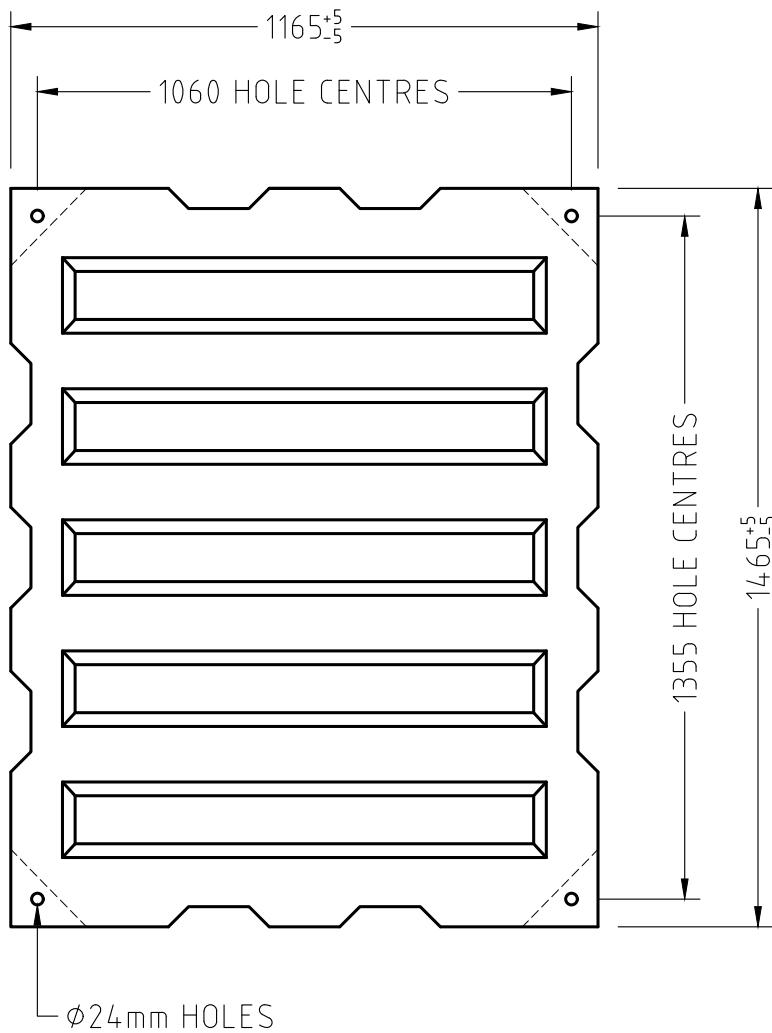

PLEASE NOTE:

DUE TO THE NATURE OF MOLDED PRODUCTS THERE
MAY BE A SLIGHT CONCAVE IN TOP OF FLOAT OF +/- 10mm

No.	DATE	REVISION	DRAWN BY


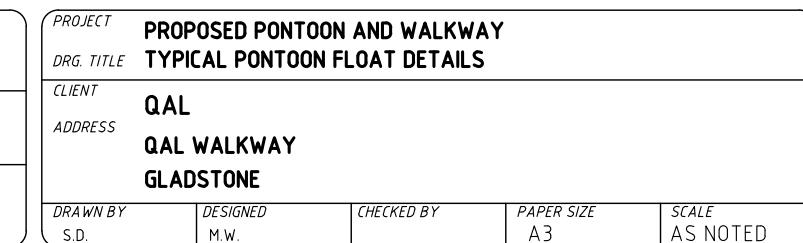
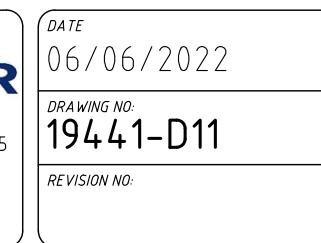


NOTES:

1. ALL DIMENSIONS ARE IN MILLIMETERS.
DIMENSIONS MAY VARY FROM THOSE INDICATED ON THIS DRAWING DUE
TO VARYING TEMPERATURES DURING THE ROTO-MOLDING PROCESS




2. FLOAT SPECIFICATIONS
- | | |
|-------------------------------------|--|
| FLOAT NAME: | 3.0m x 1.5m UMD MODULE |
| TOP DECK SLIP RESISTANCE | COMPLIES WITH AS-NZS 4586-2004 (CSIRO CERTIFIED) |
| MASS (DEAD LOAD) | 175 kg |
| APPROX DRAFT (DEAD LOAD) | 40mm |
| MAX. LIVE LOAD (EVENLY DISTRIBUTED) | 2.5 kPa (55mm RESERVE BUOYANCY) |
| APPROX DRAFT (DEAD & LIVE LOAD) | 340mm |

16 ONLY REQUIRED

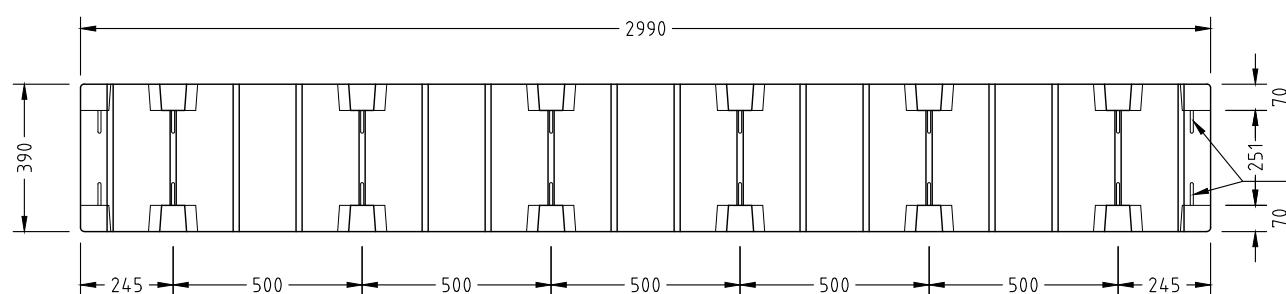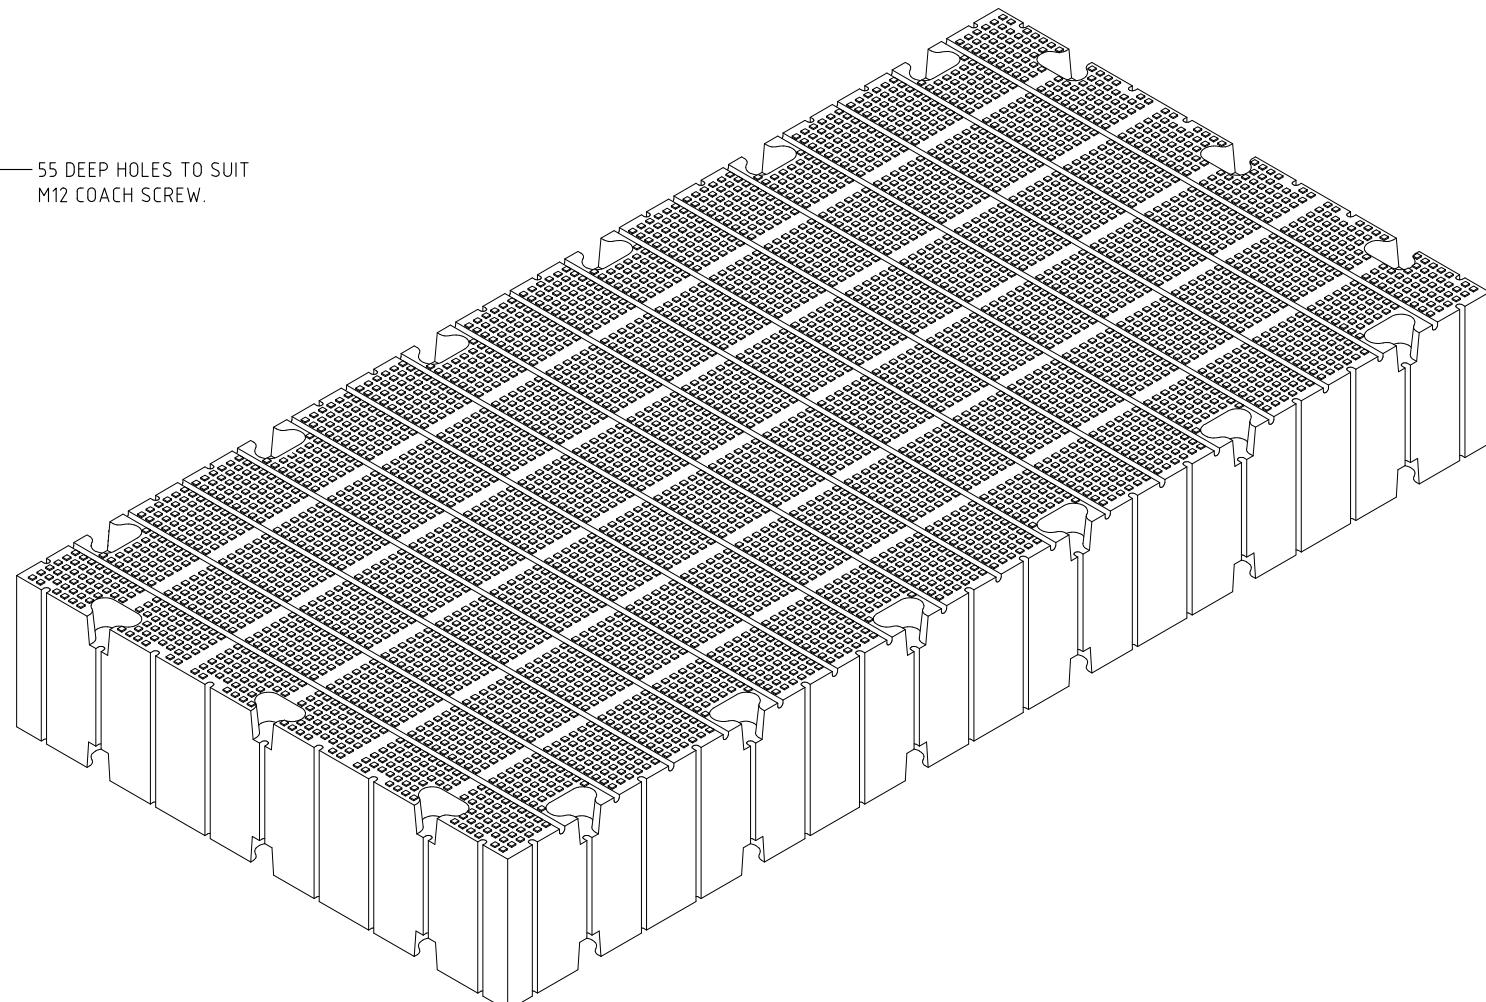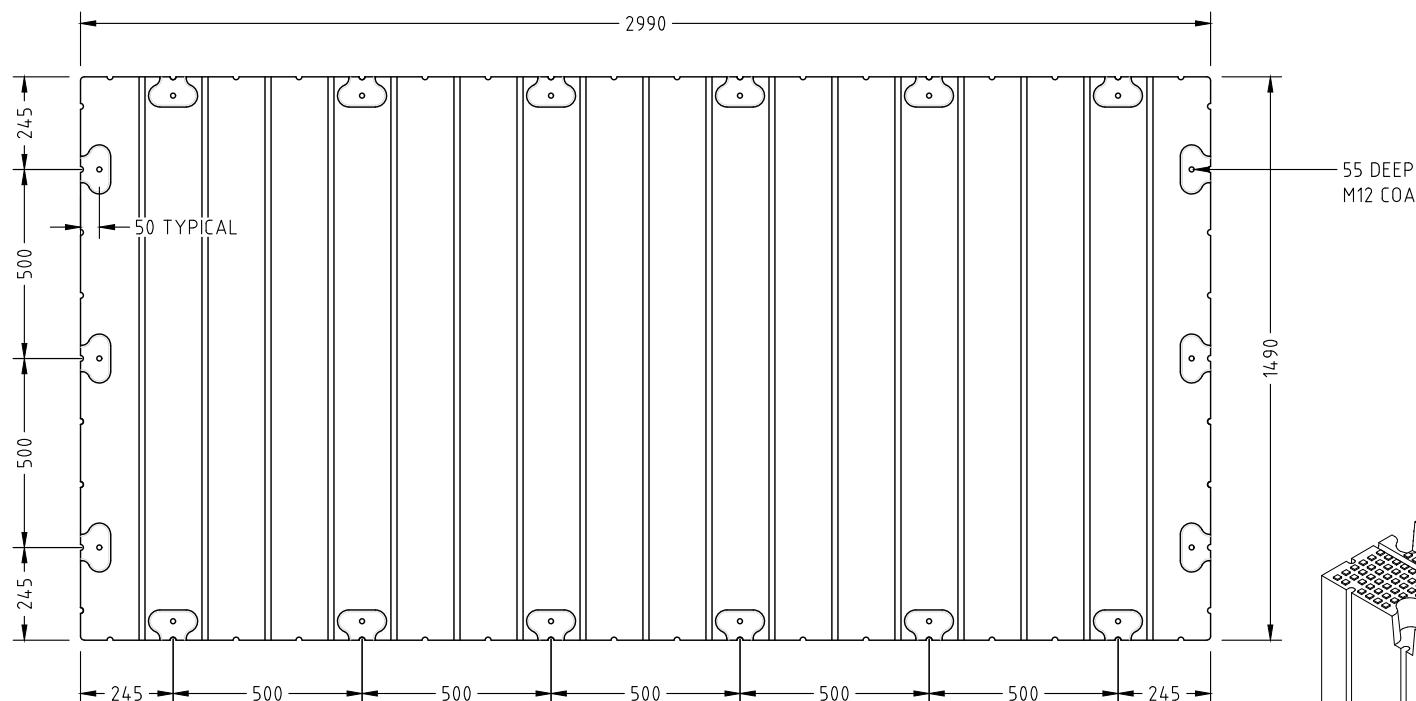





ALL INTERNAL & EXTERNAL CORNERS AND EDGES HAVE A RADIUS
OF VARYING DIMENSIONS AND ARE NOT SHOWN ON THIS DRAWING

NO.	DATE	REVISION	DRAWN BY

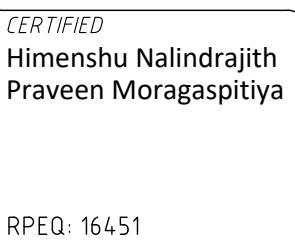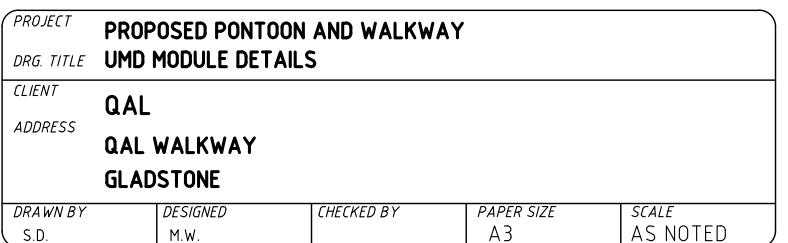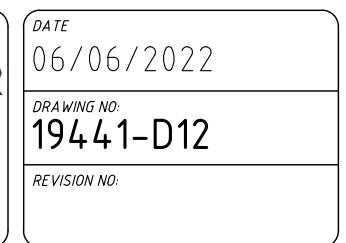


APPROVED

Name: Trudi Smith
Date: 2:53pm 28/08/2023

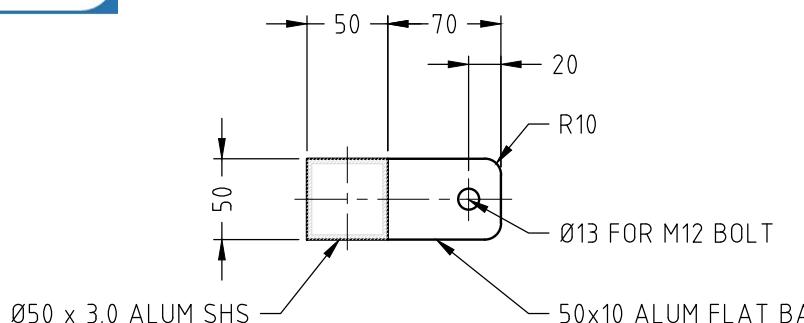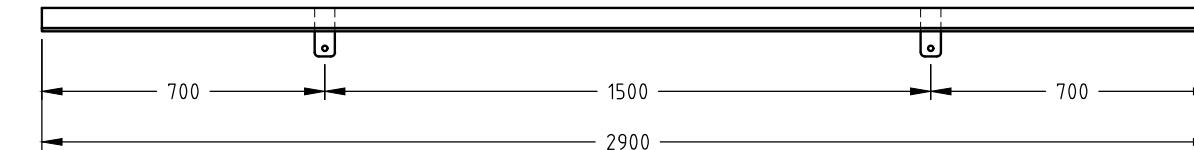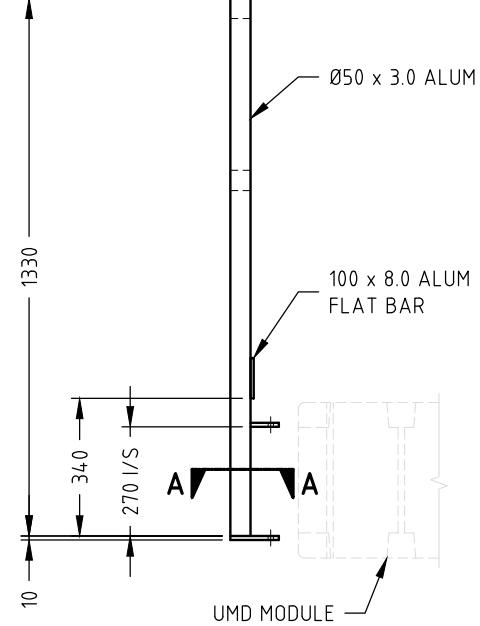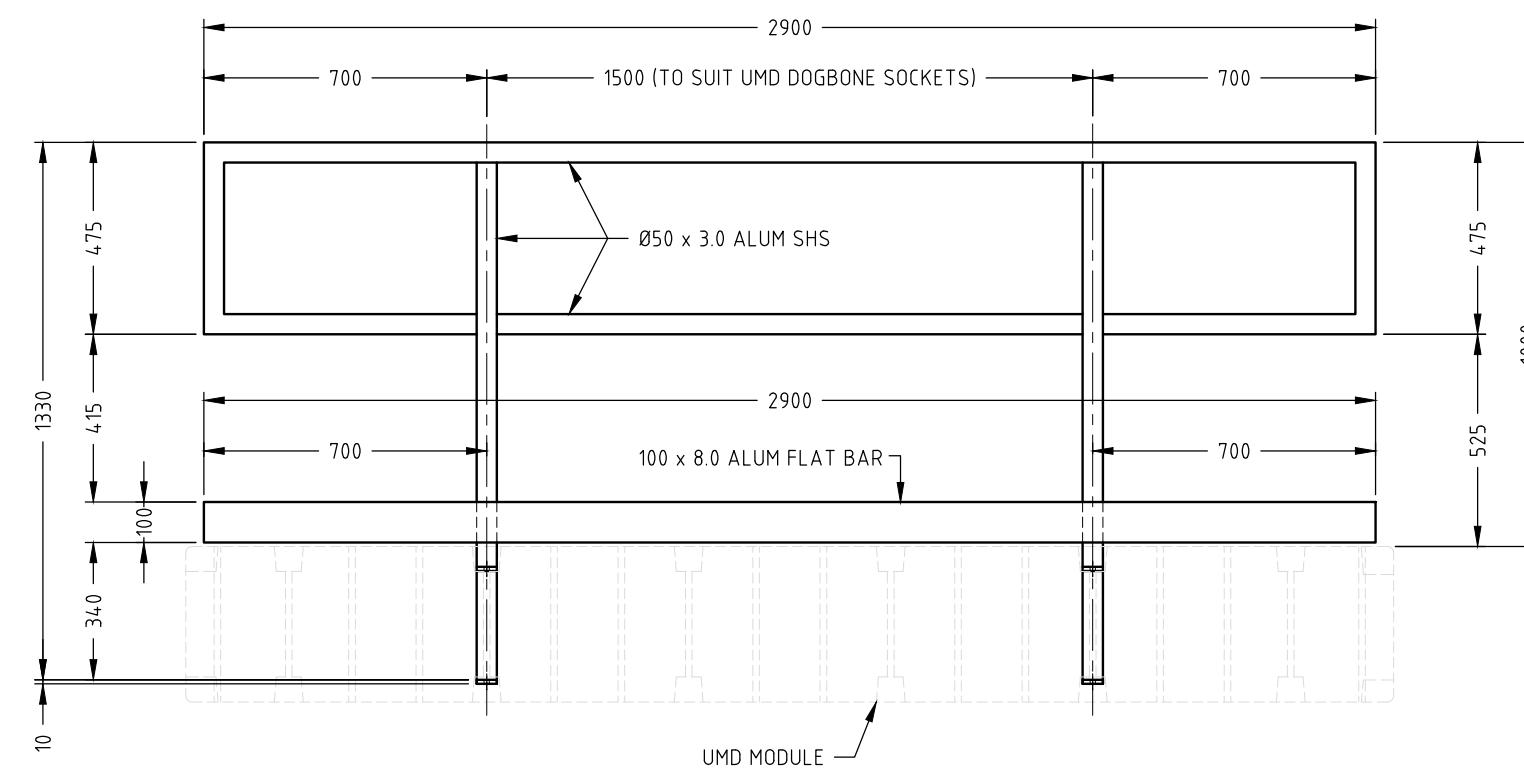
32 ONLY REQUIRED**SECTION A-A** SCALE 1: 20**PLAN VIEW** SCALE 1: 20**SIDE VIEW** SCALE 1: 20**FRONT VIEW** SCALE 1: 20**NOTE:**

1. ALL COMPONENTS TO BE MARINE GRADE ALUMINIUM TYP. U.N.O.
2. ALL DISSIMILAR METALS MUST BE SEPARATED USING ISOLATING WASHERS OR SLEEVES.
3. ALL FASTENERS TO BE 316 ST/S AND SECURED WITH LOCTITE THREADLOCKING ADHESIVE (OR SIMILAR)
4. ALL WELDS TO BE 4mm CFW U.N.O
5. HANDRAIL TO BE WELDED TO CONNECTION BRACKETS

NO:	DATE	REVISION	DRAWN BY

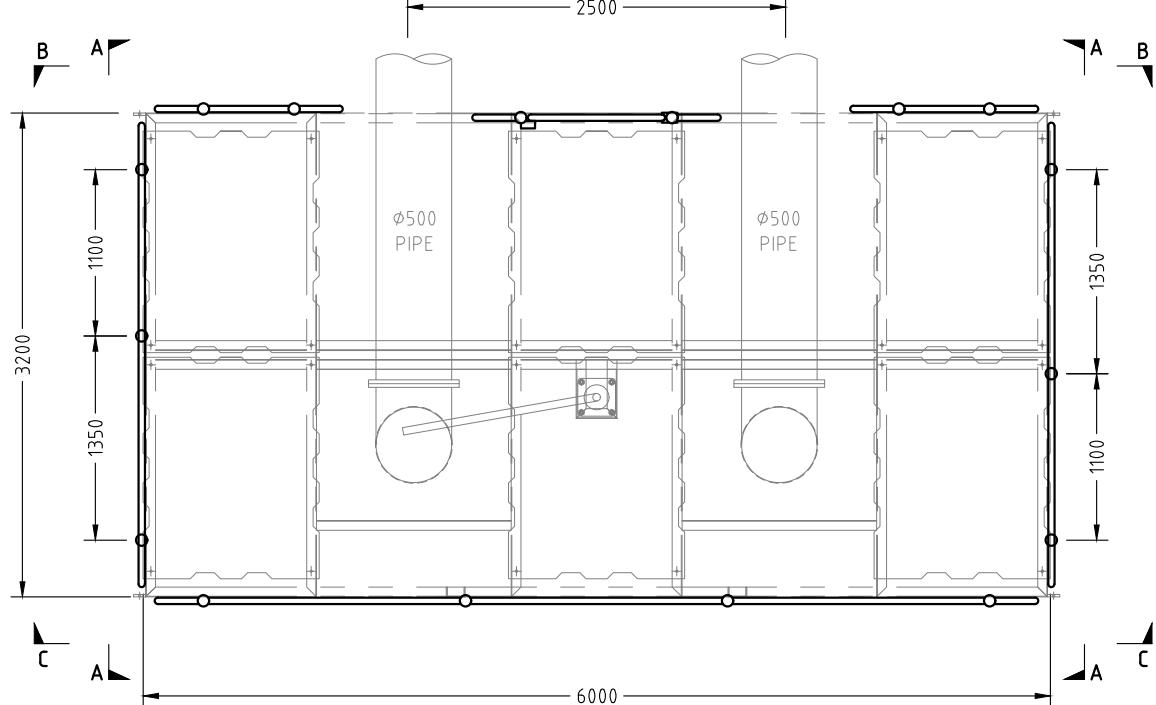


PLAN SCALE 1 : 50

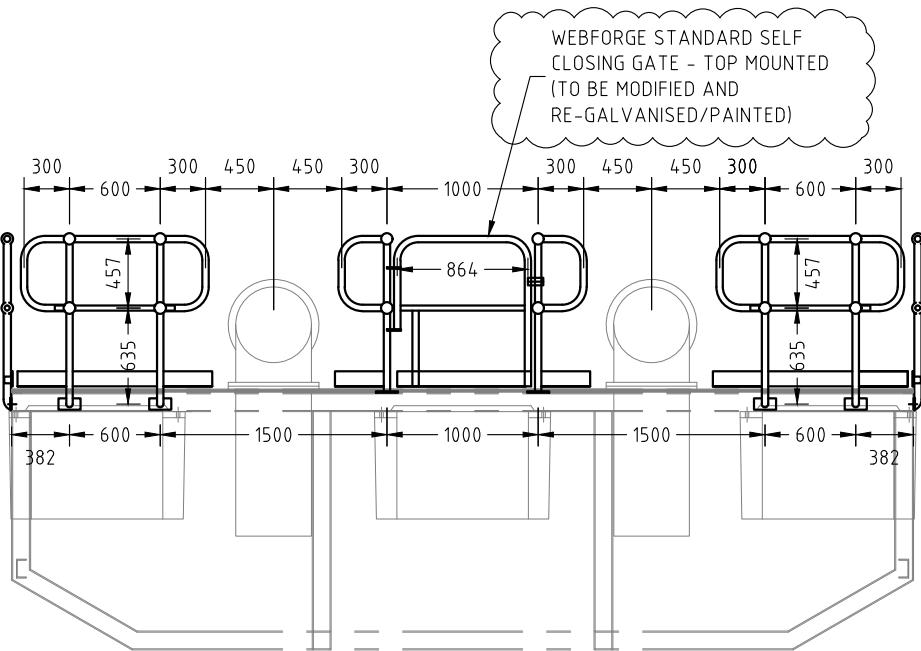

SECTION B-B SCALE 1 : 50




SECTION A-A SCALE 1 : 50

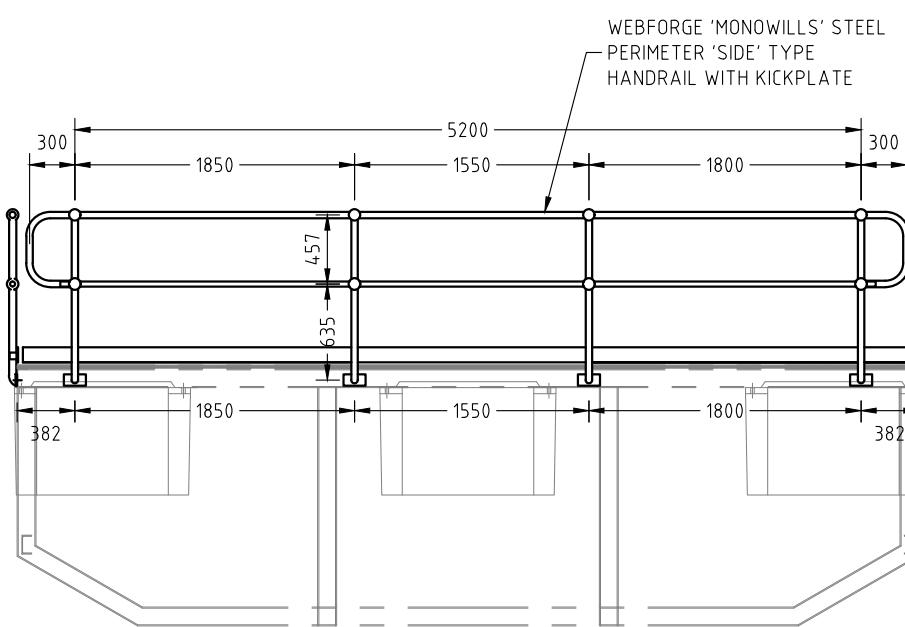

SECTION C-C SCALE 1 : 50


NOTE:

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**ELEVATION ON SELF
CLOSING GATE**

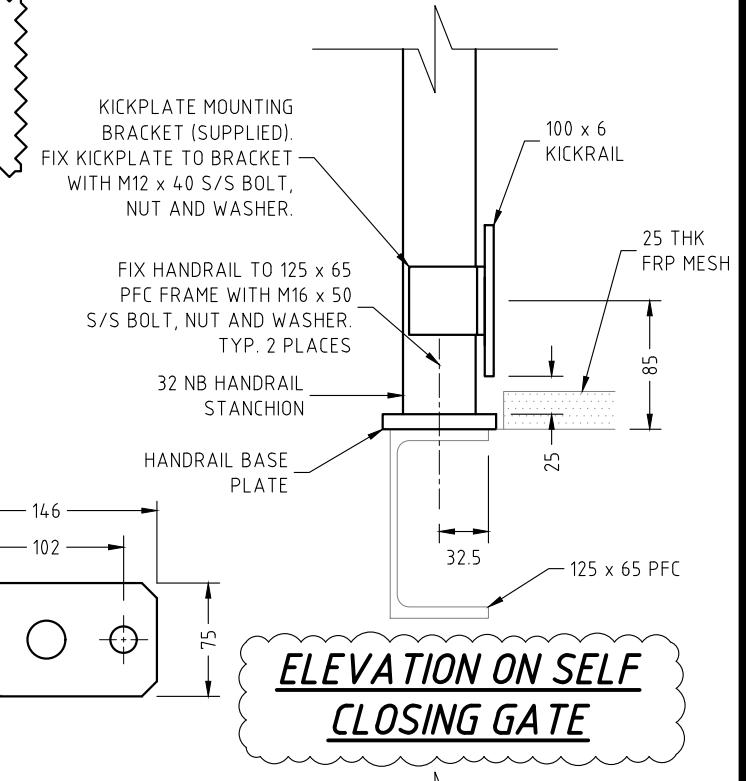BASE PLATE DETAIL



**ELEVATION ON TYP.
HANDRAIL**

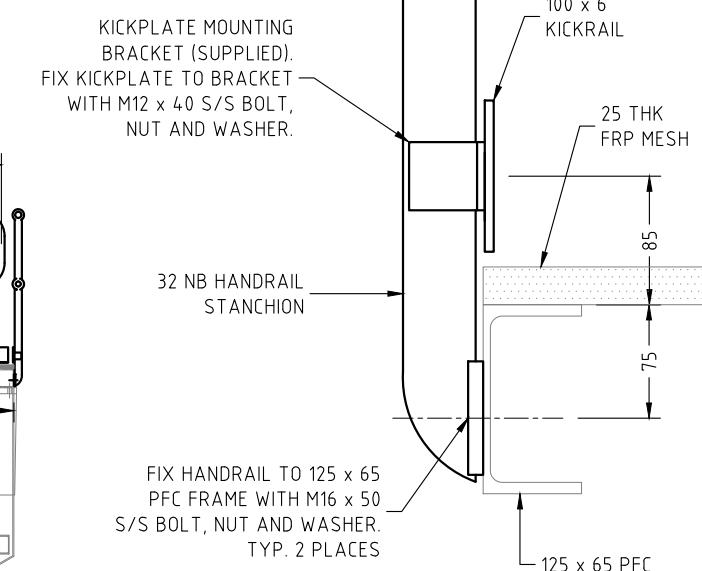TYPICAL FIXING DETAILS
SCALE 1 : 5

NO.	DATE	REVISION	DRAWN BY
A	27.10.2022	GATE TOP MOUNTED & POST POSITIONS CONFIRMED	S.D.

KK BEST COST-EFFECTIVE SOLUTIONS FOR BUILDINGS, BRIDGES AND MARINAS
K and K Consulting Engineers Pty Ltd
BTP (Brisbane Technology Park)
1 Quay Road, Eight Mile Plains, QLD 4113
Email: hp@knkengineers.com.au
Phone: (07) 3195 5692
Web: www.knkengineers.com.au

SUPERIOR
Mail Address: P.O. Box 202 Labrador 4215
Ph: (07) 5594 8200
Email: info@superiorjetties.com


DATE 06/06/2022
DRAWING NO. 19441-D14
REVISION NO. A

PROJECT PROPOSED PONTOON AND WALKWAY
DRG. TITLE PONTOON GENERAL ARRANGEMENT
CLIENT QAL
ADDRESS QAL WALKWAY
GLADSTONE
DRAWN BY S.D. DESIGNED M.W. CHECKED BY PAPER SIZE A3
SCALE AS NOTED

CERTIFIED
Himanshu Nalindrajith
Praveen Moragaspitiya
RPEQ: 16451

APPROVED


Name: Trudi Smith
Date: 2:53pm 28/08/2023

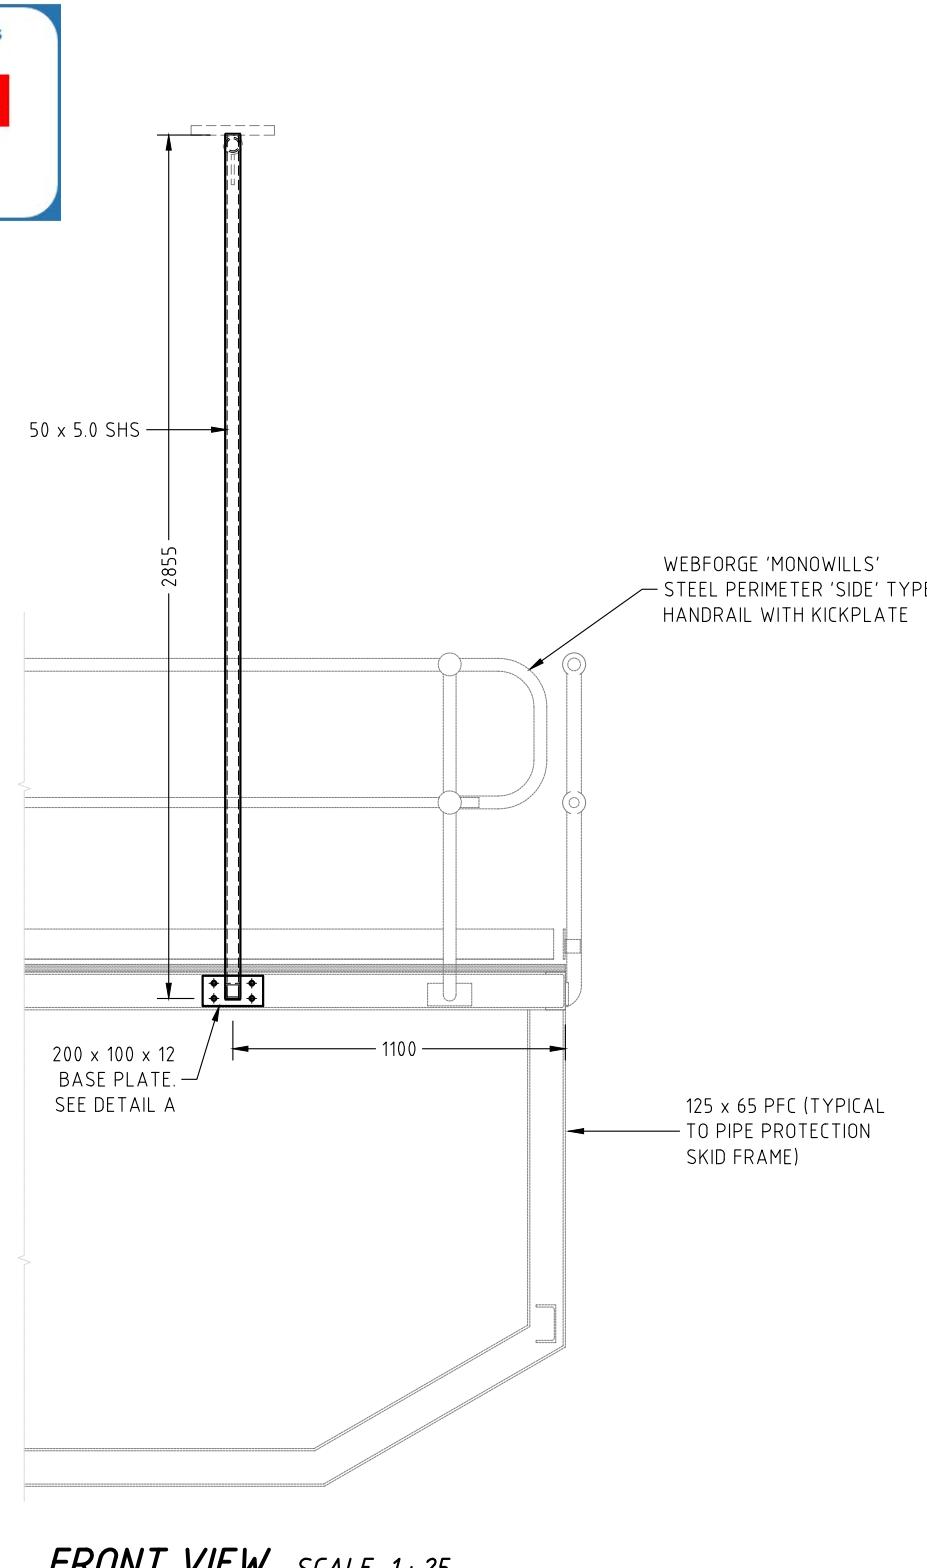

FRONT VIEW SCALE 1: 25


NOTE:

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- ALL DISSIMILAR METALS MUST BE SEPARATED USING ISOLATING WASHERS OR SLEEVES.
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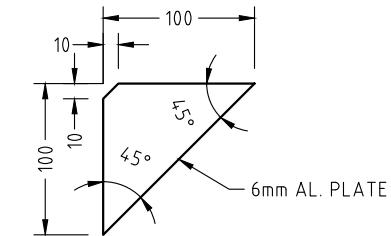


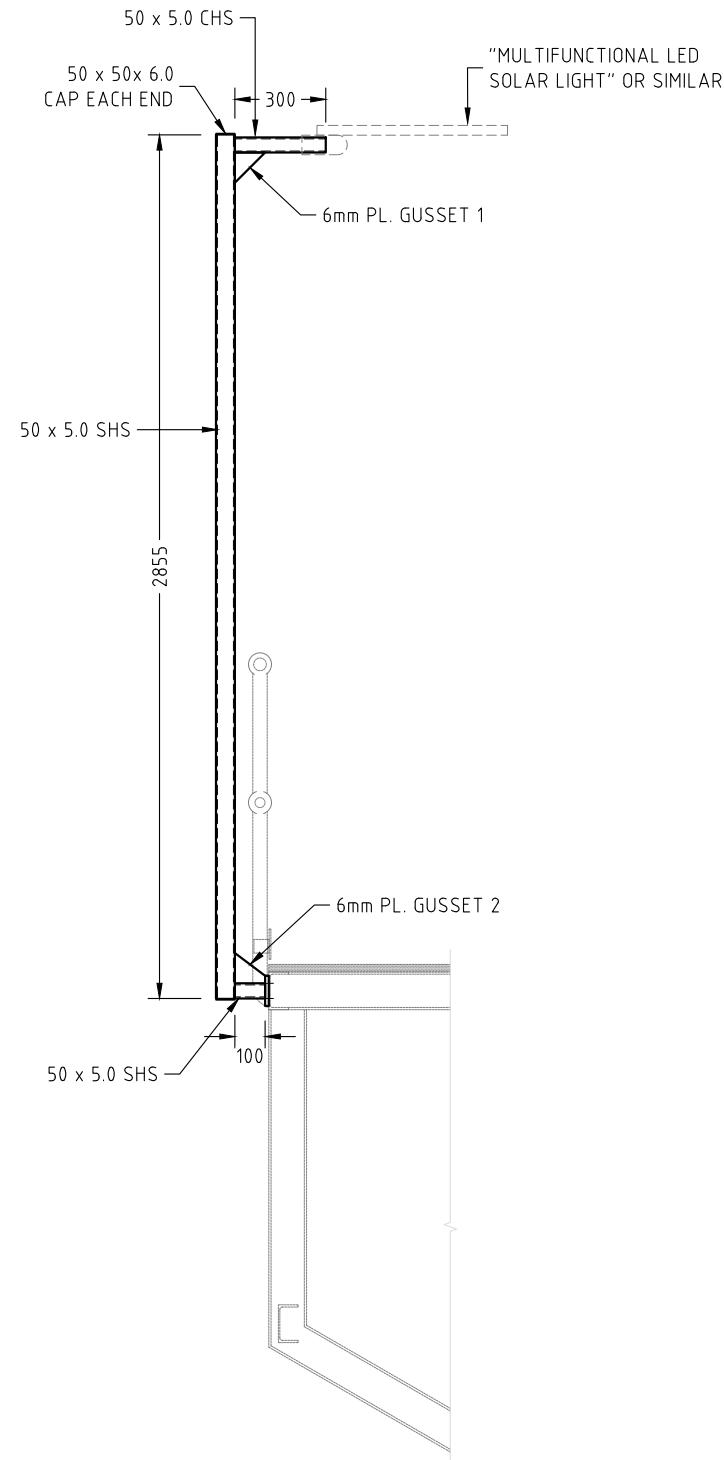SIDE VIEW SCALE 1: 25


1 ONLY REQUIRED

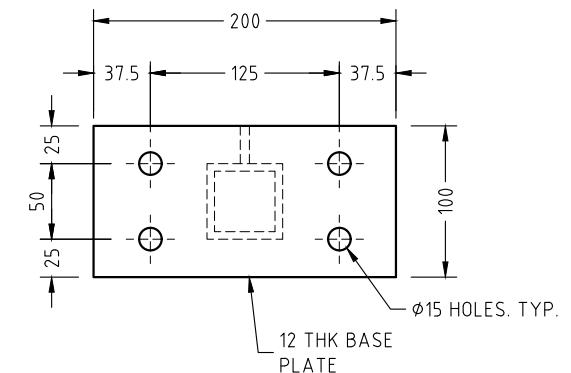

DETAIL - A SCALE 1: 5






6mm PLATE GUSSET 1 SCALE 1: 5

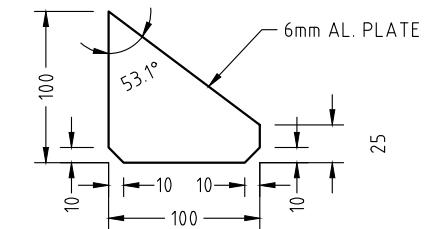



6mm PLATE GUSSET 2 SCALE 1: 5

NO.	DATE	REVISION	DRAWN BY

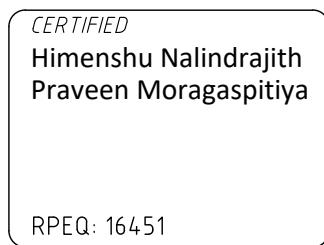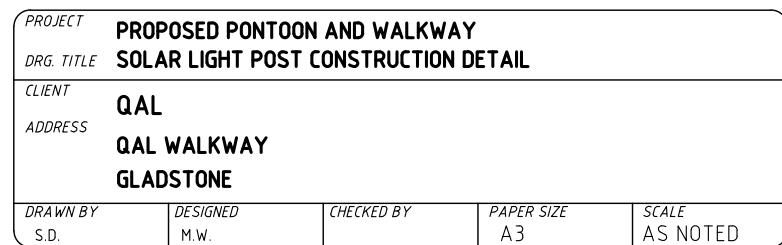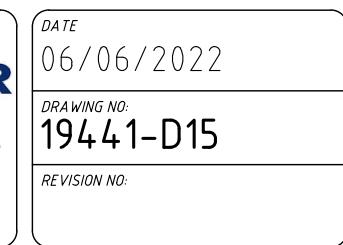




NOTE:

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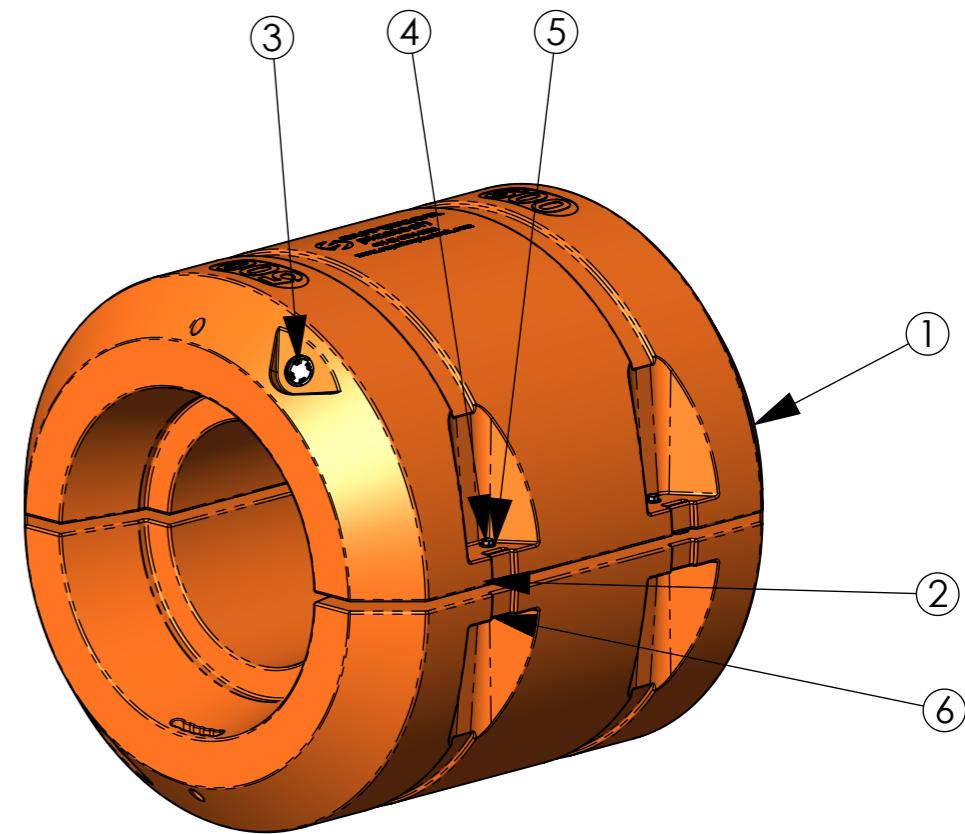
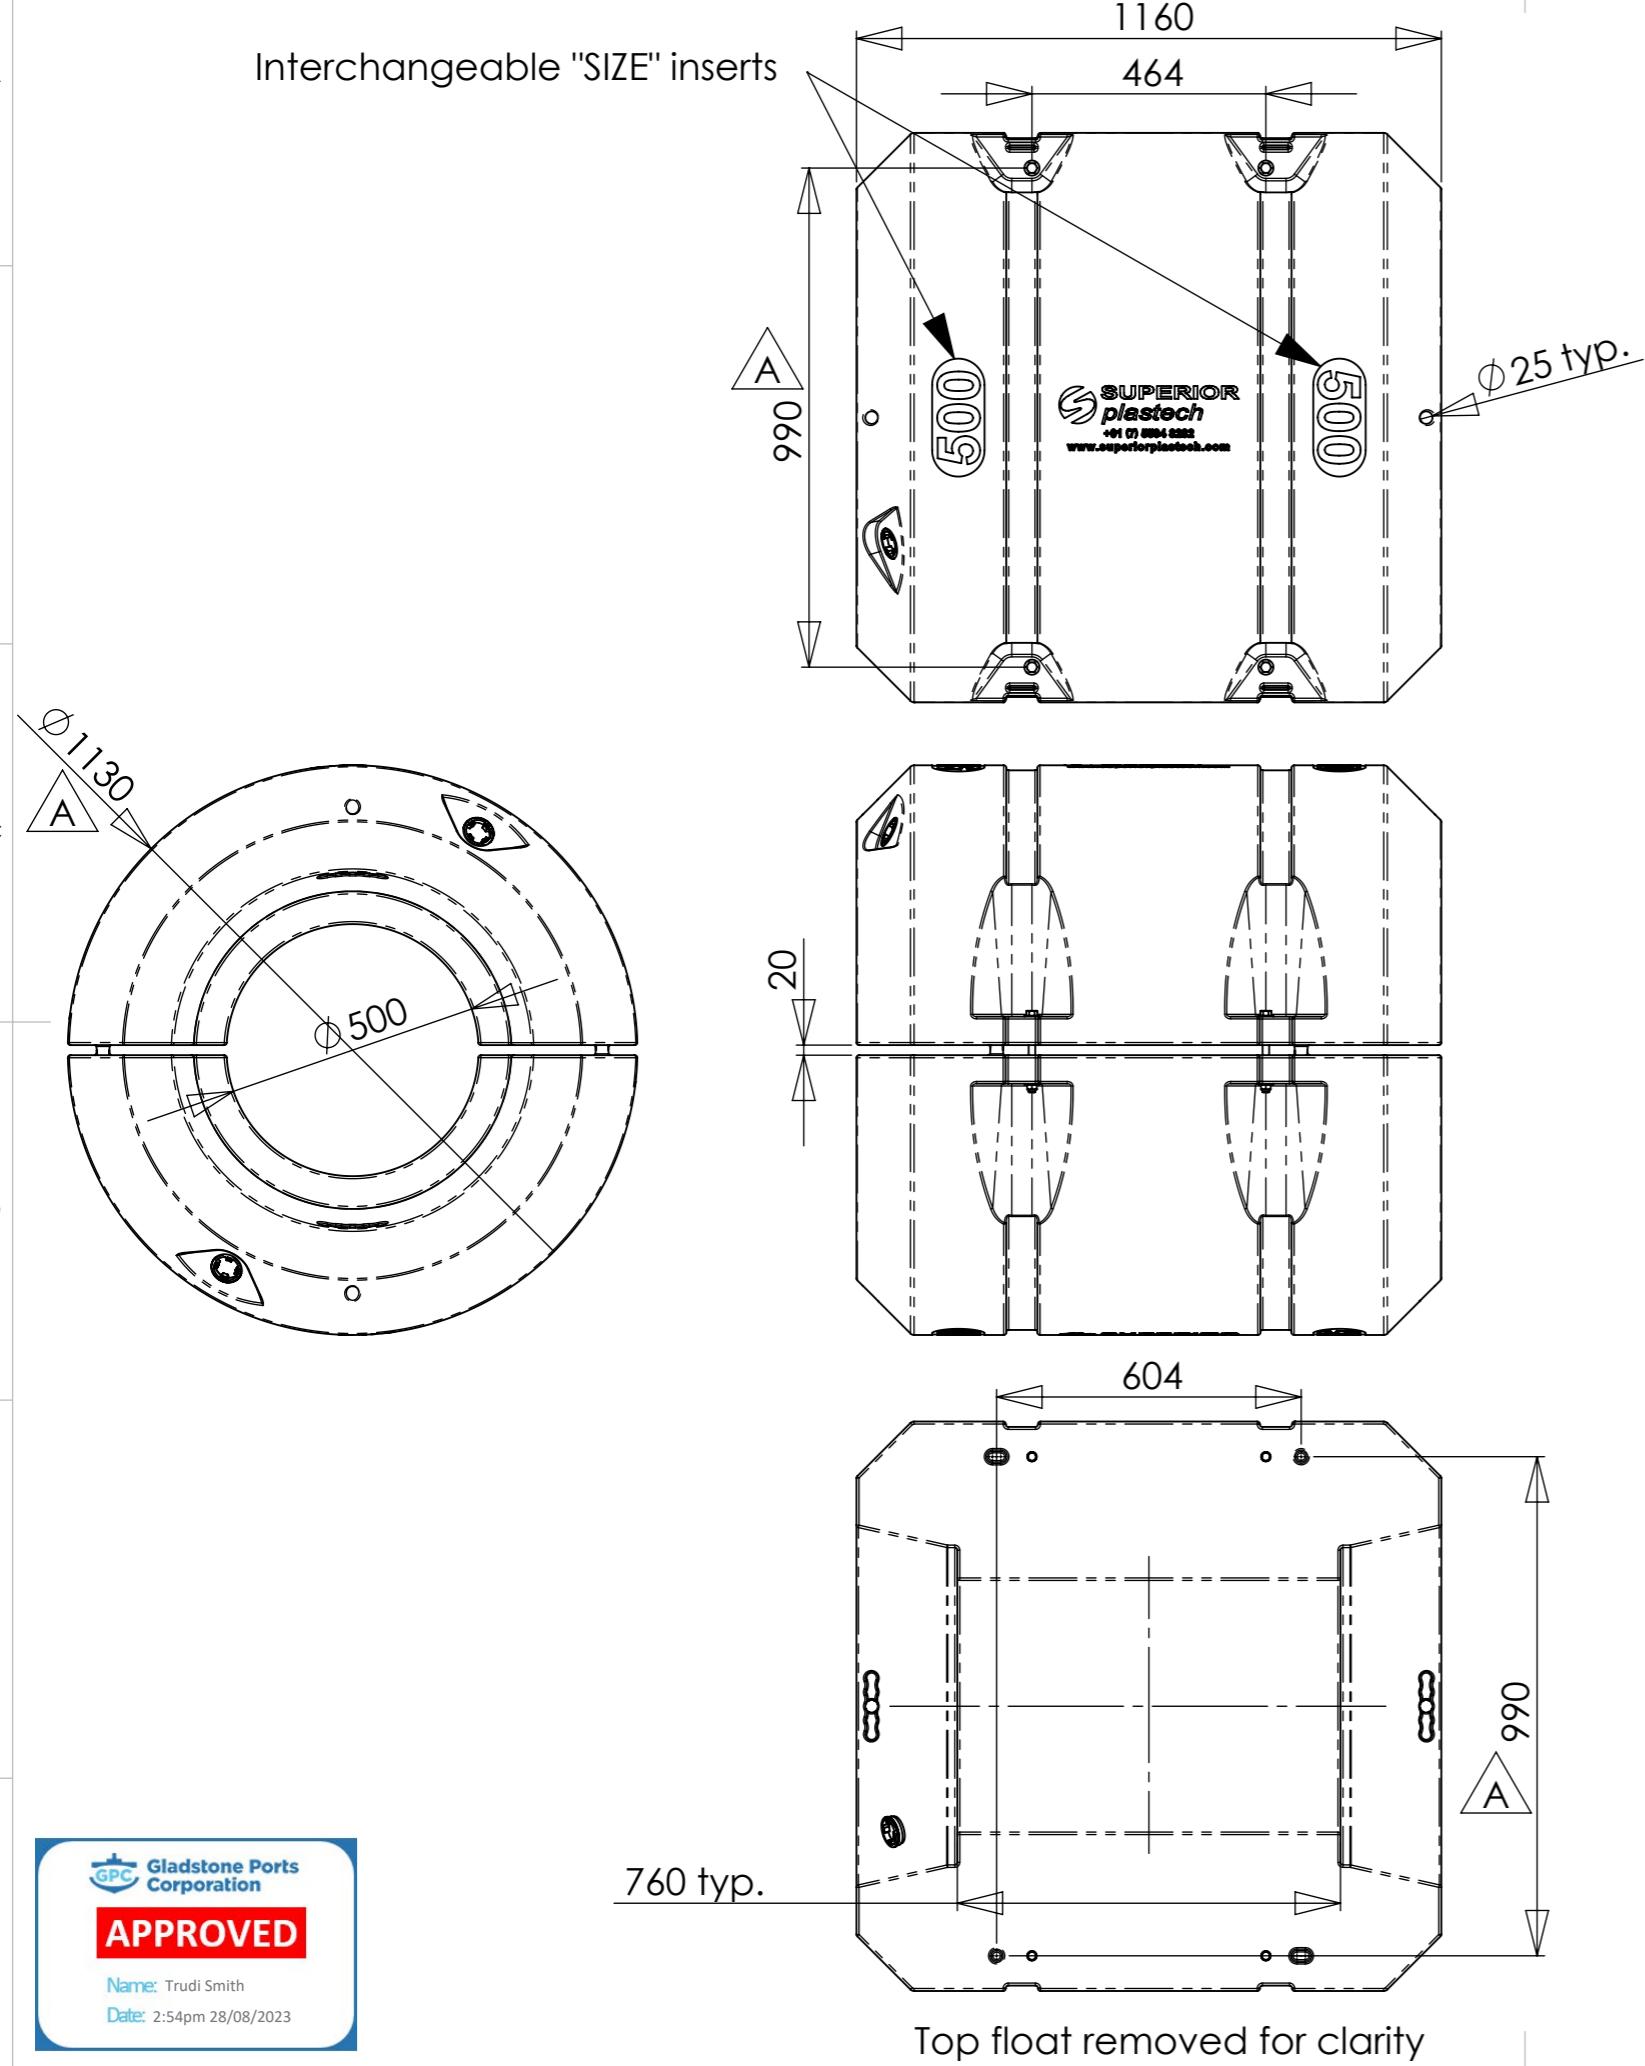
8 ONLY REQUIRED

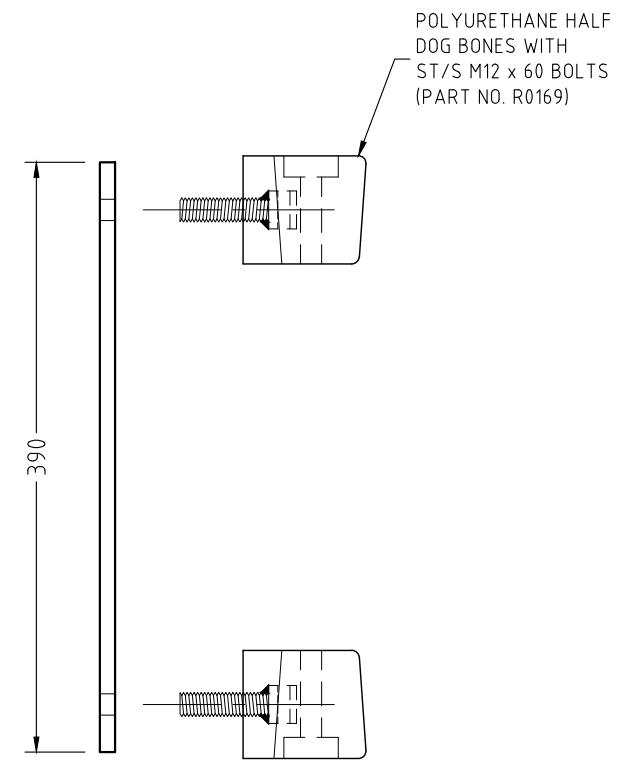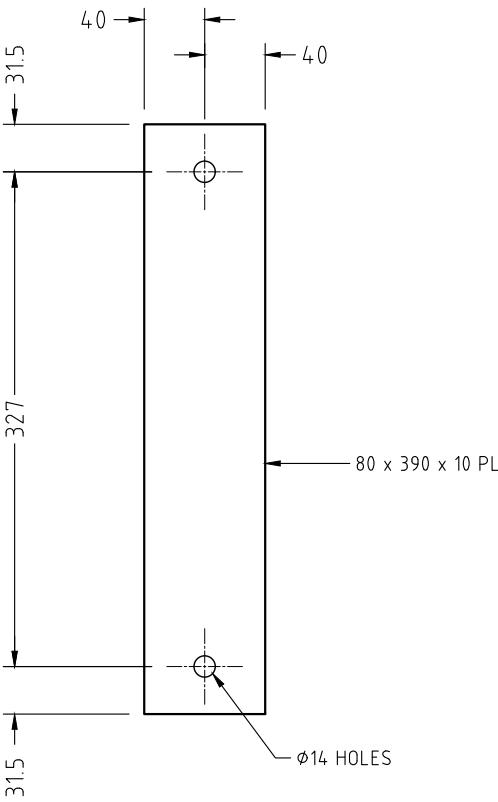NO.	DATE	REVISION	DRAWN BY



1	2	3	4	5	6	7	8		
A					ZONE	REV.	DESCRIPTION	DATE	APPROVED
					RFQ		RFQ issue	28-2-12	EHS
					A		Reduce OD, bolt holes & boss centers	29-5-12	EHS

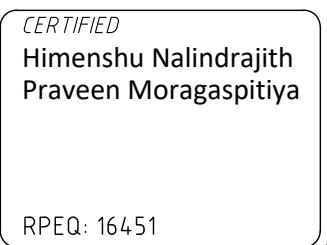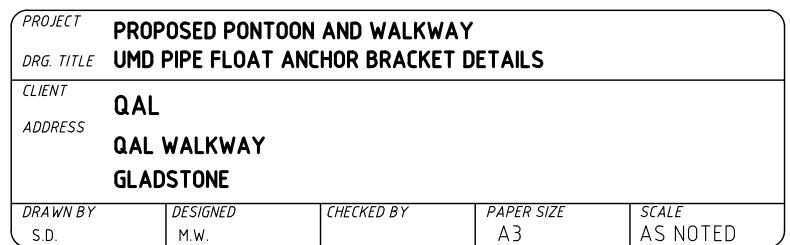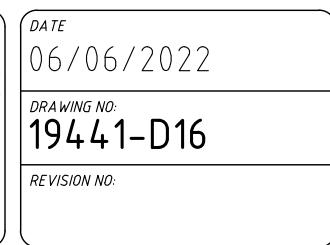Interchangeable "SIZE" inserts



Reserve Buoyancy = 729kg. (9mm wall thickness & total assembly weight of 71kg.)
Reserve Buoyancy = 720kg. (Total assembly weight of 80kg.)

ITEM NO.	DESCRIPTION	MATERIAL	PartNo	REVISION	QTY.
6	1/2" GALVANIZED NUT	AISI 1020		-	4
5	Washer 1/2" x 30 x 2	AISI 1020		-	8
4	1/2" x 150 GALVANIZED BOLT	AISI 1020		-	4
3	2in. Threaded Bung Assy.				2
2	PF Bolt Tubes	AISI 316 Annealed Stainless Steel Bar (SS)	19.05 x 1.6	draft	8
1	Pipe Float	PE Medium Density	500 mm	A	2

UNLESS OTHERWISE SPECIFIED: DIMENSIONS ARE IN MILLIMETERS SURFACE FINISH: Technical polish TOLERANCES: LINEAR: ± 0.2 mm ANGULAR: $\pm 0.5^\circ$	FINISH:	NO SHARP EDGES OR CORNERS	DO NOT SCALE DRAWING	REVISION A
DRAWN	NAME Manny	SIGNATURE	DATE	
CHK'D				TITLE:
APP'D				ai engineering pty. ltd.
MFG				
Q.A.				
	COLOUR:	MATERIAL:	DWG NO.	
			500 mm	A3
	WEIGHT: 70990.39 gr.	SCALE: 1:15		SHEET 1 OF 1